

PLANNING AND ZONING COMMISSION (P&Z) SKETCH PLAN REVIEW APPLICATION

ALL ITEMS ON THIS APPLICATION MUST BE COMPLETED.

Application Fee: \$500.00 Per Fee Schedule

		/, c/o Aaron L. Underhill, Esq.		
Address/City/State/Zip:	Underhill & Hodg	e LLC, 8000 Walton Parkway, Suite 2	260, Nev	v Albany, OH 43054
	@uhlawfirm.com			
Phone No: 614.335	.9320	Cell Phone No: 614.783.1149	Fax No:	614.335.9329
Property Owner: The	State of Ohio, c/	o Aaron L. Underhill, Esq.		
Address/City/State/Zip:	Underhill & Hodg	e LLC, 8000 Walton Parkway, Suite 2	60, New	Albany, OH 43054
	@uhlawfirm.com			
Phone No: 614.335	.9320	Cell Phone No: 614.783.1149	Fax No:	614.335.9329
	Applicant: DLR Gro			
Address/City/State/Zip:	Attn: Bryce Shirle	ey, 1422 Euclid Avenue, Suite 300, Cl	eveland,	OH 44115
	ey@dlrgroup.com			
Phone No: 216.623	.7814	Cell Phone No:	Fax No:	
		Boulevard, Powell, OH 43065		
		Existing Use: Vacant	Proposed	Use:
Reason for Administrativ	e Review (attach necessa	ary documents):		
	iew of a site plan rea A of the appr	for Phase I of an ambulatory care m oved zoning	edical fa	acility. The plan

Checklist:

- Sketch Plan requirements set forth in Section <u>1109.06</u>
- □ Provide any other information that may be useful to the Planning and Zoning Commission or City Staff in the space
 - below or attach additional pages.
- □ Attach 5 copies containing all drawings, text, any other items, and application.
- □ 1 digital copy (CD, USB, Email) of the complete application packet.
- □ Attach the required fee \$500.00
- Post a public notice sign at least (10) days prior to a public hearing or public meeting, pursuant to ordinance 1107.035.

Public notice sign details found here.

(See Over)


I agree to grant the City Staff, the Commission, Board or Council considering this application access to the property that is the subject of this application for the purposes of reviewing this application and posting public notice for this application.

e of Applicant: <u>By:</u> Aavon L	. Undernill, Att	ornen	Date: 10-21-202
Office Use		Office Use	
		Type/Date: _	
		Base Fee: _	\$500.00
		Prepared by: _	
Dessived		Reviewed by: _	
Received		PAYOR: _	
		RECIEPT # _	

City of Powell · 47 Hall Street · Powell, Ohio 43065 · (614) 885-5380 · (614) 885-5339 fax · www.cityofpowell.us





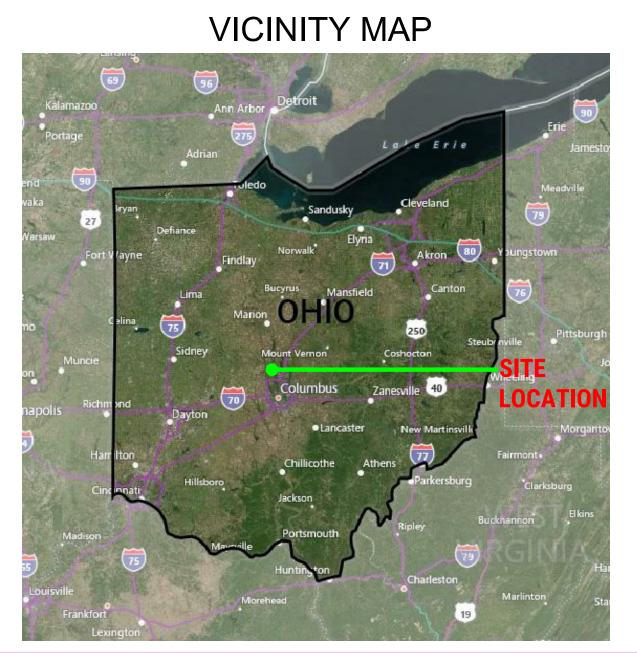



PROJECT NUMBER OSU-220880

OSU WMC Outpatient Care Powell

SAWMILL PARKWAY POWELL, OHIO

PREPARED FOR THE OHIO STATE UNIVERSITY **FACILITIES OPERATIONS AND DEVELOPMENT**

Facilities Design and Construction COLUMBUS, OHIO



PREPARED BY



250 WEST ST, SUITE 150 COLUMBUS, OH 43215 (614) 230-4131

MKSK LANDSCAPE ARCHITECT

462 SOUTH LUDLOW ALLEY COLUMBUS, OH 43215 (614) 621-2796

DLR GROUP STRUCTURAL ENGINEER

1422 EUCLID AVENUE, SUITE 300 CLEVELAND, OH 44115 (216) 522-1350


DLR GROUP **MEPIT ENGINEERS** 1422 EUCLID AVENUE, SUITE 300 CLEVELAND, OH 44115 (216) 522-1350

SHEET INDEX

COVER SHEET	A1
EXISTING CONDITIONS SURVEY	A2
SITE PLAN	A3
BUILDING ELEVATIONS	A4
BUILDING ELEVATIONS	A5
FACADE COMPOSITION & MATERIALS	A6
MASTER DRAINAGE PLAN	A7



PROJECT NUMBER	PROJECT NAME	PROJECT PHASE
OSU-220880	OSU WMC OUTPATIENT CARE - POWELL	SKETCH PLAN
FD&C PM	PRIMARY ASSOCIATE	ISSUE DATE
GEORGE RICE	DLR GROUP	10/21/2022

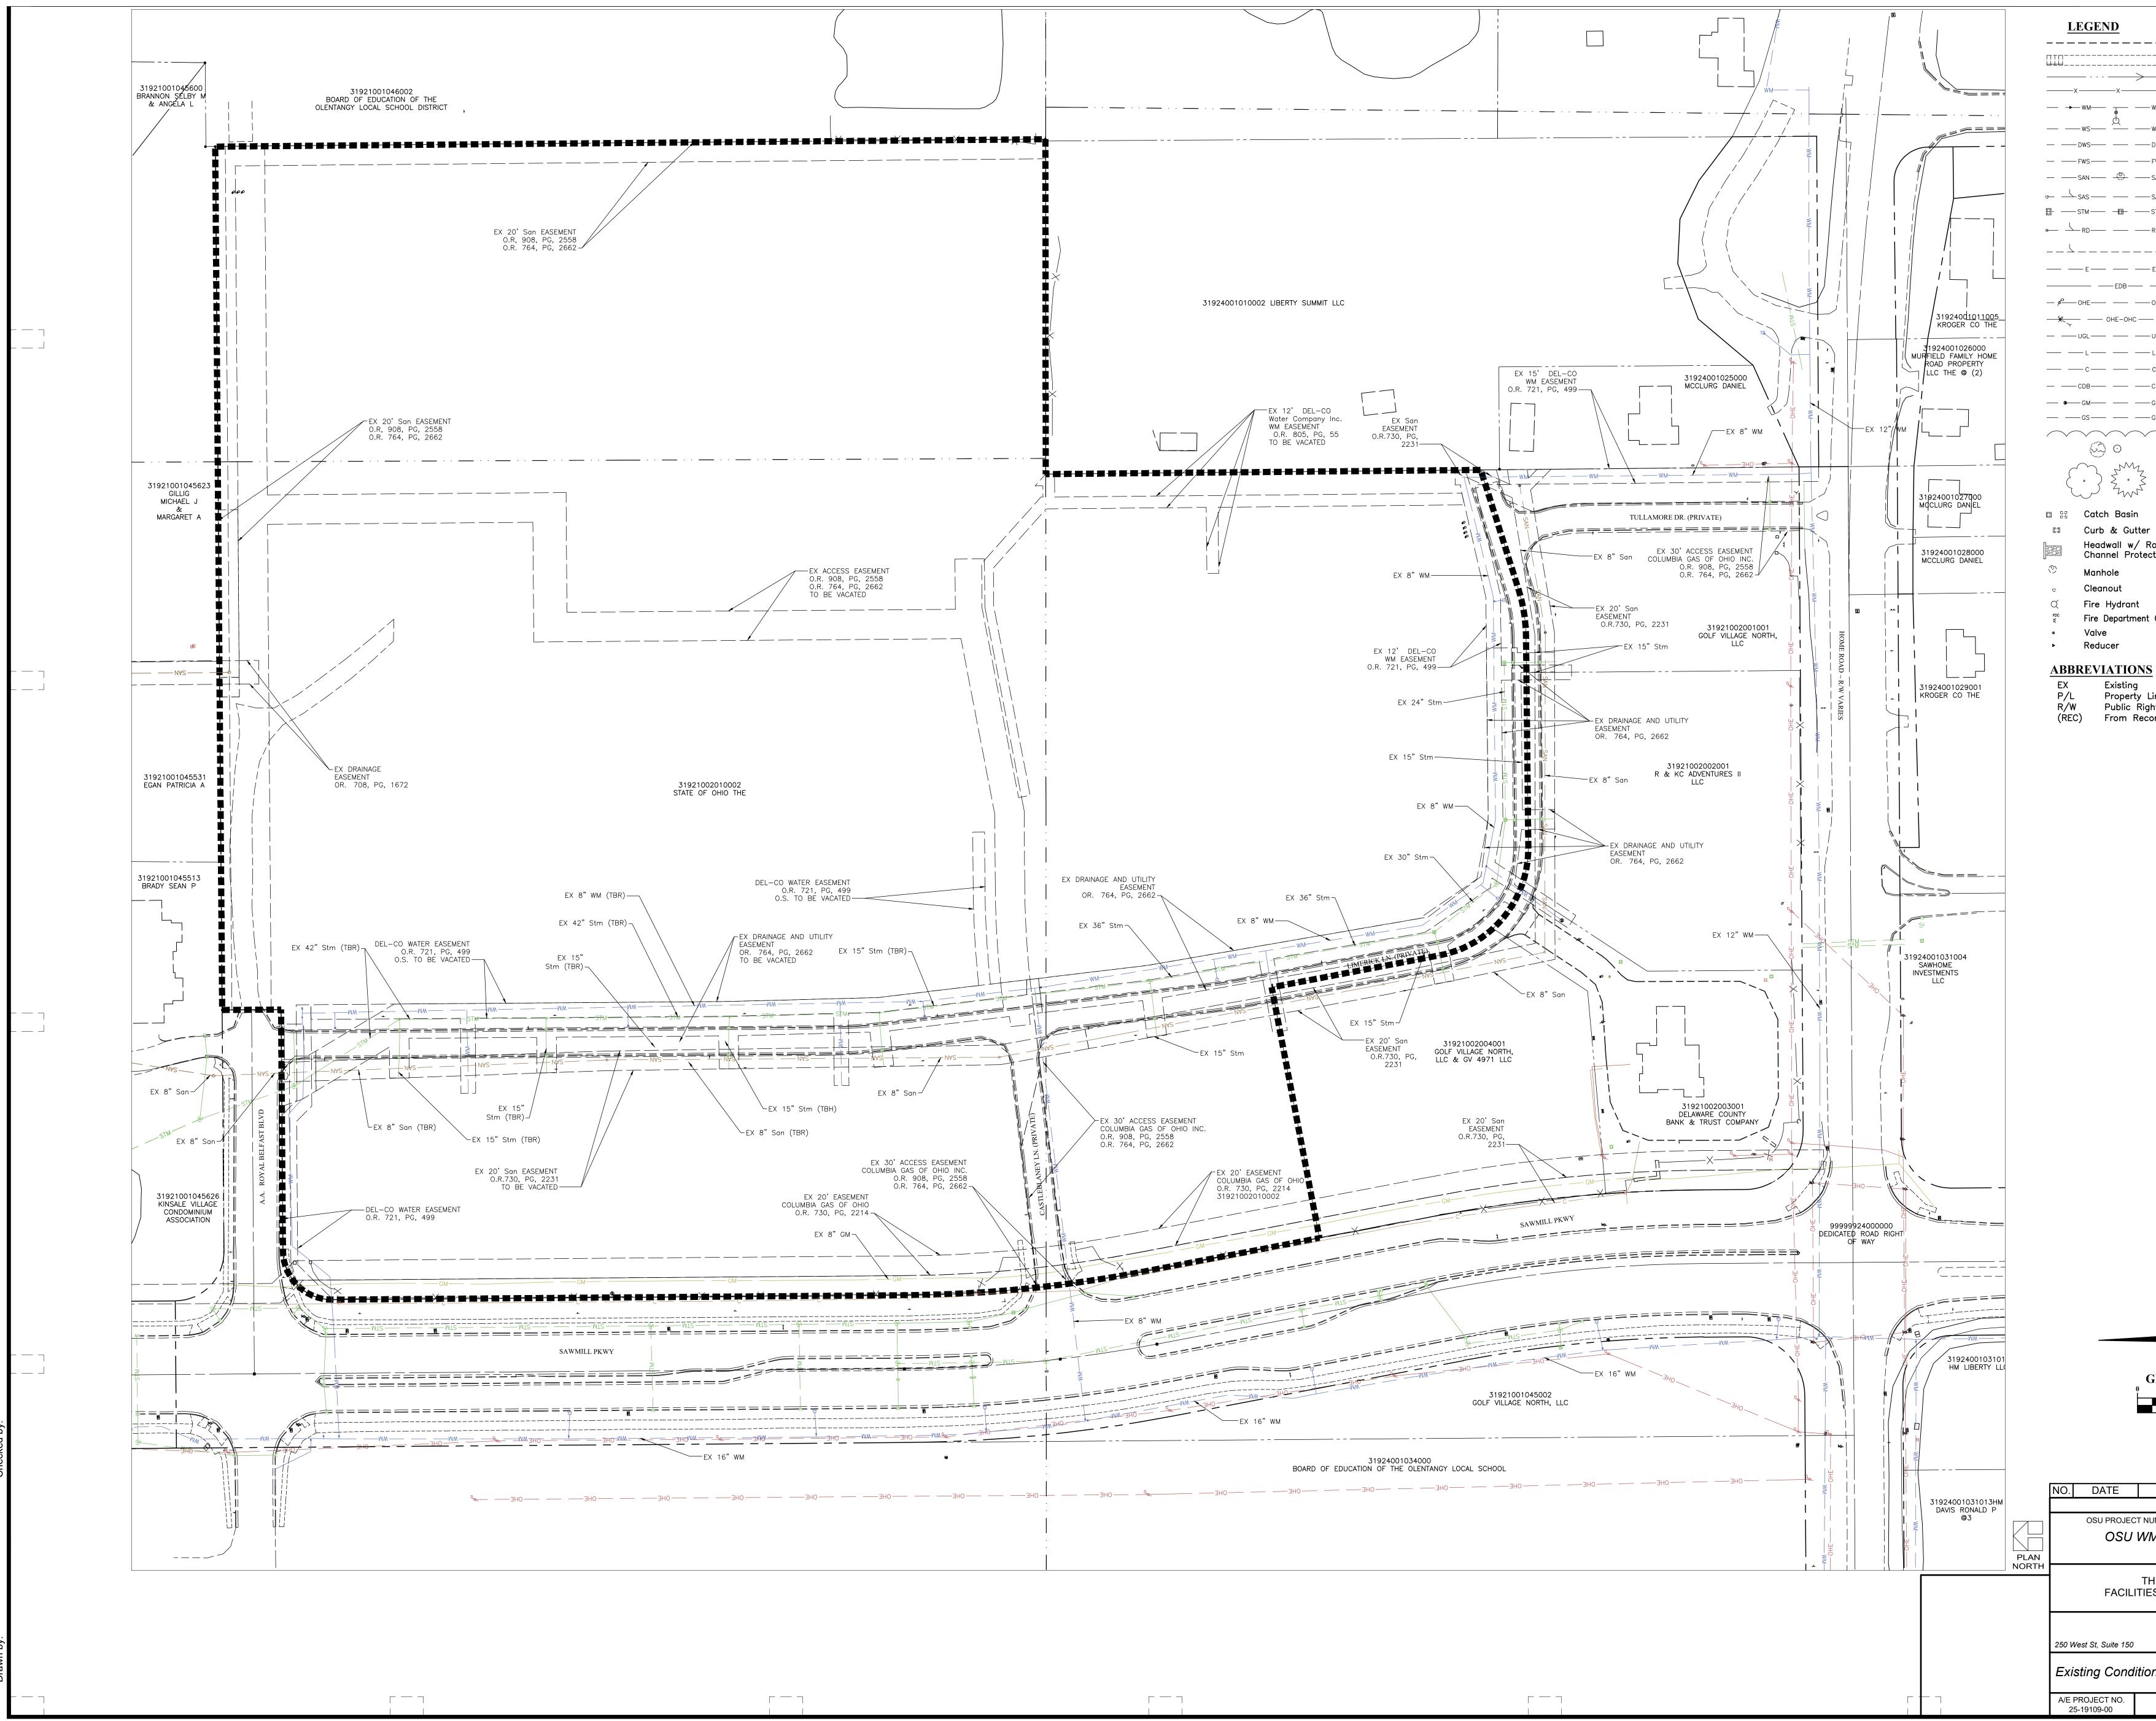

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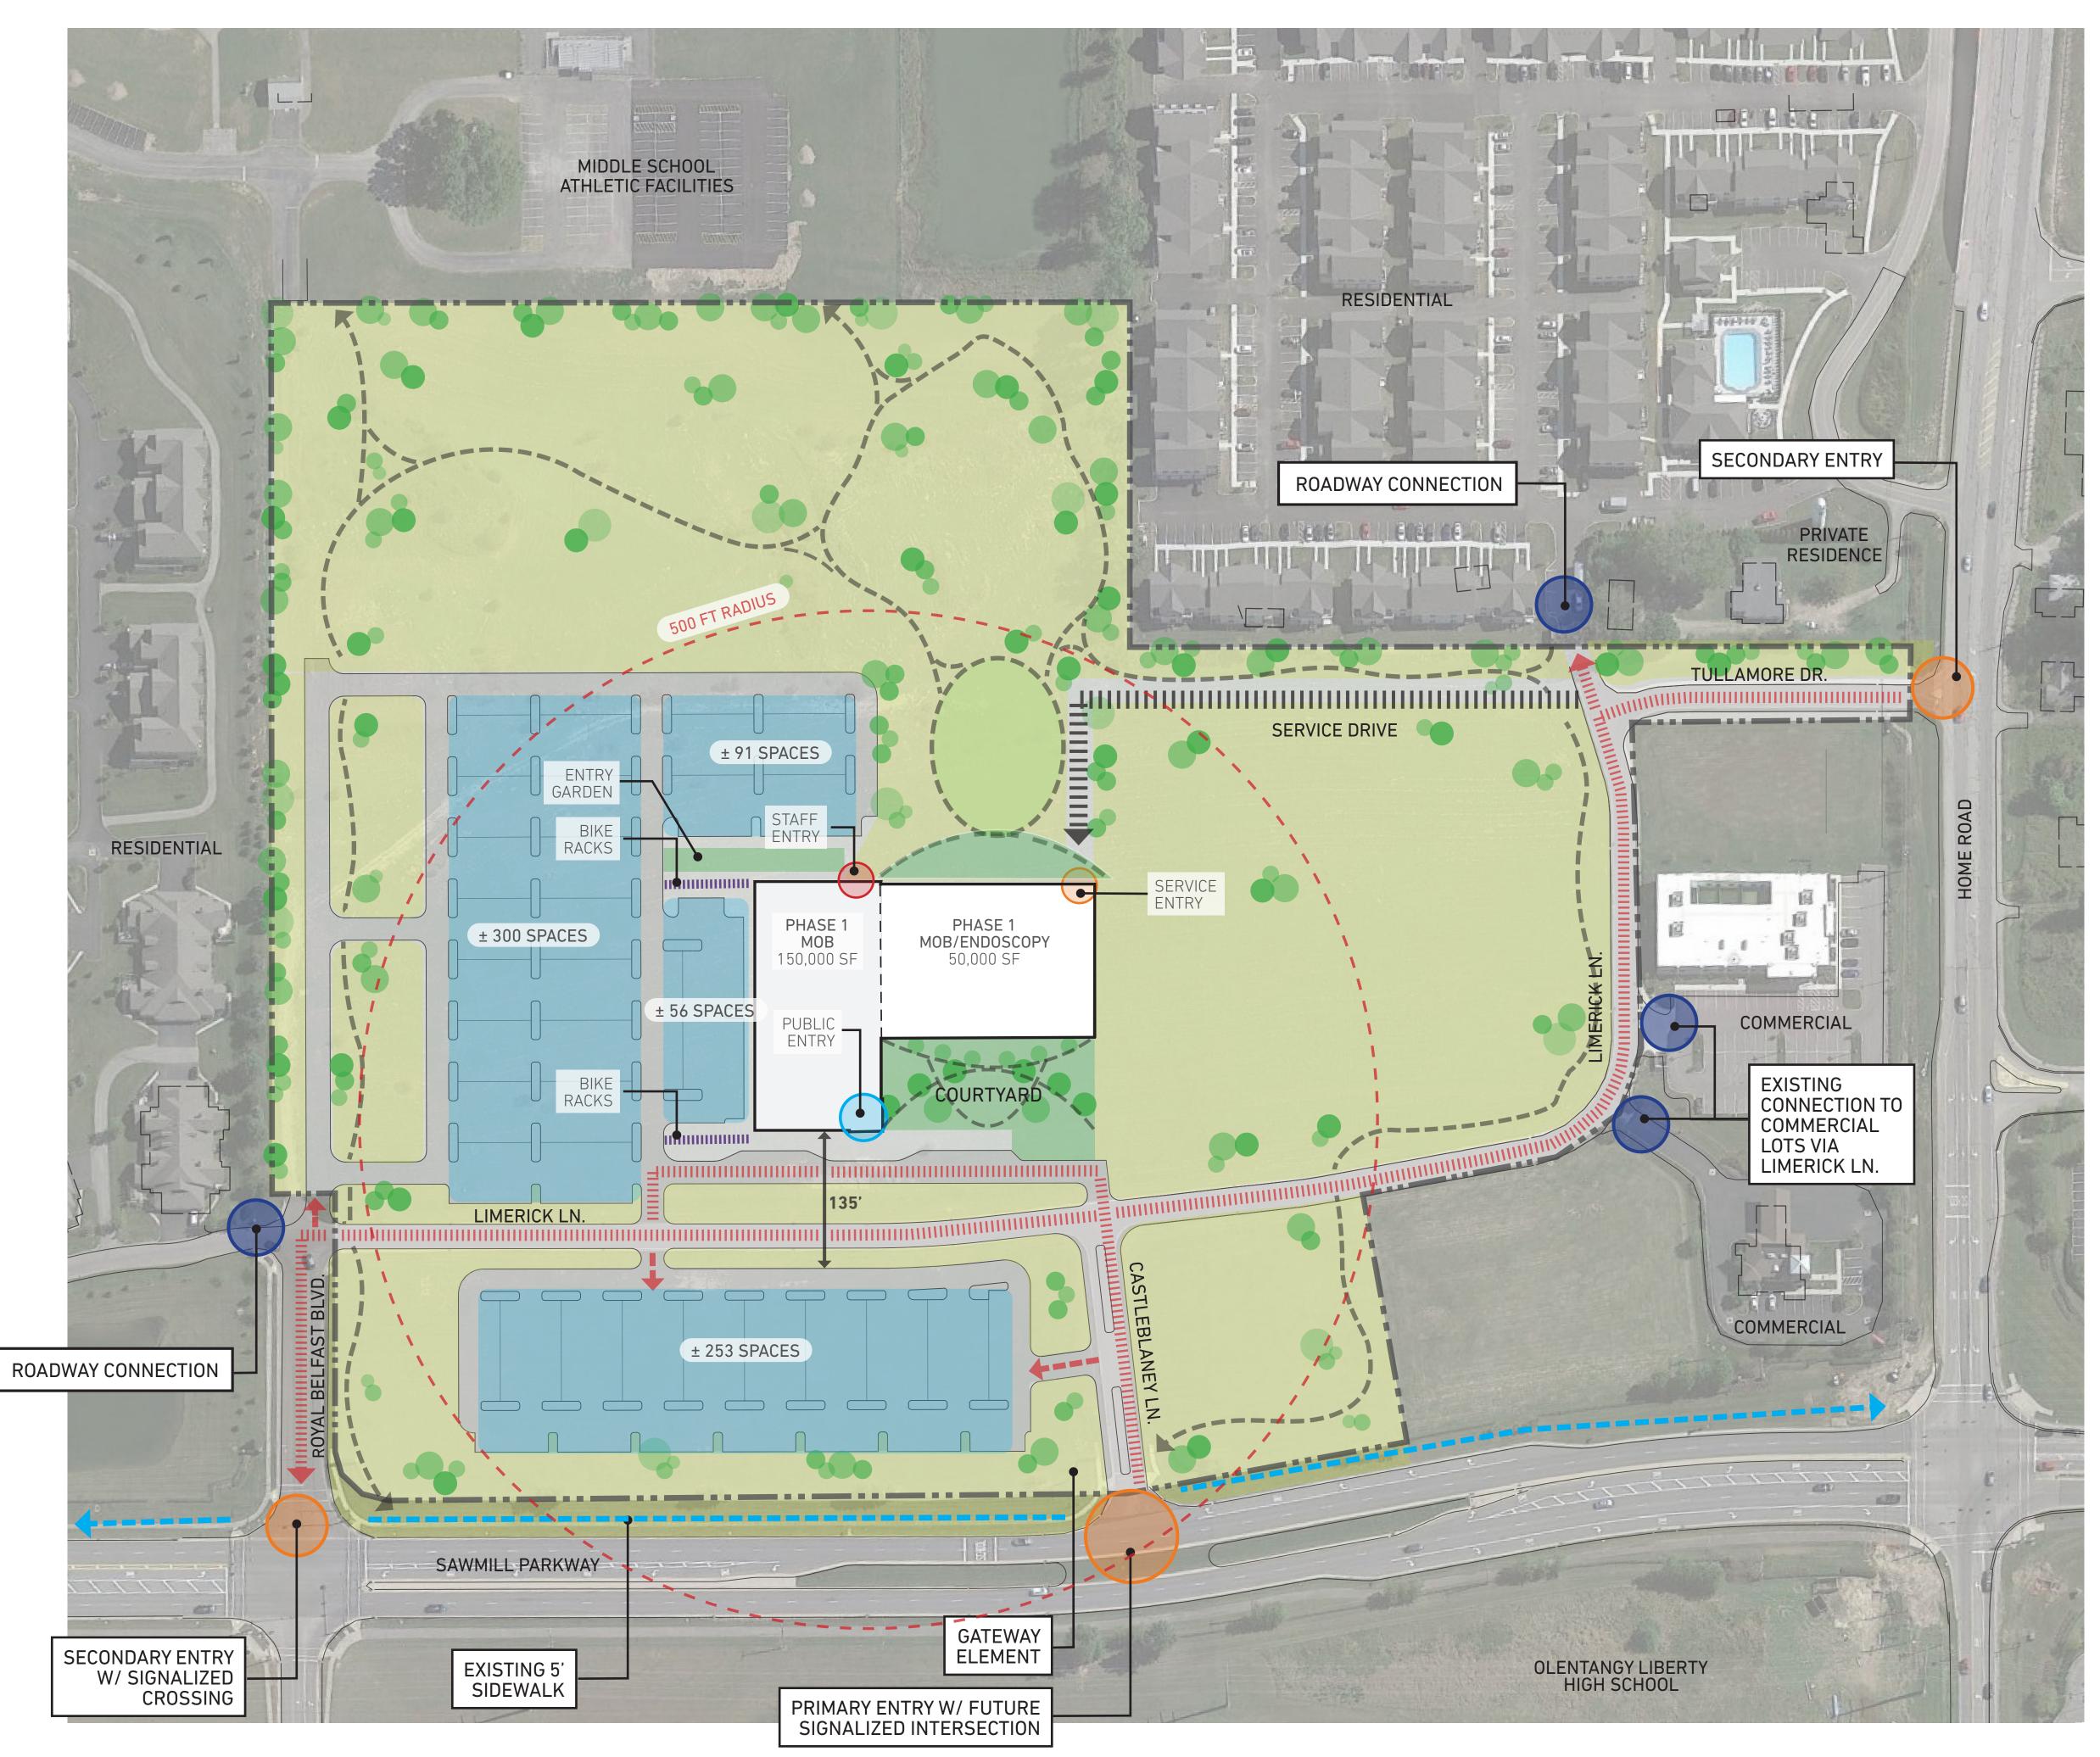
Property Line Public Right-of-Way (REC) From Record Plan

= = = = =	Curb
·---┬┬줃╡ ·---┴┴ᠽ╡	Sidewalk/Curb Ramp
	Center Line Swale
—X———	Fence/Handrail
WM	Water Main
WS	Water Service
DWS	Domestic Water Service
FWS	Fire Water Service
SAN — —	Sanitary Sewer Main
SAS — — —	Sanitary Sewer Service
STM —	Storm Sewer
RD	Roof Drain
	Underdrain
E	Underground Electric Service
	Electric Duct Bank
оне—— —	Overhead Electric
	Overhead Electric & Communications
UGL	Underground Street Lighting
L	Private Site Lighting
c	Communications Service
CDB	Communications Duct Bank
GM	Natural Gas Main
	Natural Gas Service
\sim	Tree Row
	Ornamental Tree/Shrub
	Deciduous/Evergreen Tree
	Detectable Warning Plate
Inlet _	
lock	
ction	 Handicap Pavement Symbol Bollard
þ	⇔ Light Pole
_	□ Transformer
Connection	

Gas Meter

Pull Box

	GRAPHIC SC 0 30 60 1 inch = 60 fee	120			
DATE		DESCRIPTION			
	REVISI	ONS			
OSU PROJEC	T NUMBER OSU-	220880			
OSU	WMC Outpatie	ent Care Powel	Ι		
FACIL	PREPARE THE OHIO STAT ITIES OPERATION COLUMBL	E UNIVERSITY	MENT		
	PREPARE	D BY			
	DLR Gr	oup			
est St, Suite 150		COLUMBUS	S, OHIO 43215		
ting Conditions Survey A2					
ROJECT NO.	FILE NAME	DRAWN BY	DATE		



0 80' 160'


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OSU PROJEC	REVIS T NUMBER OSU	SIONS J-220880		
	PREPAR THE OHIO STA	ED FOR	-γ	
FACILI	TIES OPERATIO	ON AND DEVEL BUS, OHIO		
West St, Suite 150				3215 NUMBER
te Plan			A3	



0 5 10 SCALE: 3/32" = 1'=0"





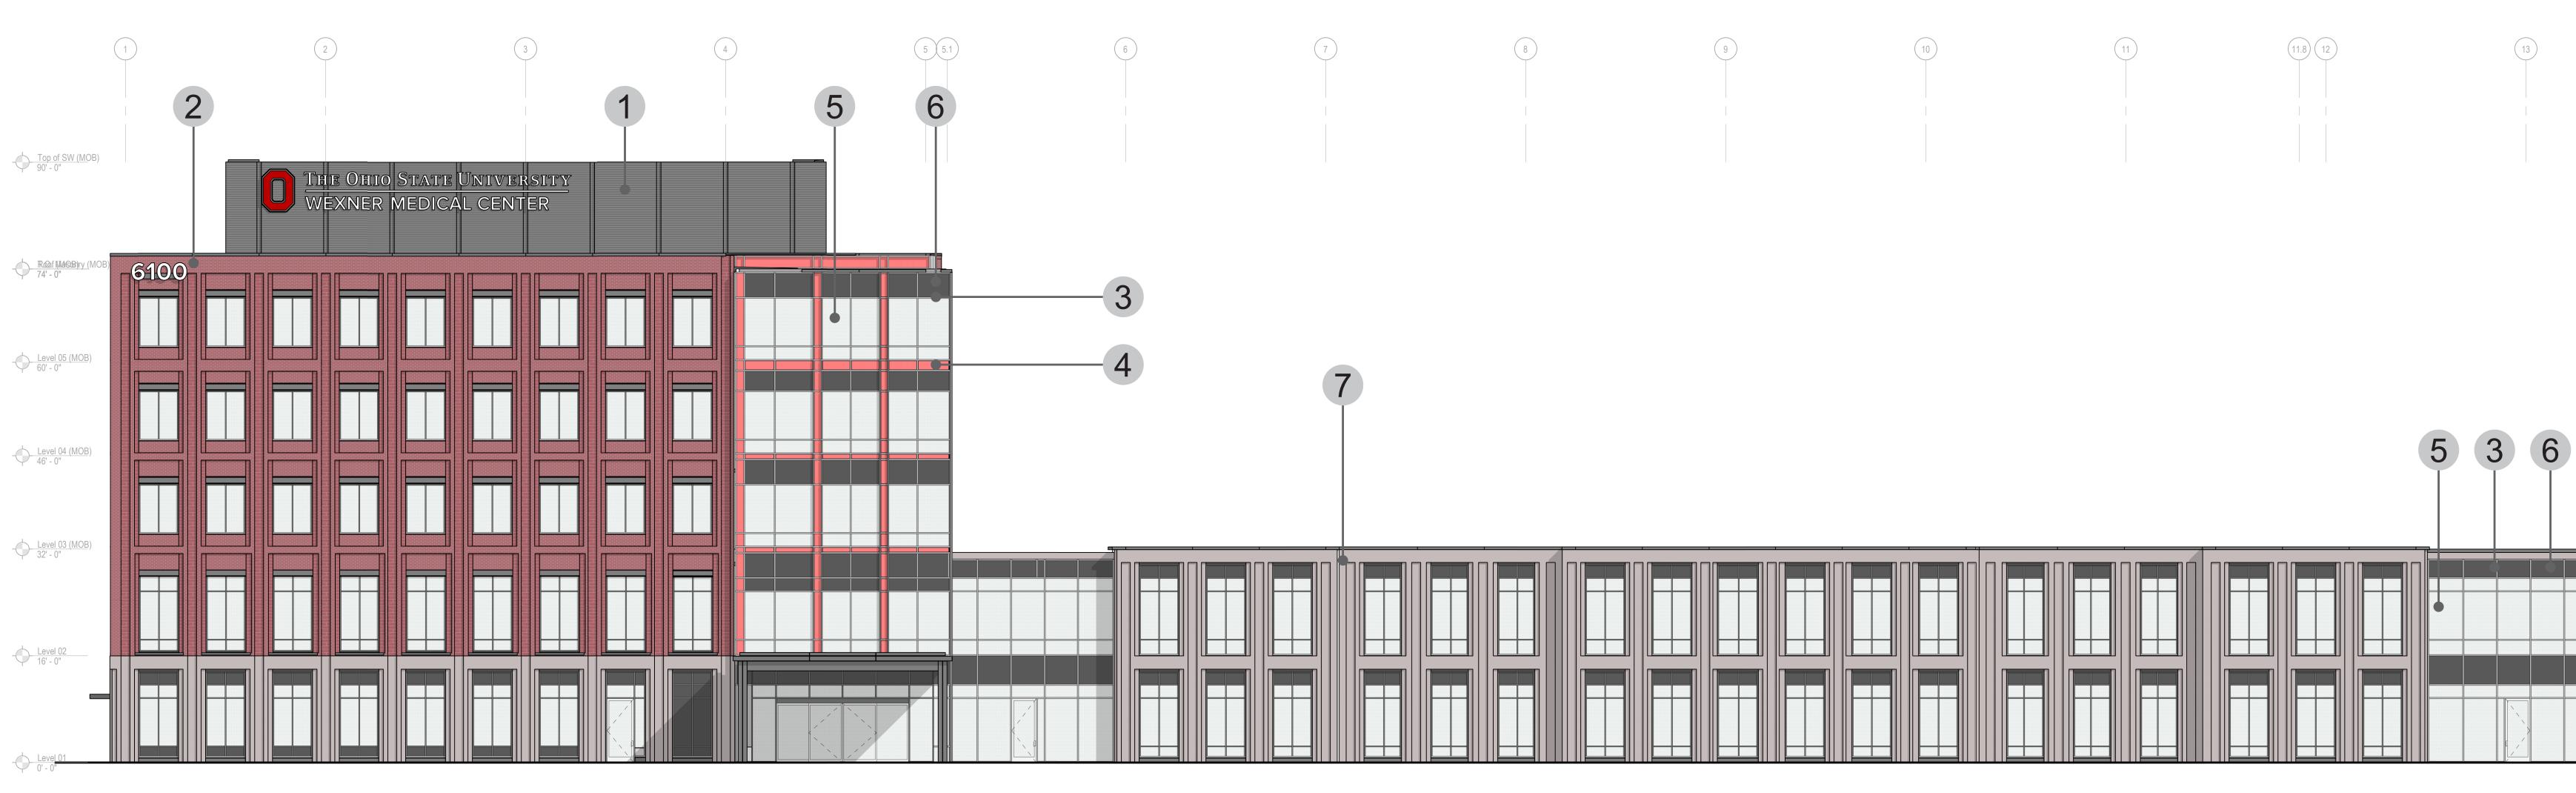

		5		$\underline{Level 04} (PH2 Hospital)}{48' - 0''} \qquad $	
2. BRIC 3. ALUM 4. ALUM 5. INSU 6. SPAN	FILED METAL PANE X MASONRY INUM 1 - CURTAIN INUM 2 - INFILL PA LATED LOW-E GLAZ DREL GLAZING CAST CONCRETE PA	WALL MULLIO NELS ZING	NS	OSU PROJECT NUMBER OSU WMC OUT PF THE OHIO FACILITIES OPER COL	DESCRIPTION EVISIONS OSU-220880 tpatient Care Powell REPARED FOR STATE UNIVERSITY ATION AND DEVELOPMENT UMBUS, OHIO REPARED BY R Group COLUMBUS, OHIO 43215 SHEET NUMBER A4 ME DRAWN BY DATE 21 October, 2022

Level 02 16' - 0" - 0 - 0 SOUTH ELEVATION SCALE: 3/32" = 1'-0" 0 5 10 SCALE: 3/32" = 1'=0"

3 5 - Level 05 (MOB) _____ 6 - Level 04 (MOB) _____ 4 Level 03 (MOB) 32' - 0"

A

EAST ELEVATION SCALE: 3/32" = 1'-0"

14






- 5. INSULATED LOW-E GLAZING
- 6. SPANDREL GLAZING
- 7. PRECAST CONCRETE PANELS

2		1	
		T <u>op of SW (M</u> 90'	<u>DB)</u> - 0"
	61	OO	<u>DB)</u> - 0"
		Level 05 (M(60'	DB) - 0"
		Level 04 (M0 46'	<u>DB)</u> - 0"
		Level 03 (M0 32'	DB) - 0"
		Level	02-0"-
		Level 0'	01 - 0"
<u>Ro</u> of 9	(<u>PH2)</u> 0' - 0"		
<u>Level 06 (</u> PH <u>2 H</u> o. 7	spital) 6' - 0"		
<u>Level 05 (</u> PH <u>2 H</u> o	spital) 2' - 0"		
6	- • T		
<u>Level 04 (PH2 H</u> o 4	spital) 8' - 0"		
<u>Level 03 (</u> PH <u>2 H</u> o: 3			
<u>Level 02 (PH2 H</u> o: 1	-7		
1	6' - 0"		
0 <u>1 L</u> E	VEL 1 0' - 0"		
NO. DATE	REVIS	DESCRIPTION	
OSU PROJEC	T NUMBER OSU	220880 ent Care Powel	1
FACILI	PREPARE THE OHIO STAT TIES OPERATIO COLUMB	TE UNIVERSITY	MENT
250 West St, Suite 150	PREPARE DLR Gr	ер вү 'ОИР	S, OHIO 43215
BUILDING ELE	VATIONS FILE NAME	DRAWN BY	SHEET NUMBER A5 DATE
A/E PROJECT NO. 25-19109-00		SF	

EXTERIOR MATERIALS SCHEDULE OSU WMC Regional Ambulatory Facility OSU-180636

Material	Description	Comments
Window Wall System to punched openings	<i>Kawneer</i> Metro View FG 501 T or FG 601 T window wall or equivalent approved by Architect.	Glazing: see below Finish: <i>PPG</i> UC106693F Duranar Suns Window wall system will incorprate pro Back of spandrel glazing will be insulat
Curtain Wall System to façade corners, connectors	<i>Kawneer</i> 1600 System or equivalent approved by Architect.	Projecting decorative architectural face elsewhere System will incorporate vertical alumin to CW base Back of spandrel glazing will be insulat Glazing: see below Finish (Mullions, Sill, Head, Coping): <i>PF</i> Finish (Curtainwall Metal Panel Infill): F
Glazing	Vision Triple silver coating low-e IGU Required performance: VLT: 62% UV: 5% REFL (out): 10% REFL (in): 10% U-value (W): 0.29 U-value (S): 0.26 SHGC: 0.29	Basis of design: <i>Viracon</i> VNE1-63 Basis of design (spandrel): <i>Viracon</i> VN
Face Brick	Glen-Gery extruded OSU 1963 (Basis of Design)	Aluminum Coping Finish: PPG UC1066
Mortar Precast panels	Brixment Stock Colors - Mortar M-10 Tan Architectural quality precast system to one storey base of brick façade, three storey panels to ASC Precast finish is to match limestone in appearance	Lehigh Hanson 972.653.5500 Architect's sample to match: <i>High Con</i>
Aluminum Composite Metal Wall Panels (Loading Docks)	Factory-formed and assembled metal composite wall panels fabricated from 2 0.020-inch thick coil-coated aluminum sheet facings bonded to a solid, extruded thermoplastic core	Basis of Design: 3A Composites Alucol Finish: PPG UC106693F Duranar Suns
Penthouse metal enclosure	Profiled metal panels fixed to steel stud backing wall with concealed fasteners	Basis of design: <i>Centria</i> Concept Serie set back. Equivalent systems are accpetable on HWPC 12 Finish: <i>PPG</i> UC106692F Duranar Suns
Generator screen wall enclosure/ Chiller enclosure/ Connector rainscreer	Aluminum tube fabrication w/ structural steel backup Frameless access gates to match	Finish: PPG UC106693F Duranar Suns
Canopy/colonnade structure	Exposed steel frame protected with anti-corrosion coating system and architectural top coat Columns to be raised on concrete bases Fasteners to be concealed or countersunk, welds to be ground smooth	Columns and beams to porte cochere v Finish: <i>PPG</i> UC106689F Duranar Suns
Canopy/colonnade edge profile and soffit	Aluminum pressing edge profile to roof edge with concealed fasteners, finish: two-coat 70% PVDF resin coating system with mica, custom color to match colonnade structure Canopy soffit: self-colored stucco on cement board system, color to be confirmed by Architect	Finish: PPG UC106689F Duranar Sunst
Canopy/colonnade roof	TPO system on plywood and metal profile sheet deck	Basis of Design: <i>Firestone</i> UltraPlyT TI
Canopy/ colonnade rainwater downpipes	Aluminum finish: two-coat 70% PVDF resin coating system with mica, custom color to match colonnade structure	
Cast in Place Concrete Site Walls (Loading Docks)	Cast in place concrete retaining walls	Finish: Architectural finish, color and te
Concrete Roof Pavers (2nd Floor Terrace/ Main Porte Cochere)	Concrete roof paving system on pedestals	Finish: Color to match precast
Handrails (Stairs & Ramps at Loading)	Guard and handrails at loading dock and loading dock stairs and ramps	Black finish
Bollards (Traffic control @ loading)	Square removable bollard to prevent incursion of vehicles	Black finish w/ white reflective tapes
Pole-mounted pedestrian light fixtures	14' Bega LED Pole top luminaires	True Black' Finish: Lithonia Black RCO2
Light Bollard	41 1/2" <i>Bega</i> LED Bollard 84 683	'True Black' Finish: Lithonia Black RCO
Parking Lot Lighting	Gardco Gullwing	Finish: Black from manufacturer's stan
Exterior wall-mounted plumbing fixtures	Overflow Wall Outlet: Downspout Nozzle 'Cow's Tongue' type FDCs Test Header Wall Hydrants	Finish: Nickel Bronze

storm Bistro Bronze rofiled alumium pressing to window head ated
ce caps to vertical mullions at corner façade, standard caps
inum panels at 10' modules at corner facade and aluminum pressing
ated
PPG UC106693F Duranar Sunstrom Bistro Bronze PPG UC106696F Duranar Sunstorm Russet Pearl
NE1-63 w/ V933 - Warm Gray Viraspan #4
6693F Duranar Sunstrom Bistro Bronze
ncrete Group Sample HC-01719
obond PE , Rout and Return Dry Seal
storm Bistro Bronze
ies, CS 660 profile to lower part of enclosure, CS 210 profile to upper
n submission for approval by the Architect: <i>DMI</i> HWPA 12, <i>DMI</i>
storm Bistro Bronze (Aluminum Coping to match)
strom Bistro Bronze
e will be concrete-filled to provide fire rating
storm Cashmere Pearl
storm Cashmere Pearl
ГРО - 60 mil - Gray
texture to match precast
texture to match precast
02304P4B Black, Super Durable (DBLXD)
2204D4P Plack Super Durchle (DPLVD)
D2304P4B Black, Super Durable (DBLXD)
indard options

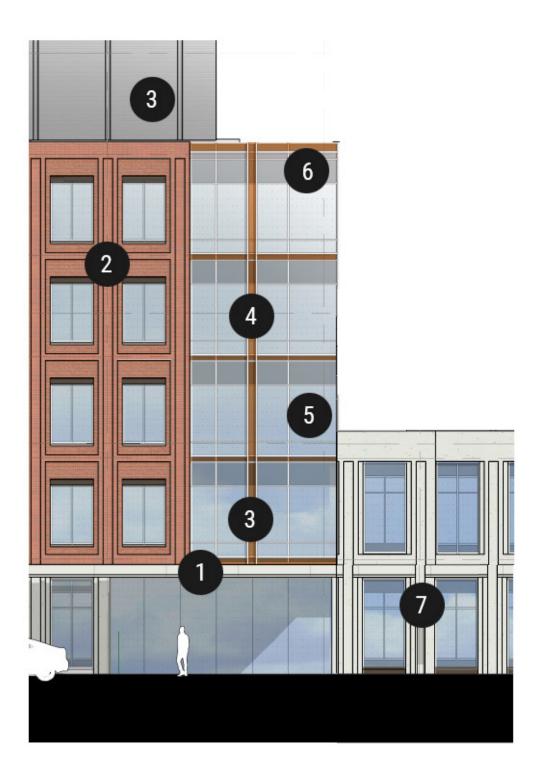

OSU WEXNER MEDICAL CENTER RAF POWELL, OH EXTERIOR MATERIALS



1. ALUMINUM 3 ENTRANCE CANOPIES

2. FACE BRICK

3. ALUMINUM 1 MULLIONS & PENTHOUSE ENCLOSURES

4. ALUMINUM 2 INFILL PANELS

5. INSULATED, LOW-E GLAZING

6. SPANDREL GLAZING




7. PRECAST CONCRETE PANELS



NO.	DATE	
	OSU PROJEC	T NUI
	OSU	WM
	FACIL	THE
250 V	Vest St, Suite 150	
BU	ILDING ELE	VAT
	PROJECT NO. 5-19109-00	

Anterna Anterna				
	DESCRIPTION			
REVISIONS UMBER OSU-220880				
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PREPARED FOR HE OHIO STATE UNIVERSITY ES OPERATION AND DEVELOPMENT COLUMBUS, OHIO				
PREPARED BY DLR Group				
TIONS	COLUMBU	JS, OHIO 43215 SHEET NUMBER A6		
FILE NAME	DRAWN BY	DATE 21 October, 2022		
	1	21 000001, 2022		

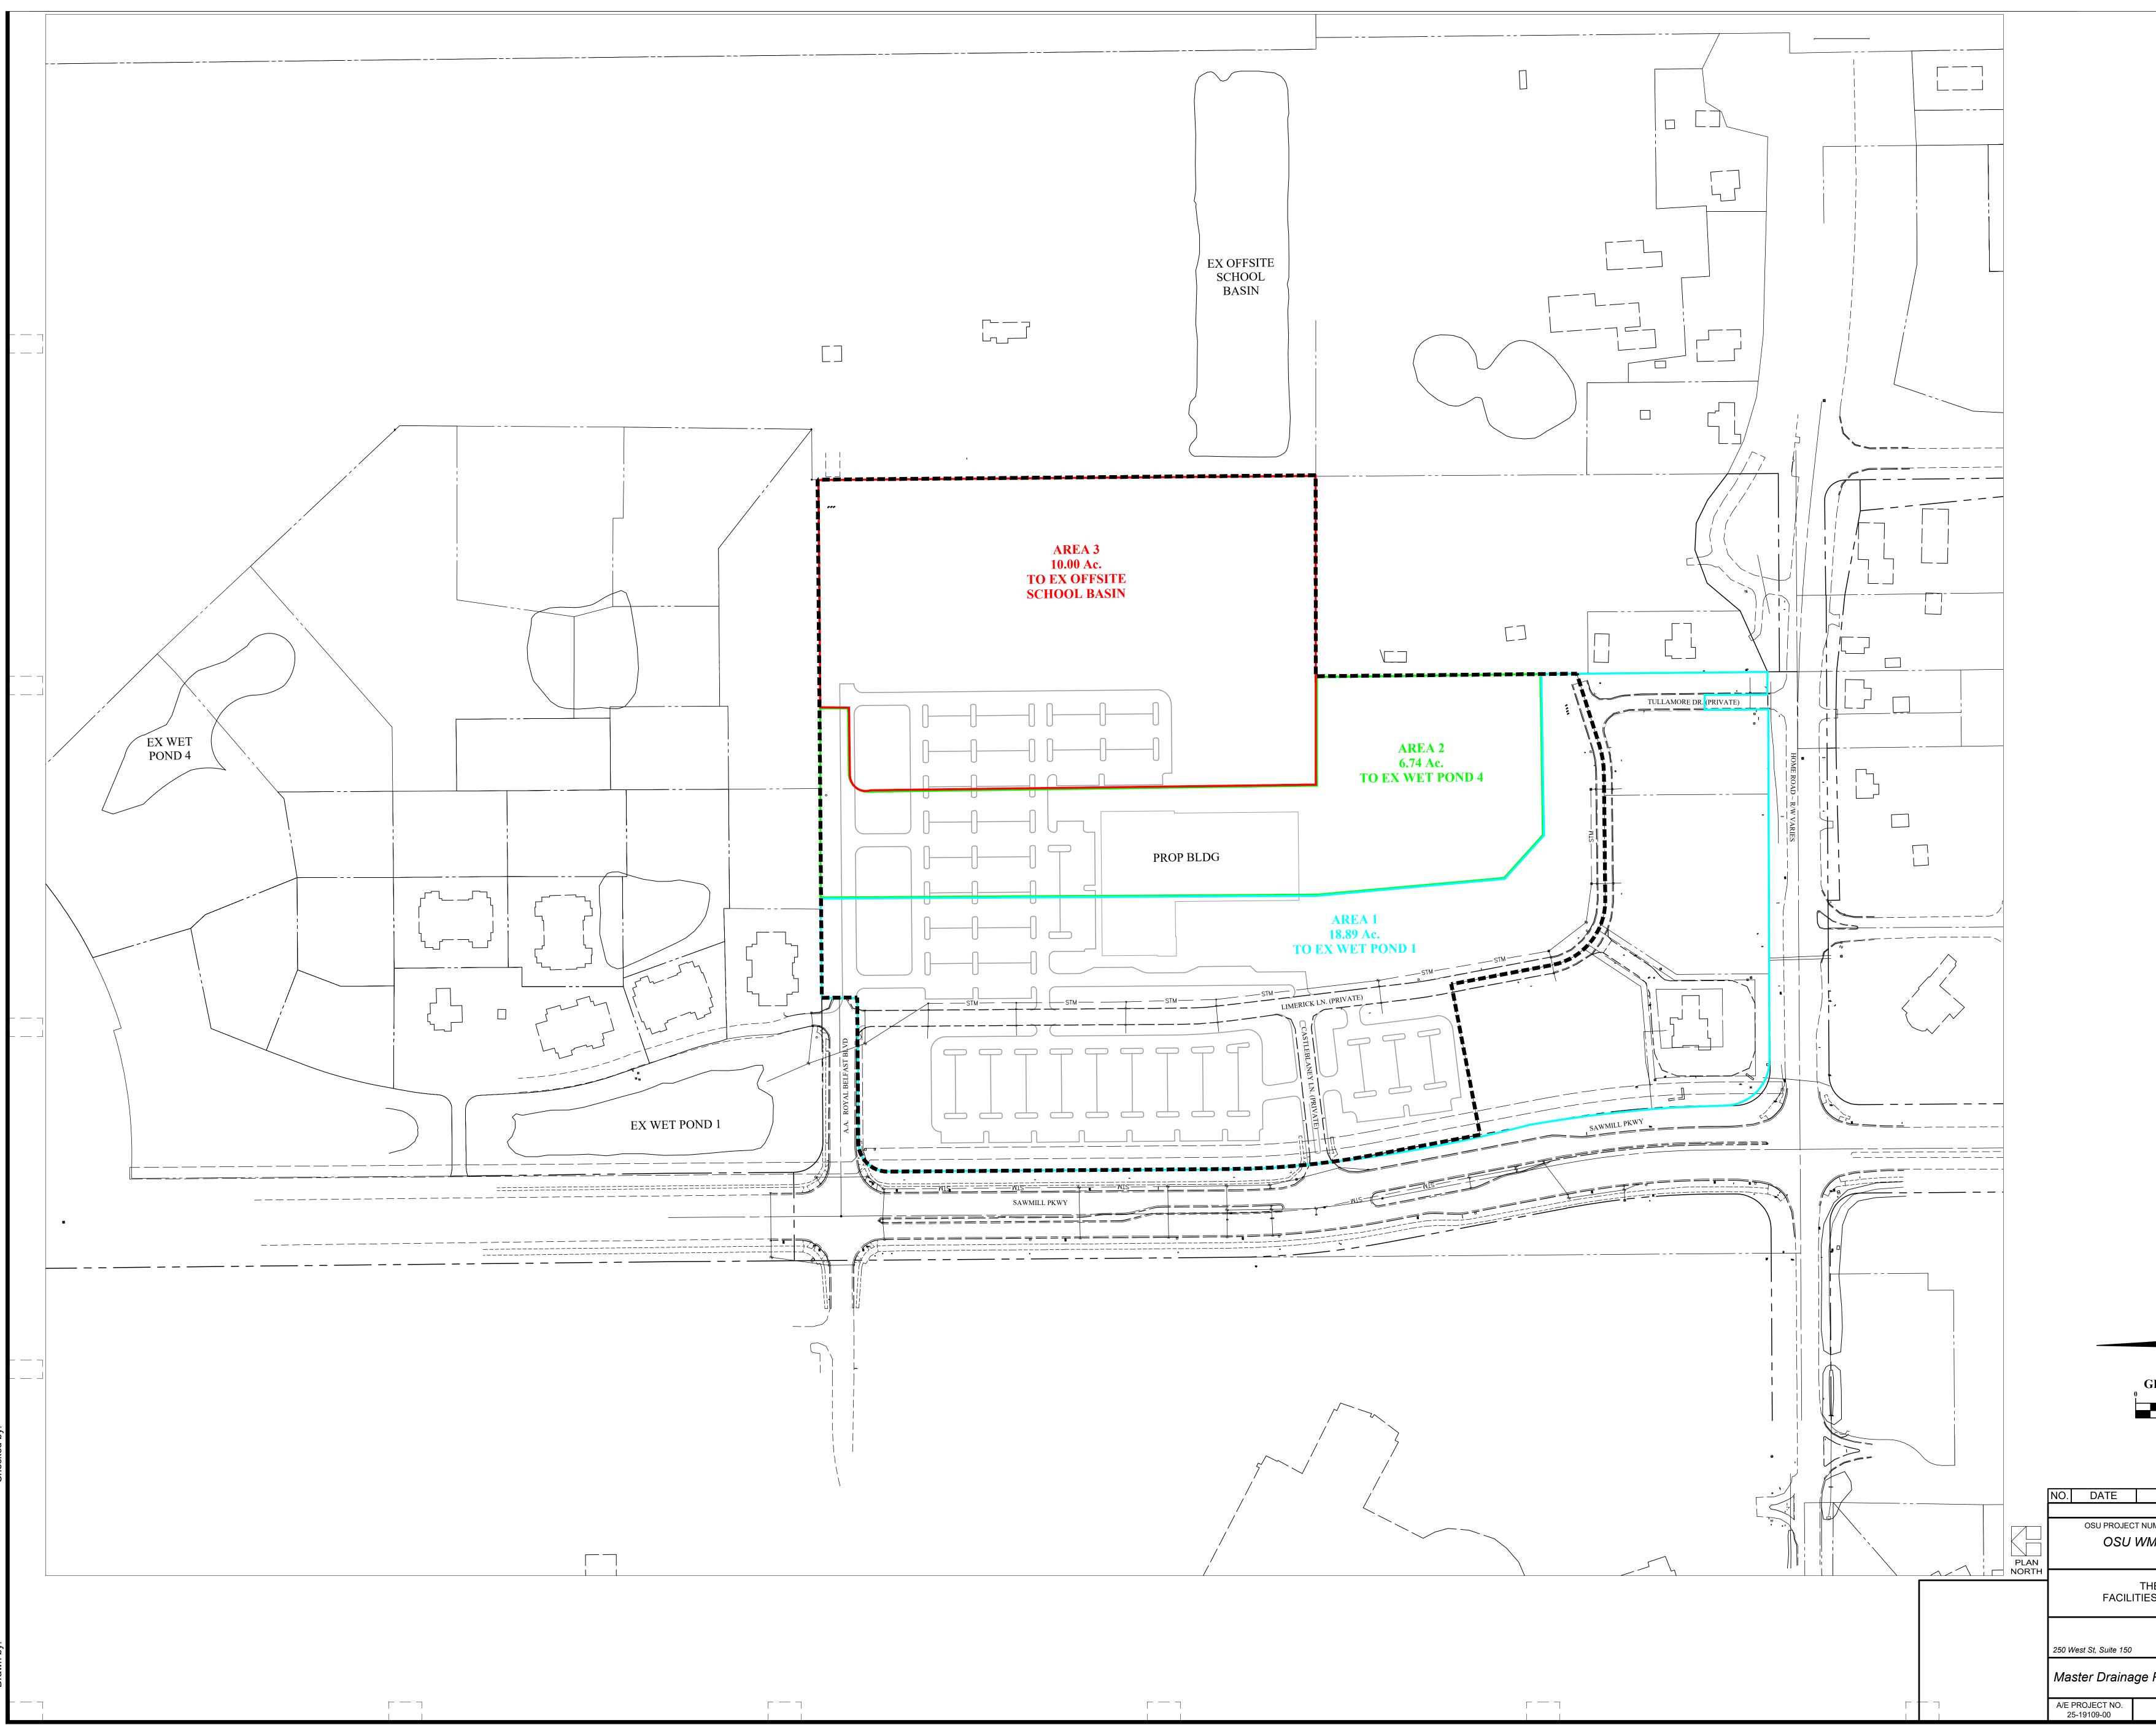

GRAPHIC SCALE				
1 inch = 100 fe	et			
	DESCRIPTION			
REVISIONS				
UMBER OSU-220880 MC Outpatient Care Powell				
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	E UNIVERSITY	MENT		
PREPARE DLR Gr	о вү О ир	S, OHIO 43215		
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FILE NAME	DRAWN BY	DATE 21 October, 2022		