Parking Plan & Projected Membership Attendance

We plan to exceed the required 20 parking spaces. Our lot is proposed to have 13 spaces (12 full and one motorcycle spot) plus the 11 additional spaces at the Historical society across the street. The Powell Center parking lot is a backup plan as needed once we are open and have a better idea what are actual parking needs are. We have also reached out to multiple neighbors to the west regarding shared parking agreements.

Membership Growth Curve will smooth out "new establishment rush"

	preview	1st month	2nd month	3rd month	4th month	5th month	6th month	7th month	8th month	Membership capp	ped	
Total # o members		50	75	100	120	140	160	180	192			

Access will be restricted to these numbers in order of application received to ensure elevated guest experience

Projected Total Number of guests on-site at any given time - Based on average guest visit of 2 hours

**Note - there will be no dinner service, only snacks to accompany responsible drinking, so we forecast two
peak times both before heading to another Powell Restaurant for dinner and after**

	4pm		5pm		6pm		7pm		8pm		9pm		10pm		Total number of guests that evening
М	~~~~	~~~	~~~~	~~~~	~~~~	~~~	~~~(closed	~~~	~~~	~~~~	~~~	~~~~	~~~	
Т		2	2	7	7	10	15	10	10	5					17
W		4	8	13	13	21	17	12	12						25
R	5	7	11	21	26	32	28	22	20	12	12	8			51
F	8	12	20	28	28	32	24	16	22	34	54	62	48	28	104
S	8	20	32	52	60	64	52	32	36	38	52	66	46	14	143
S	4	8	18	24	32	34	24	18	6						42
										To	otal Gu	ests f	or the	week	382

Our pro forma projects a peak attendance of 66 guests at 9pm on Saturday evening.

Giving our members room to spread out in certain areas of the club is key to our vision. Attendance will be reservation only. The purpose for these limits is to maximize our guests overall experience while at the club. The attendance of 382 visits per week was established on our pro forma by calculating the number of times our average member would attend each month versus our frequent flyers and our low attendance members.

Preliminary Terms of Parking Leases in addition to our 12 spaces:

- Powell Historical Society... 11 of the 12 spots in that lot are available for use during our business hours at an agreed upon price (minus one weekend each year when they host their retreat weekend). This lease has gone through multiple drafts and we are waiting to sign until the project is approved.
- Powell Center... have agreed upon preliminary structure of lease and pricing to include 5 spaces as employee parking every night and up to 35 spaces during busier times.

Parking Plan & Projected Membership Attendance

Note Our target membership are those living in the immediate Powell area that is only a \$10 Uber/Lyft ride from home, so that our members can imbibe responsibly. This will also alleviate pressure on our parking situation.

We are happy to have a right in / right out signage plan in place per Chris's suggestion, but would prefer to have it limited to rush hour (same limited hours as other turn restrictions in Downtown Powell).



POWELL, OHIO 43065

ABREVIATIONS

@ = ATG = GASGA = GAUGEAB = ANCHOR BOLT A/C = AIR CONDITIONING GALV = GALVANIZED GC = GENERAL CONTRACTOR ADJ = ADJACENTAFF = ABOVE FINISHED FLOOR GEN L = GENERAL AFS = ABOVE FINISHED SLAB GL = GLASSALS = ACRYLIC LATEX SEALANT GR = GRANITE GRND = GROUND ALUM = ALUMINUM GST = GLAZED STRUCTURAL TILE ANOD = ANODIZED GWB = GYPSUM WALL BOARD ARA = AREA OF RESCUE ASSISTANCE AP = ACCESS PANEL APPROX = APPROXIMATELY HB = HOSE BIBB

BDW = HARDWARE

HDWD = HARDWOOD HM = HOLLOW METAL

HORIZ = HORIZONTAL

HS = HIGH STRENGTH

ID = INSIDE DIAMETER

INFO = INFORMATION

INSUL = INSULATION

IG = INSIDE GLAZED

HVAC = HEATING, VENTILATION, A/C

HR = HOUR

HT = HEIGHT

IN = INCH

J = JOIST

INT = INTERIOR

JAN = JANITOR

KIT = KITCHEN

L = LENGTH

LB = POUND

LBL = LABEL

LIN = LINEAR

KP = KICK PLATE

LAM = LAMINATE (D)

LAV = LAVATORY

LH = LEFT HAND

MAR = MARBLE

MAS = MASONRY

MATL = MATERIAL

MAX = MAXIMUM

MECH = MECHANICAL

MEMB = MEMBRANEMEZZ = MEZZANINE

MFD = MANUFACTURED

MFR = MANUFACTURER

MGT = MANAGEMENT MH = MAN HOLE

MISC = MISCELLANEOUS

MO = MASONRY OPENING

NIC = NOT IN CONTRACT

OD = OUTSIDE DIAMETER OH = OPPOSITE HAND

MGR = MANAGER

MIN = MINIMUM

MP = METAL PANEL

MTD = MOUNTED

MTG = MEETING

NAT = NATURAL

NO = NUMBER

OA = OVERALL

OC = ON CENTER

O/O = OUT TO OUT

OPNG = OPENING

PARTN = PARTITION

PC = PERPENDICULAR

PERF = PERFORATED

P/L = PROPERTY LINE

PLY WD = PLY WOOD

PLAM = PLASTIC LAMINATE

PREFAB = PREFABRICATED

P.T. = PRESSURE TREATED

PSF = POUNDS PER SQUARE FOOT PSI = POUNDS PER SQUARE INCH

PFN = PREFINISH (ED)

PCP = PRECAST CONCRETE PLATE

OPP = OPPOSITE

OZ = OUNCE

PH = PHASE

PL = PLATE

PR = PAIR

PT = PAINT

PTD = PAINTED

NOM = NOMINAL

NTS = NOT TO SCALE

MTL = METAL

N = NORTH

MIR = MIRROR

JB = JUNCTION BOX

JC = JANITORS CLOSET

ARCH = ARCHITECT AS = ACOUSTICAL SEALANT B/ = BOTTOM OF B/B = BACK TO BACK BD = BOARDBFG = BELOW FINISHED GRADE BLDG = BUILDING BLK = BLOCK (BLOCKING)

BM = BEAMBMT = BUTYL MASTIC TAPE SEALANT BRK = BRICKBRS = BUTYL RUBBER SEALANT BRZ = BRONZEBSMT = BASEMENT BTW = BETWEEN

BYD = BEYONDC/C = CENTER TO CENTERCIP = CAST-IN-PLACE CEM = CEMENTCER = CERAMICCFL = COUNTERFLASH (ING) CJ = CONTROL JOINT CL = CENTER LINE CLG = CEILING CLO = CLOSET

CLR = CLEAR OPENING CMU = CONCRETE MASONRY UNIT CO = CLEAN OUT COL = COLUMNCONC = CONCRETE CONST = CONSTRUCTION CONTR - CONTRACTOR CONT = CONTINUOUS COOR = COORDINATE CORR = CORRIDOR CPT = CARPETCT = CERAMIC TILE

CTSK = COUNTERSINK CTR = CENTER CU = CUBICDB = DIRECT BURIAL DBL = DOUBLEDD = DECK DRAINDIA = DIAMETERDIFF = DIFFUSER DIM = DIMENSION DIR = DIRECTION

DN = DOWNDR = DOORDS = DOWN SPOUT DTL = DETAILDW = DRY WALL DWG(S) = DRAWING(S)EA = EACHEB = EXPANSION BOLT EC = EXPOSED CONSTRUCTION

EF = EXHAUST FANEJ = EXPANSION JOINT EL = ELEVATORELEC = ELECTRIC ELEV = ELEVATION EOS = EDGE OF SLAB EQ = EQUALEQUIP = EQUIPMENT EXTG = EXISTINGEXT = EXTERIOR

F = FEMALEFA = FIRE ALARM FACP = FIRE ALARM CONTROL PANEL O.R.C. = OHIO RESIDENTIAL CODE FB = FACE BRICK F/C = FAN COILFD = FLOOR DRAIN FE = FIRE EXTINGUISHER FEC = FIRE EXTINGUISHER CABINET FF = FINISHED FLOOR FIN = FINISH (ED)FIXT = FIXTURE FLR = FLOOR FLUOR = FLUORESCENT FND = FOUNDATION FOC = FACE OF CONCRETE FOF = FACE OF FINISH FOS = FACE OF STUD FSD = FIRE SEPARATION DISTANCE FRT = FIRE RETARDANT TREATED FT = FEET

FTG = FOOTING

FV = FIELD VERIFY

QT = QUARRY TILE QTY = QUALITY QUANT = QUANTITY

> R = RADIUSRA = RETURN AIRRB = RESILIENT BASE RC = REINFORCED CONCRETE RD = ROOF DRAIN REF = REFERENCE REG = REGISTER REINF = REINFORCED REQ D = REQUIREDREV = REVISION RFL = REFLECTED RGTR = REGISTER RI = RISERRM = ROOMRMV = REMOVE

RoW = RIGHT OF WAY S = SOUTHSA = SUPPLY AIRSD = SMOKE DETECTOR SECT = SECTIONSGG = SILICONE GLAZING GASKET SGS = SILICONE GLAZING SEALANT SHT = SHEET SHTG = SHEATHING SIM = SIMILARSJS = SILICONE JOINT SEALANT SPEC = SPECIFICATION

RO = ROUGH OPENING

SQ = SQUARESQFT = SQUARE FEET SQYD = SQUARE YARD SS = STAINLESS STEEL ST = SEALANT TAPE STD = STANDARDSTL = STEELSTM = STORM STOR = STORAGE STRUCT = STRUCTURAL SUSP = SUSPENDED LLH = LONG LEG HORIZONTAL SYS = SYSTEM

LLV = LONG LEG VERTICAL LNFT = LINEAR FEET T = TOWNHOUSELP = LOW POINT T/ = TOP OF LT(G) = LIGHTING(ING)TEL = TELEPHONE LVPL = LEVELING PLATE TEMP = TEMPERATURE LVR = LOUVERTH = TOWNHOUSE THK = THICK (NESS)M = MALETHR = THRESHOLD MACH = MACHINE TYP = TYPICALMAINT = MAINTENANCE

UC = UNDERCUT UG = UNDERGROUND UNF = UNFISNISHED UNO = UNLESS NOTED OTHERWISE MDF = MEDIUM DENSITY FIBER MDO = MEDIUM DENSITY OVERLAY

VA = VOLT-AMPSVAL = VALVEVERT = VERTICAL VEST = VESTIBULE VIF = VERIFY IN FIELD VCT = VINYL COMPOSITION TILE VWC = VINYL WALL COVERING

W = WESTW/ = WITHW/O = WITH OUT WC = WATER CLOSET WCO = WALL CLEAN OUT WD = WOODWDW = WINDOW WRB = WEATHER RESISTIVE BARRIER WPR = WATERPROOFING WPT = WORK POINT WT = WEIGHT WWF = WELDED WIRE FABRIC

YD = YARD

SYMBOLS LEGEND

DETAIL NO.			
1 SI M A101	BUILDING SECTION	AREA NAME	AREA TAG
DETAIL NO. SHEET NO.		ROOM NAME	
1 SIM	WALL SECTION	101	ROOM TAG
DETAIL NO. SHEET NO.		150 SF	
A101	DETAIL SECTION	$(\widehat{1})$ NOTE	CODED NOTE
DETAIL NO. SHEET NO. DETAIL AREA SIM	DETAIL CALLOUT	?	KEYNOTE
DETAIL NO. SHEET NO. DETAIL NO.	EXTERIOR ELEVATION	1	REVISION TAG
1 A101 1	INTERIOR ELEVATION	W22	WALL TAG
	ELEVATION	\bar{\range}	WINDOW TAG
XXX.X'	SPOT ELEVATION	101	DOOR TAG
— — — — []	STURCTURAL GRID LINE		FLOOR/ROOF TAG
	MATCH LINE	<ac1></ac1>	ACCESSORY TAG

CENTERLINE

RUBBLE

ALUMINUM

PLYWOOD

(SMALL SCALE)

MATERIALS LEGEND

GEOLOGICAL ROCK

MORTAR

FIREBRICK

BRASS

BLOCKING

CERAMIC TILE

SPRAY FOAM

SITEWORK

CONCRETE

MASONRY

STONE

METAL

WOOD

FINISHES

INSULATION

EARTH

CIP/PRECAST

PLYWOOD

PLASTIC

BATT/ LOOSE

(LARGE SCALE)

DRAWING INDEX

NO.	NAME	REVISION NO.	REVISIO DATE
01 - GE	NERΔI		
	COVER SHEET		
	ARCHITECTURAL SITE PLAN	+	+
	LIFE SAFTEY FLOOR PLANS + BUILDING SECTIONS	+	+
G1.02	LIFE SAFTEY FLOOK PLAINS + BUILDING SECTIONS	<u> </u>	
05 - CI	/IL		
C1	GRADING PLAN		
C2	SITE PLAN		
00 -	NDCCARE		
	NDSCAPE		
L1.00	LANDSCAPE		
00 45			
	CHITECTURAL DEMOLITION		
AD1.01	BASEMENT + LEVEL 1 DEMOLITION PLANS	<u> </u>	<u> </u>
ΛQ _ Λ D	CHITECTURAL		
A1.00	FOUNDATION PLAN	T	
A1.00	EXTG. BASEMENT + NEW LEVEL 1 PLAN	+	+
A1.01	EXTG. LEVEL 1 PLAN	+	+
A1.02	NEW MEZZANINE PLAN	+	+
A1.03	EXTG. ATTIC	+	+
A1.04	ROOF PLAN	+	+
A2.00	BUILDING ELEVATIONS	+	+
A2.00	BUILDING ELEVATIONS	+	+
A4.11	ENLARGED EXTERIOR SITE DETAILS	+	+
A5.01	WALL SECTIONS + DETAILS	+	+
A5.01	WALL SECTIONS + DETAILS WALL SECTIONS + DETAILS	+	+
A6.00	DOOR SCHEDULE + DETAILS	+	+
A8.00	RENDERINGS	+	+
A8.02	MATERIAL PALETTE	+	+
	_ +	+	+
A8.03	SITE LIGHTING	<u> </u>	+
A8.04	EXISTING IMAGES		

PROJECT DIRECTORY

Owner: Goodnight Investments Michael + Gretchen Bonasera thefoodsmith@foodsmith.com Owner Phone No. SJM studio, LLC **Architect:** Sarah Mackert sjm@sjmstudiollc.com (937) 215-0845 Civil Engineer: IBI Group **Eric Chenevey** eric.chenevey@ibigroup.com 614.679.3645 Structural Engineer: Ehlers Engineering, LLC Derek Ehlers, PE derek@ehlersengineering.com 614.330.2298

MEP Engineer: Allemang Engineering, LLC Donald K. Allemang, PE dalleman@columbus.rr.com 614.580.9006


General Contractor: Lincoln Construction Greg Schmitt gschmitt@lincolnconstruction.com

APPLICABLE CODES

614.457.0180

VILLAGE OF POWELL, PLANNING AND ZONING CODE 2017 OHIO BUILDING CODE (OBCO + AMENDMENTS 2017 OHIO PLUMBING CODE (OPC) + AMENDMENTS 2017 OHIO MECHANICAL CODE (OMC) + AMENDMENTS 2017 NATIONAL ELECTRIC CODE (NEC) | NFPA 70 ICC A117.1-2009 ACCESSIBLE + USABLE BUILDINGS + FACILITIES 2012 INTERNATIONAL ENERGY CONSERVATION CODE + AMENDMENTS 2015 INTERNATIONAL FUEL GAS CODE ASHRAE 90.1 2010 NATIONAL FIRE ALARM + SIGNALING CODE (NFPA 72-10) OHIO FIRE CODE 2017

VICINITY MAP

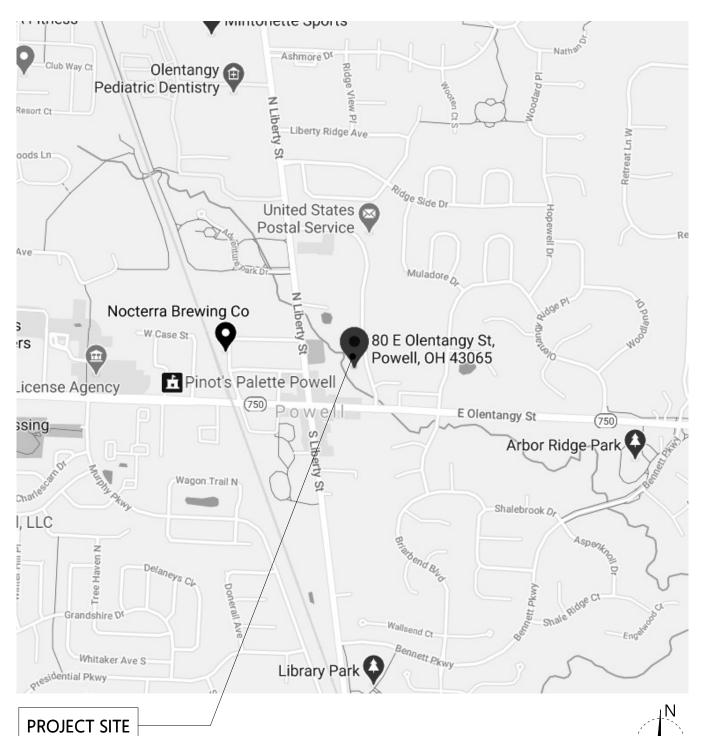

PARCEL SUMMARY:

PROJECT DESCRIPTION:

THE PROJECT CONSISTS OF A CHANGE OF OCCUPANCY WITH ALTERATIONS TO AN EXISTING 2,461 SF IIIB STRUCTURE LOCATED WITHIN THE VILLAGE OF POWELL, OHIO. A 2,083 SF ADDITION OF TYPE VB CONSTRUCTION WILL BE ADDED TO THE NORTH. THESE COMBINED SPACES WILL ACCOMMODATE AN A-2 ASSEMBLY OCCUPANCY WITH SUPPORTING OFFICE, RESTROOMS, STORAGE, UTILITY AND CIRCULATION AS REQUIRED FOR A PRIVATE SOCIAL CLUB.

PROJECT SUMMARY

DELAWARE COUNTY PARCEL NO. 31942513051002 0.46 ACRES

#\DATE REVISION

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PENDING APPROVAL This document is partially complete. The information This drawing is for review purposes only.

PROJECT TITLE

80 E **OLENTANGY** POWELL, OHIO 43065

PROJECT NO. SJM_2010 ISSUE FINAL P&Z APPLICATION **ISSUE DATE** 05.06.2021 SHEET TITLE

COVER SHEET

SHEET NO.

GENERAL ZONING INFORMATION

PARCEL NO. DELAWARE COUNTY NO. 319-425-13-051-002 ZONING DISTRICT DB - DOWNTOWN BUSINESS DISTRICT

HEIGHT DISTRICT H-35

GENERAL PROJECT INFORMATION

PROPOSED REFUSE SERVICE TBD (COMMERCIAL ONLY) PROPOSED REFUSE CAPACITY, CY

(COMMERCIAL ONLY)

PARKING CALCULATION

USE	SIZE	MIN SPACES	MAX SPACES
PRIVATE SOCIAL CLUB	192 MEMBERS	1:10 = 20	N/A
	6 STAFF		

REQUIRED PARKING FOR PROPOSED USE

MOTORCYCLE PARKING

PROPOSED PARKING 23 MIN. (12 ON-SITE; 11+ OFF-SITE LEASED) REQUIRED ADA PARKING (VAN/TOTAL)

SITE DATA

NOT FOR CONSTRUCTION

PENDING APPROVAL

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PROPERTY ADDRESS: 80 E OLENTANGY POWELL, OH 43065

GOODNIGHT INVESTMENTS PROPERTY OWNER: OWNER ADDRESS: 4200 MACDUFF WAY DUBLIN, OH 43016

TOTAL LOT AREA: 20,201.79 SF / 0.46 ACRES

1,304.3 SF EXISTING BUILDING TOTAL PRINCIPAL BUILDING FOOTPRINT 1,817.3 SF NEW ADDITION 120.0 SF NEW DECK 257.5 SF NEW PATIO

3,449.1 SF TOTAL TOTAL ACCESSORY BUILDING AREA:

LOT USAGE:

TOTAL COVERED AREA: 3,449.1 SF OR 17.3%

SITE SCHEDULE

20% MAX. ALLOWABLE 17.3% PROPOSED

35.00' MAX. ALLOWABLE BUILDING HEIGHT: 19.00' PROPOSED

FRONT (SOUTH): 20' MIN - 25' MAX ALLOWABLE 26' EXISTING

FRONT (EAST): 20' MIN - 25' MAX ALLOWABLE 70' EXISTING

REAR (NORTH): 5.00' MIN. ALLOWABLE 41' PROPOSED

WEST SIDE: 5.00' MIN. ALLOWABLE 14' PROPOSED

SITE PLAN LEGEND

MINIMUM SETBACK LINE — — — — MAXIMUM SETBACK LINE

SITE PLAN NOTES

PROPOSED CURB CUT AND DRIVE ACCESS TO NEW PARKING LOT

PROPOSED SEGMENTAL RETAINING WALL (VERSA-LOK OR SIM)

PROPOSED OFF STREET PARKING (12 VEHICULAR SPACES + 1 MOTORCYCLE SPACE). SEE CIVIL PLAN. PROPOSED REFUSE, RECYCLING AND MISC. STORAGE

EXISTING STEPS TO REMAIN

PROPOSED LANDSCAPING, SEE LANDSCAPE PLAN L1.00 PROPOSED NEW PPEDESTRIAN WALK

DATE REVISION

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PROJECT TITLE


80 E **OLENTANGY** POWELL, OHIO 43065

PROJECT NO. SJM_2010 ISSUE FINAL P&Z APPLICATION **ISSUE DATE**

SHEET TITLE ARCHITECTURAL SITE PLAN


SHEET NO.


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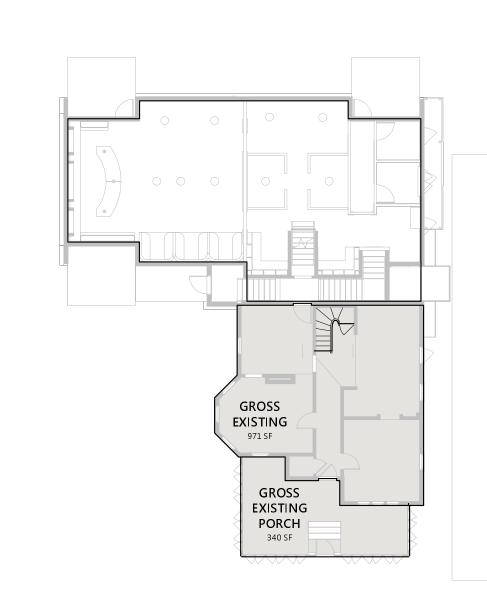


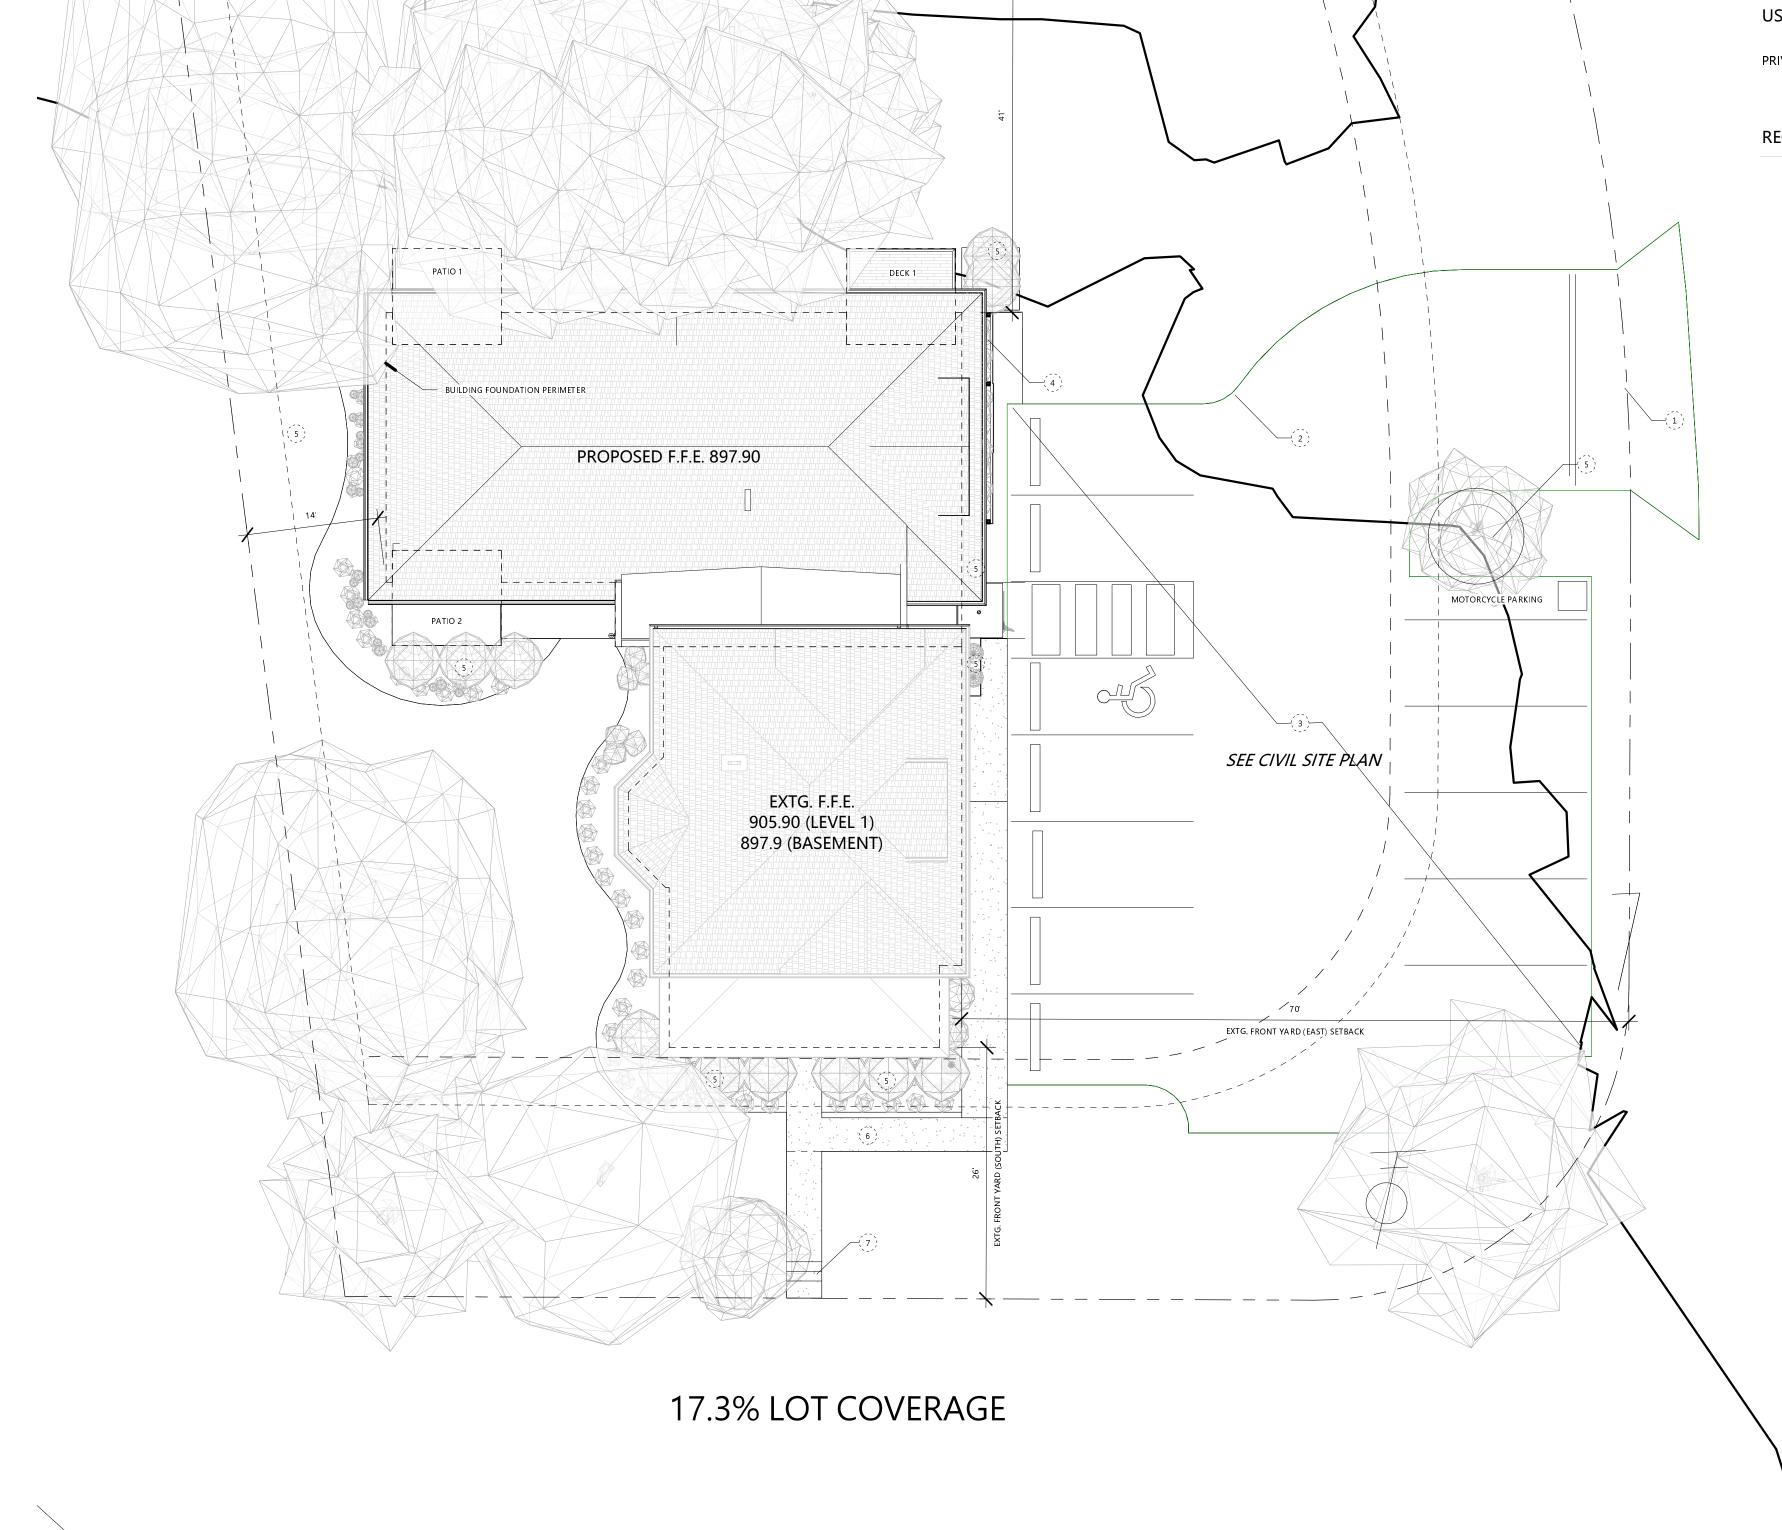ARCHITECTURAL SITE PLAN


\G0.01\frac{1}{} 1" = 10'-0"



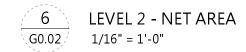

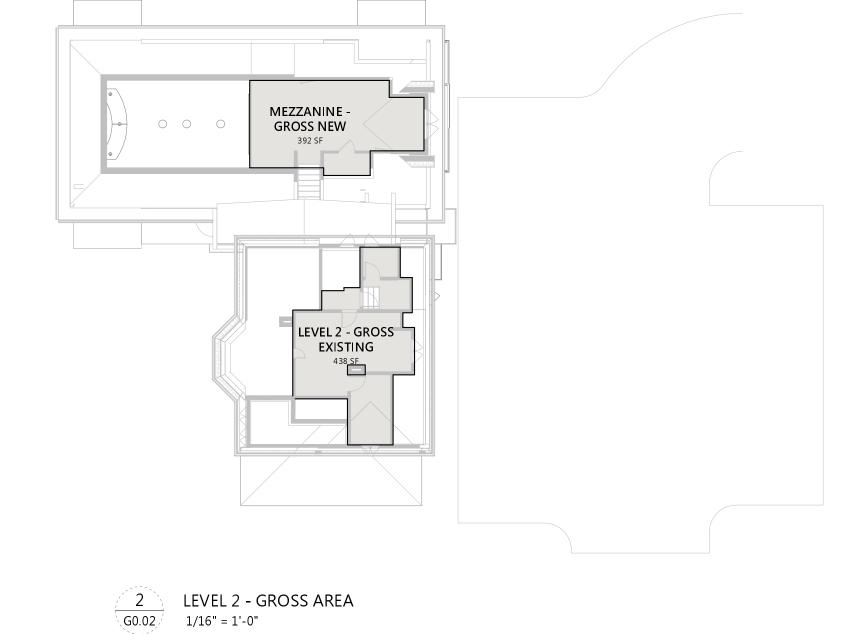

3 EXTG LEVEL 1 - GROSS AREA 1/16" = 1'-0"

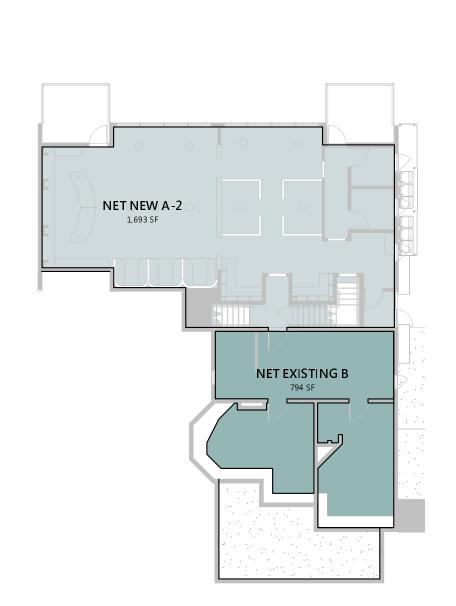

NET EXISTING

A-2


866 SF


4 LEVEL 1 - NET AREA 1/16" = 1'-0"


NET EXISTING _____

A-2 322 SF



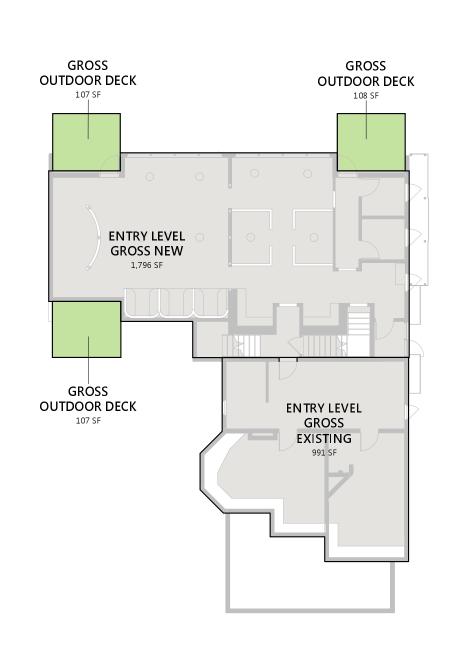

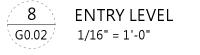

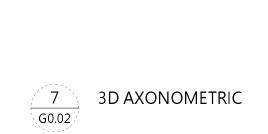

PROPOSED PARKING LOT SLOPE 5% MAXIMUM OR AS REQUIRED FOR STORMWATER RUNOFF - EXISTING 1908
RESIDENTIAL STRUCTURE
2,762 SF GROSS
(1,306 SF FOOTPRINT) —

PROPOSED ENTRY LEVEL
TO COORDINATE W/
EXISTING GRADE —

PROPOSED ADDITION +/- 2,583 SF GROSS (2,025 SF FOOTPRINT) —

GROSS AREA - EXISTING AREA NAME ENTRY LEVEL ENTRY LEVEL GROSS EXISTING 991 SF EXTG. LEVEL 1 971 SF **GROSS EXISTING GROSS EXISTING PORCH** 340 SF 1,312 SF EXTG. LEVEL 2 LEVEL 2 - GROSS EXISTING 438 SF 438 SF 2,741 SF Grand total: 4 GROSS AREA - NEW

AREA NAME	AREA
ENTRY LEVEL	
ENTRY LEVEL GROSS NEW	1,796 SF
	1,796 SF
EXTG. LEVEL 2	
MEZZANINE - GROSS NEW	392 SF
	392 SF
Grand total: 2	2,188 SF

AREA NAME	AREA
ENTRY LEVEL	
GROSS OUTDOOR DECK	107 SF
GROSS OUTDOOR DECK	107 SF
GROSS OUTDOOR DECK	108 SF
Grand total: 3	322 SF

		NET AREA
LEVEL	AREA NAME	AREA
EXISTING		
EXTG. BASEMENT	NET EXISTING B	794 SF
EXTG. LEVEL 1	NET EXISTING A-2	866 SF
EXTG. LEVEL 1	NET EXISTING A-2	322 SF
EXTG. LEVEL 2	NET EXISTING A-2	387 SF
		2,369 SF
NEW		
EXTG. BASEMENT	NET NEW A-2	1,693 SF
EXTG. LEVEL 2	NET NEW A-2	390 SF
		2,083 SF

4,453 SF

Grand total: 6

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PROJECT TITLE

80 E

OLENTANGY
POWELL, OHIO 43065

PROJECT NO. SJM_2010


ISSUE FINAL P&Z APPLICATION

ISSUE DATE 05.06.2021

SHEET TITLE

PROJECT SUMMARY

SHEET NO.

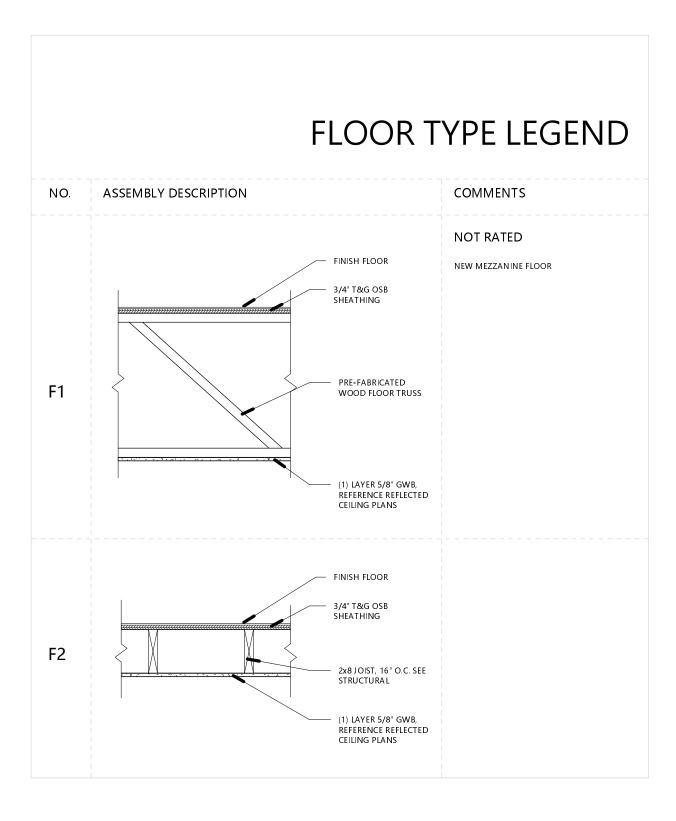

FOUNDATION TYPE LEGEND

8" CMU, SOLID GROUTED PER STRUCTURAL REQUIREMENTS

- WATERPROOF MEMBRANE

- DRAINAGE MAT


COMMENTS


NOT RATED

TYPICAL FOUNDATION WALL


NO. ASSEMBLY DESCRIPTION

F1

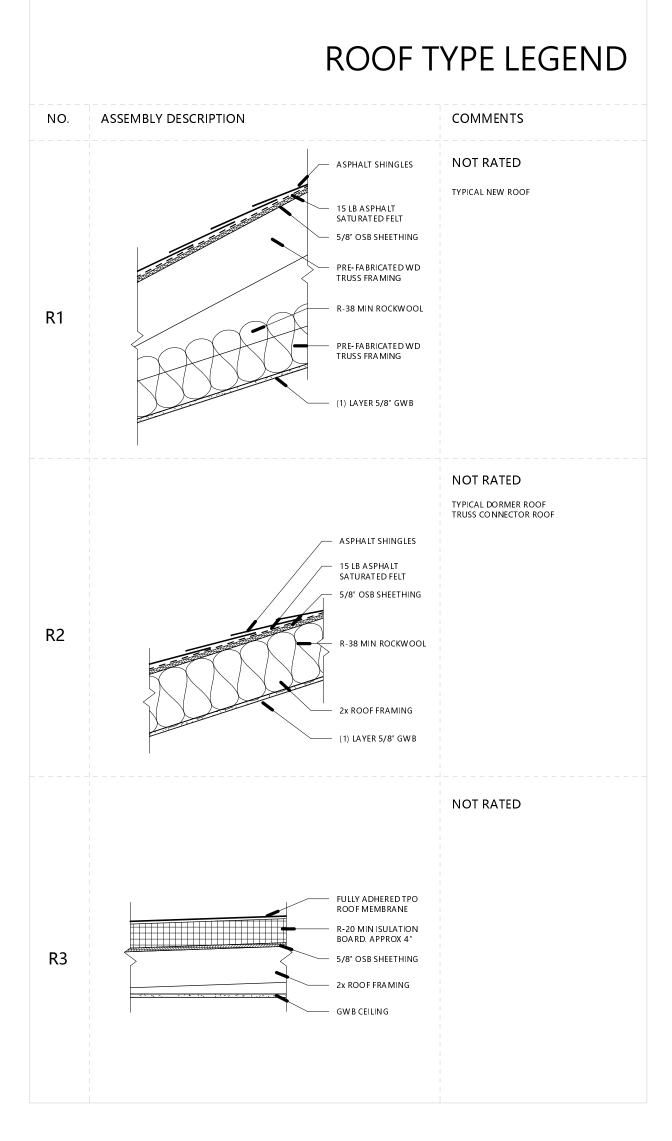

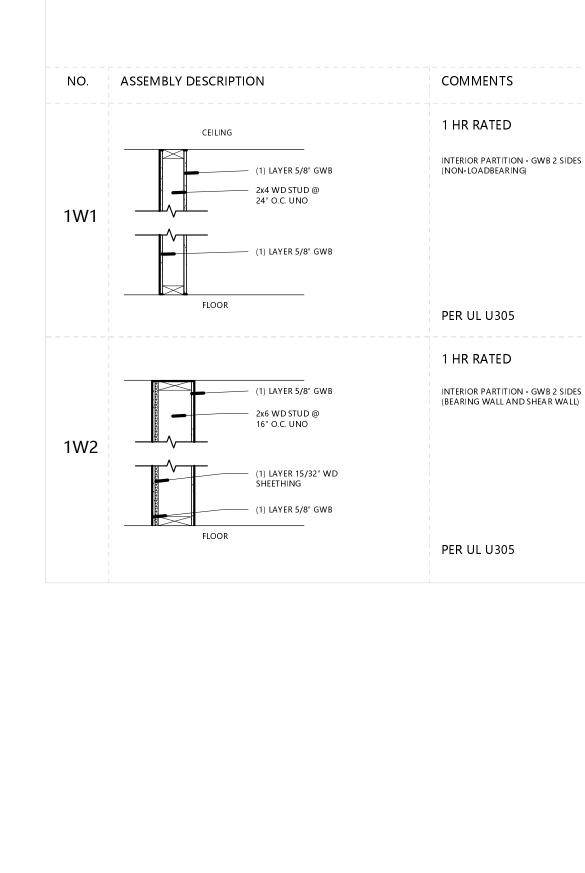

WALL TYPE LEGEND

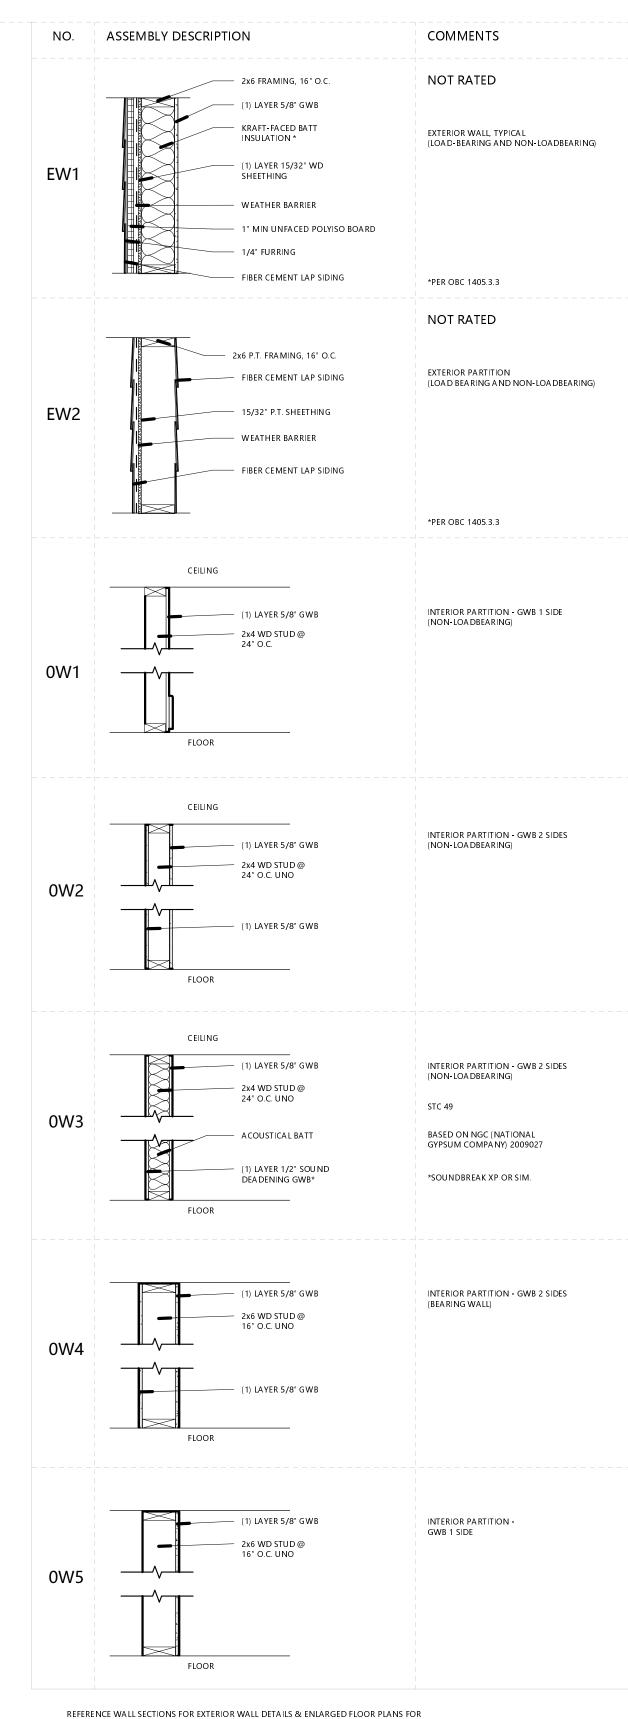

REFERENCE WALL SECTIONS FOR EXTERIOR WALL DETAILS & ENLARGED FLOOR PLANS FOR ACOUSTIC BATT INSULATION.

**GWB A PPLIED VERTICALLY OR HORIZONTALLY WITH 6d COOLER OR WALLBOARD NAILS @
7" O.C. W/ END JOINTS ON NAILING MEMBERS. STAGGER JOINTS EA. SIDE.

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DATE REVISION

PROJECT TITLE

80 E OLENTANGYPOWELL, OHIO 43065

PROJECT NO. SJM_2010


ISSUE FINAL P&Z APPLICATION


ISSUE DATE 05.06.2021

FLOOR, CEILING, & WALL ASSEMBLIES

SHEET NO.

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EAST FACADE PERSPECTIVE VIEW
12" = 1'-0"

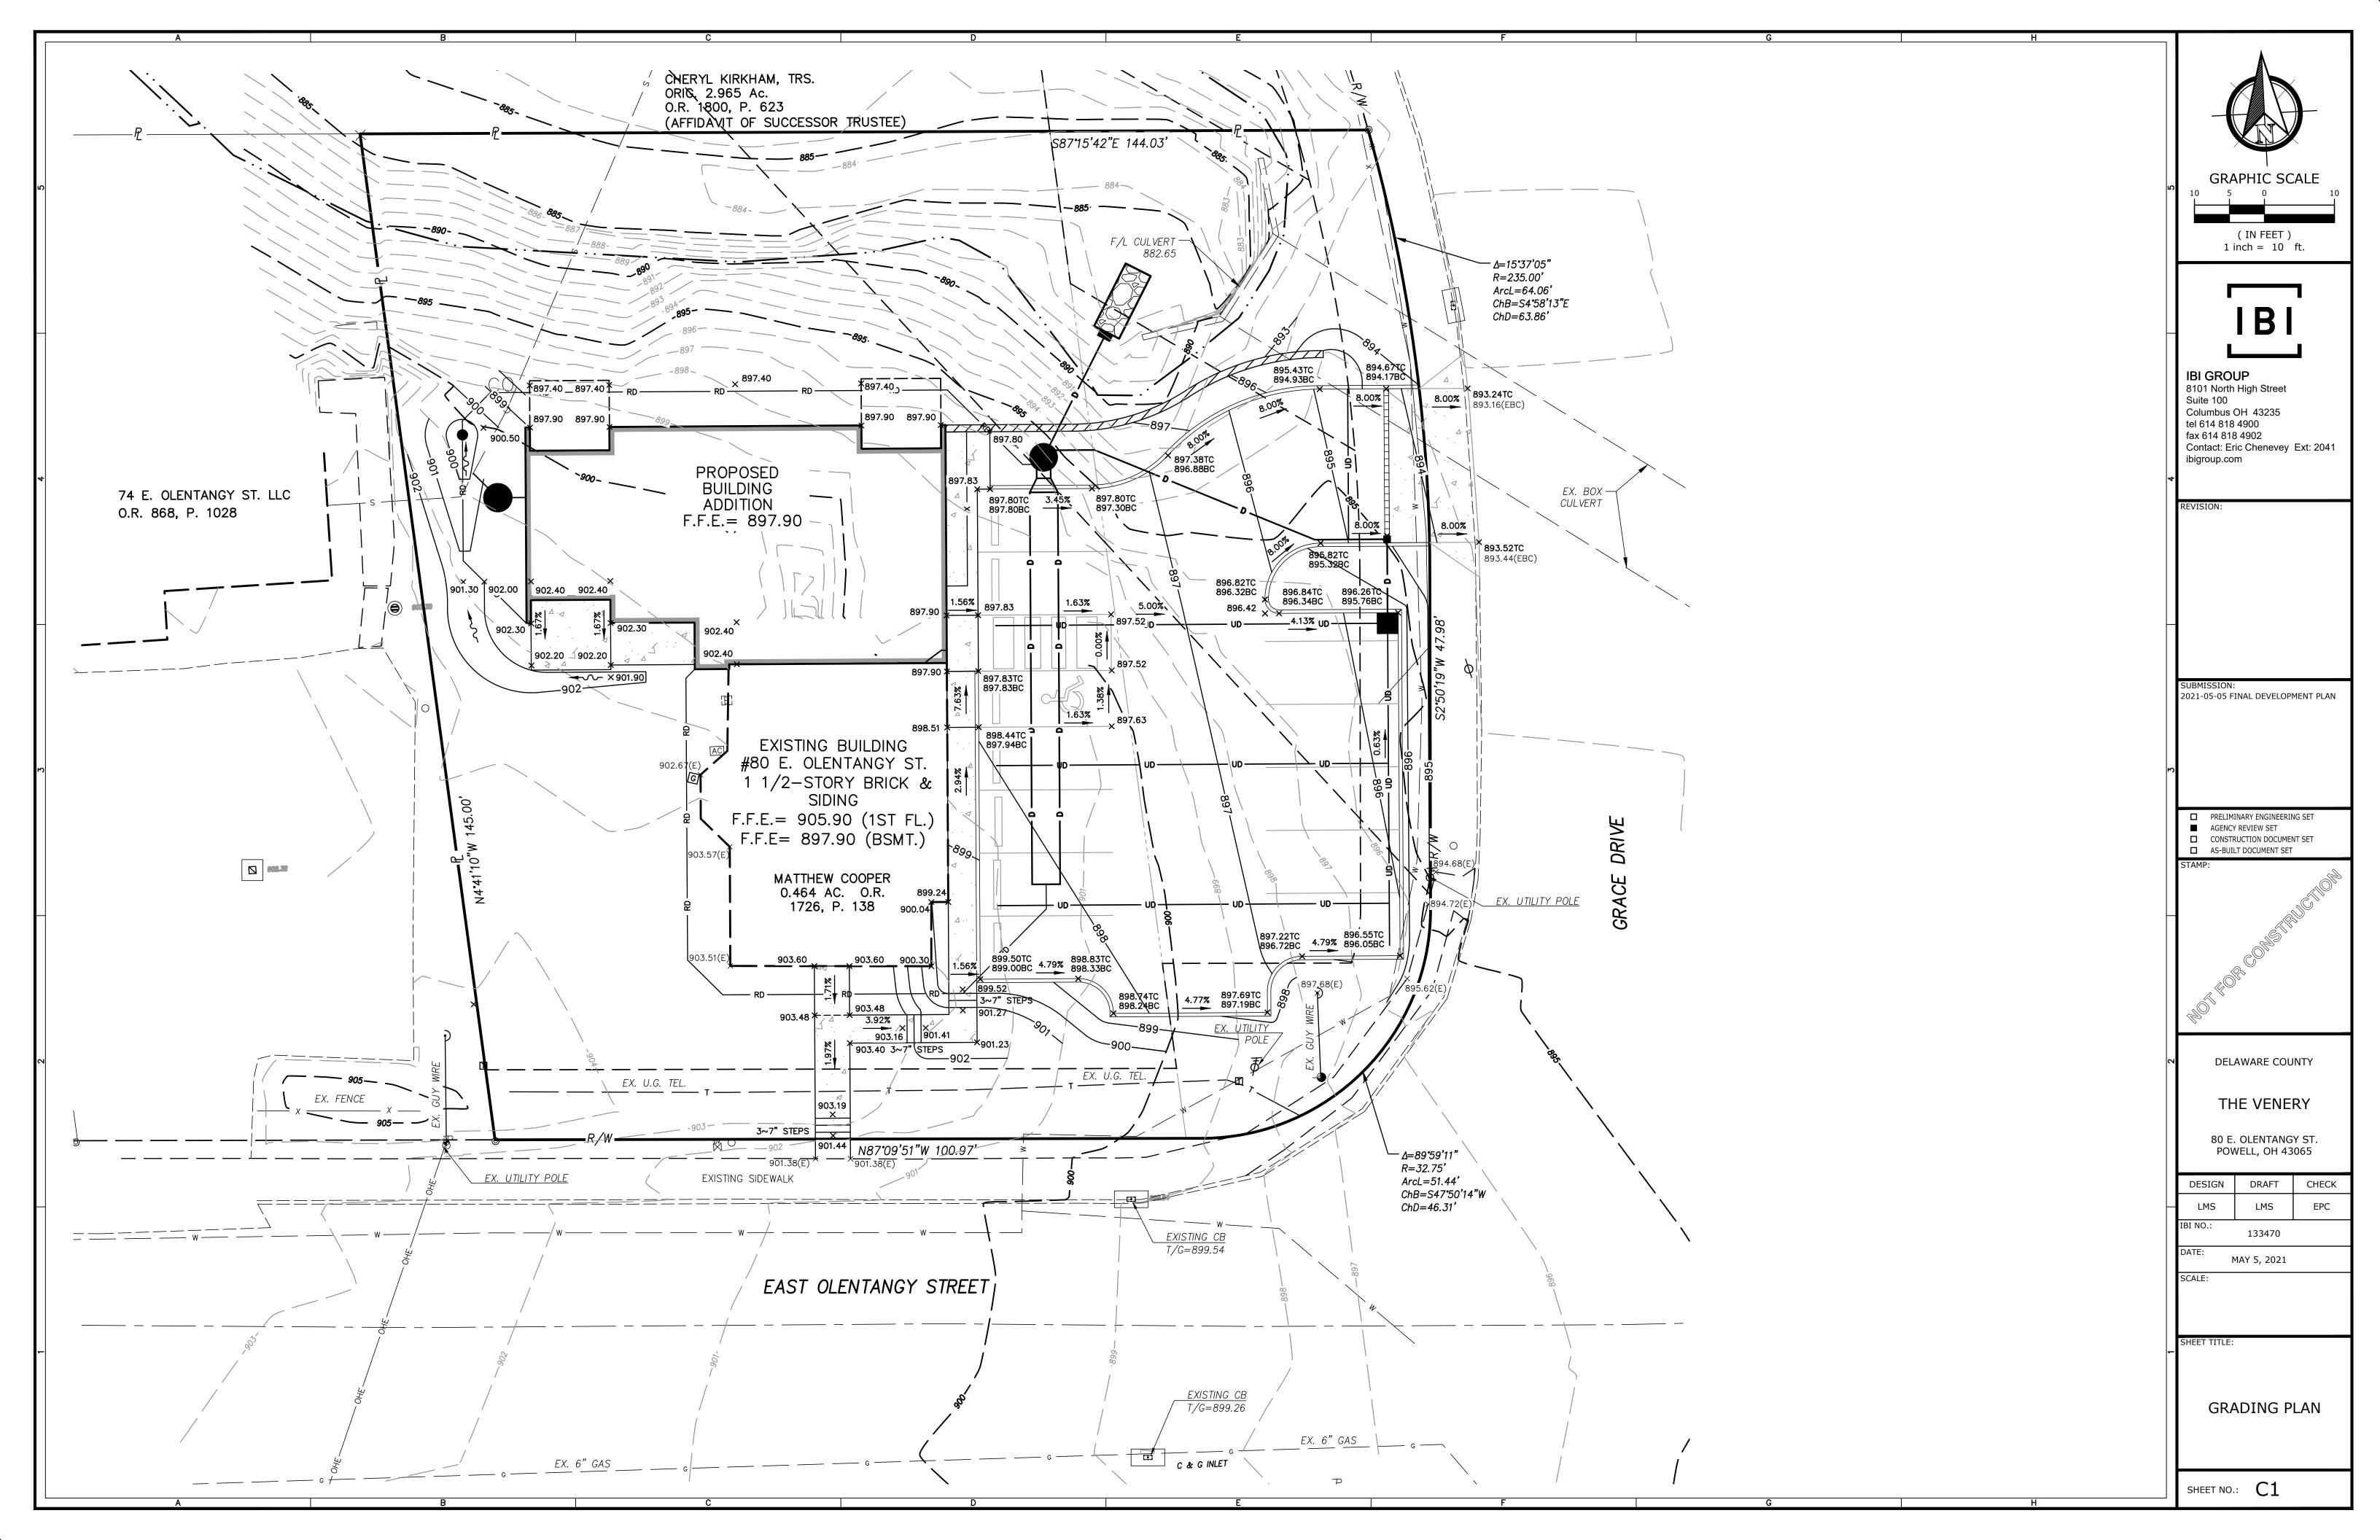
NORTH FACADE PERSPECTIVE VIEW
12" = 1'-0"

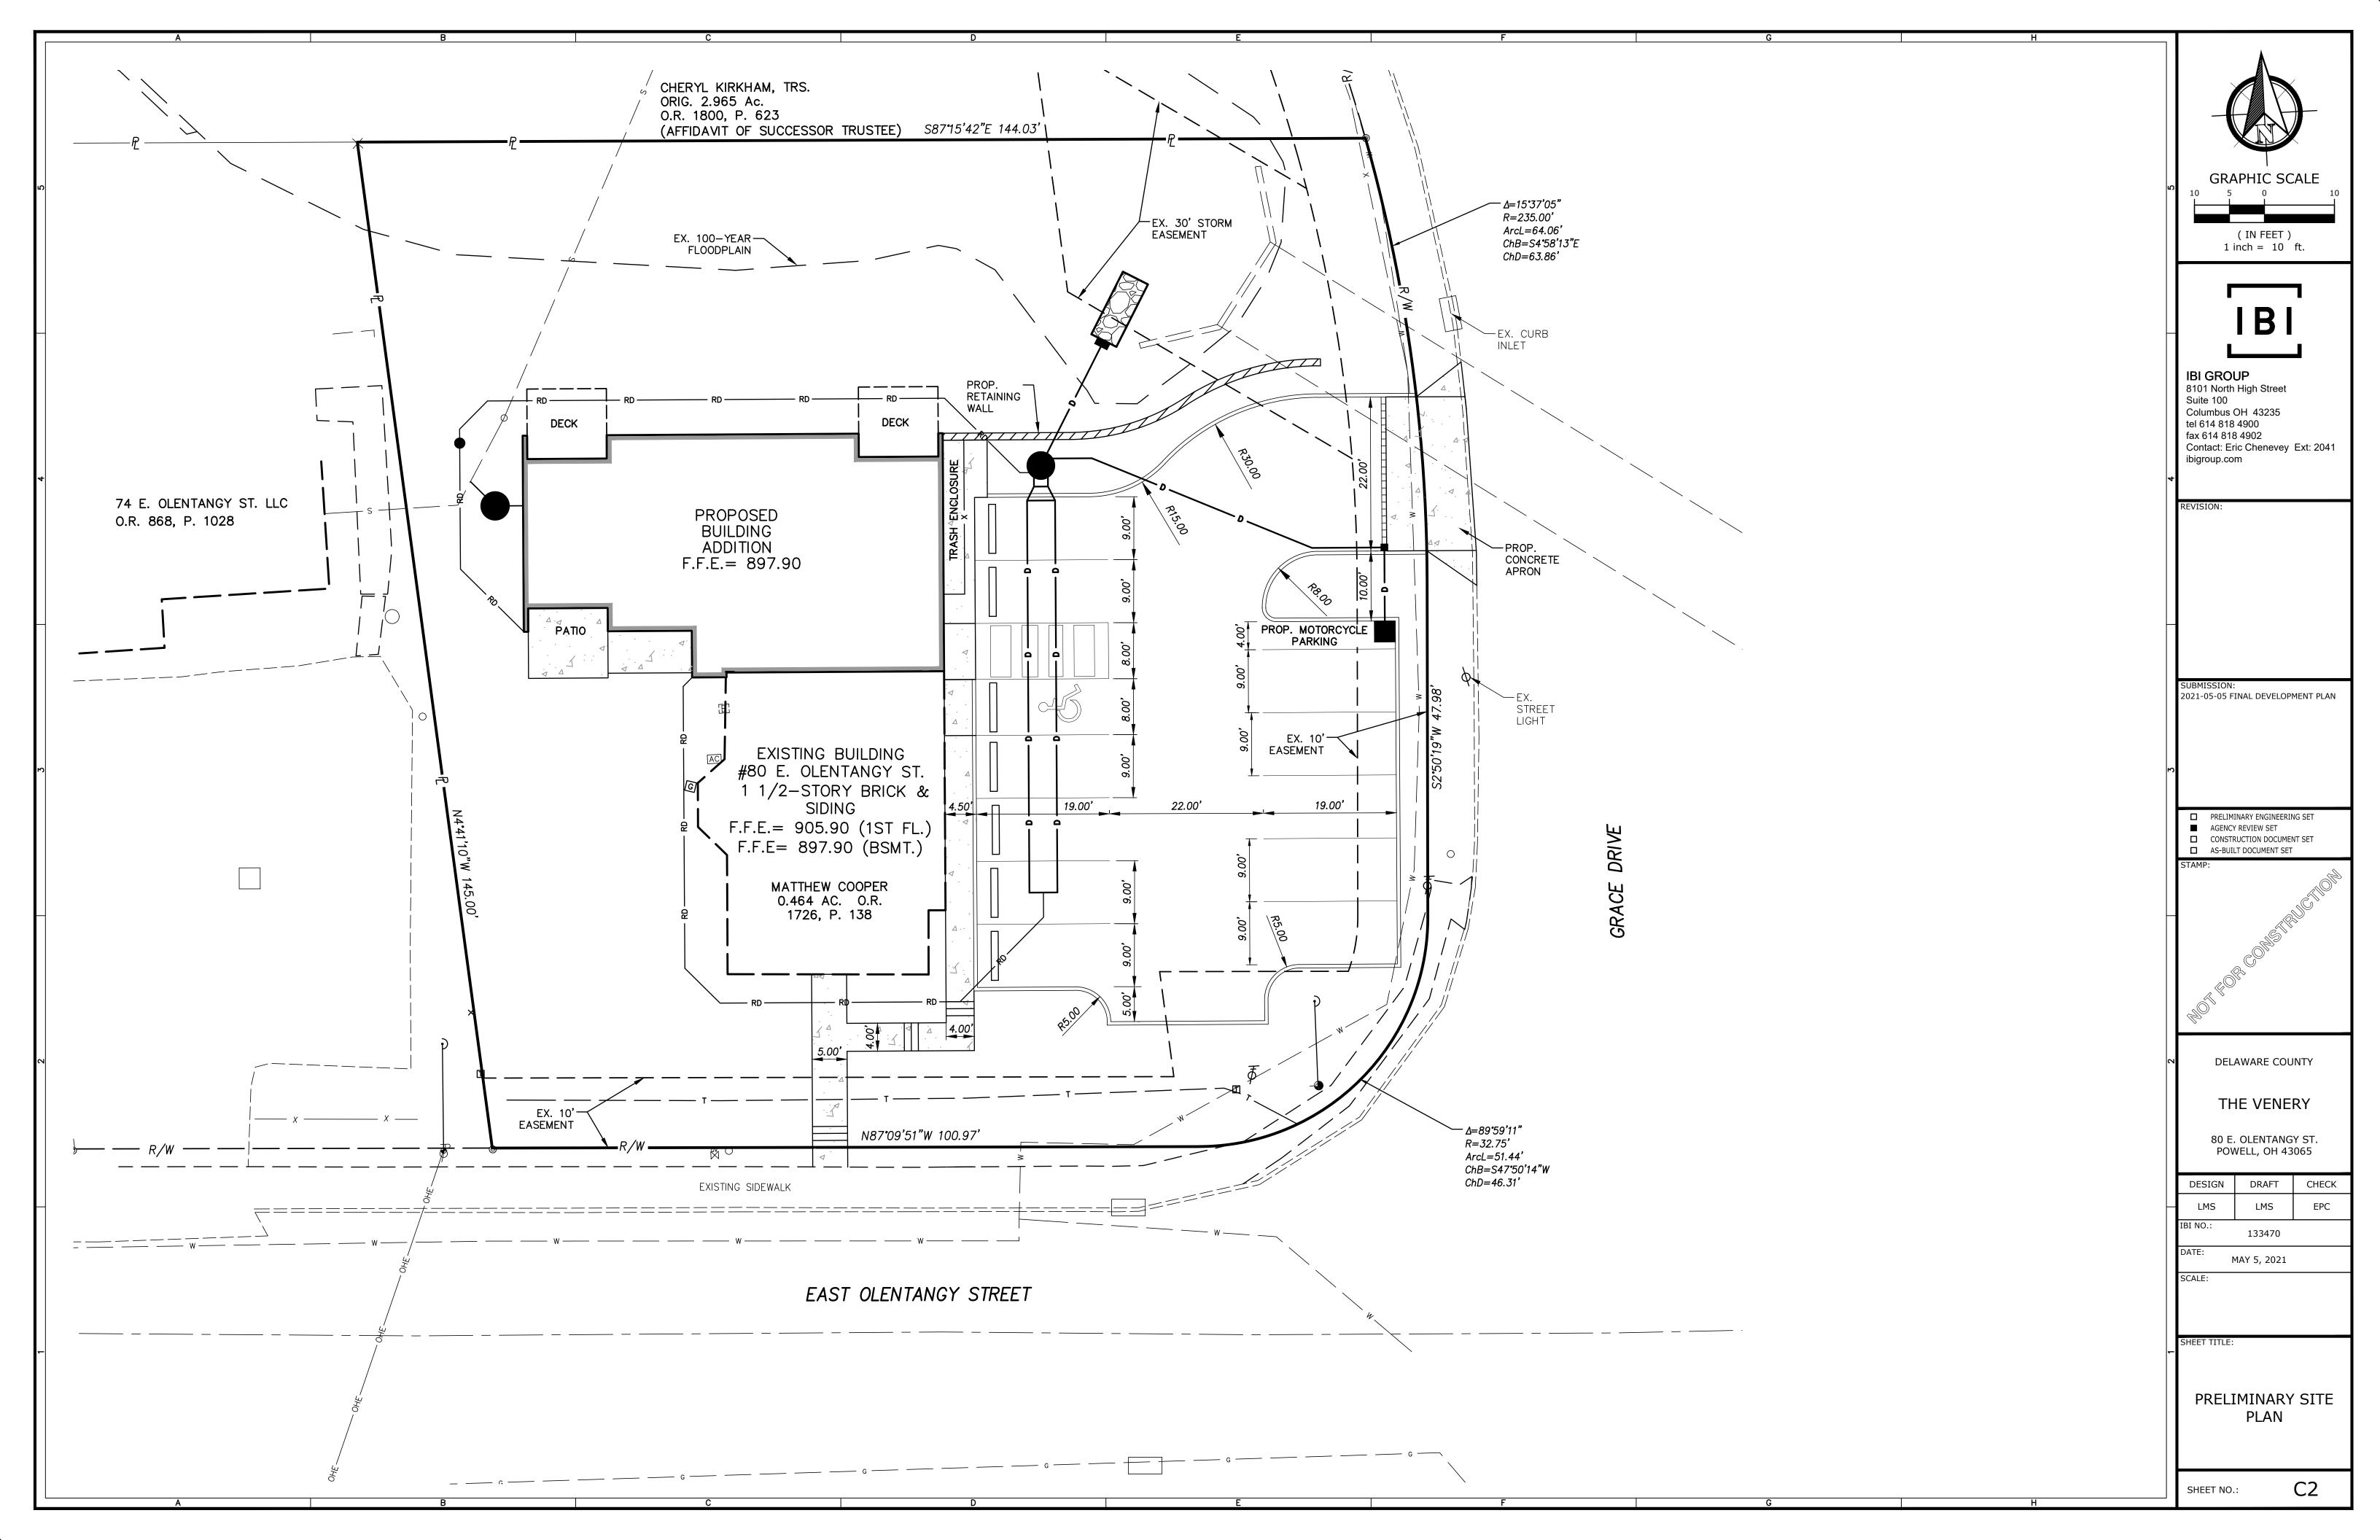SOUTHWEST FACADE PERSPECTIVE VIEW
12" = 1'-0"

6" - 9" T x 6" - 12" W

SOUTH FACADE PERSPECTIVE VIEW
12" = 1'-0"



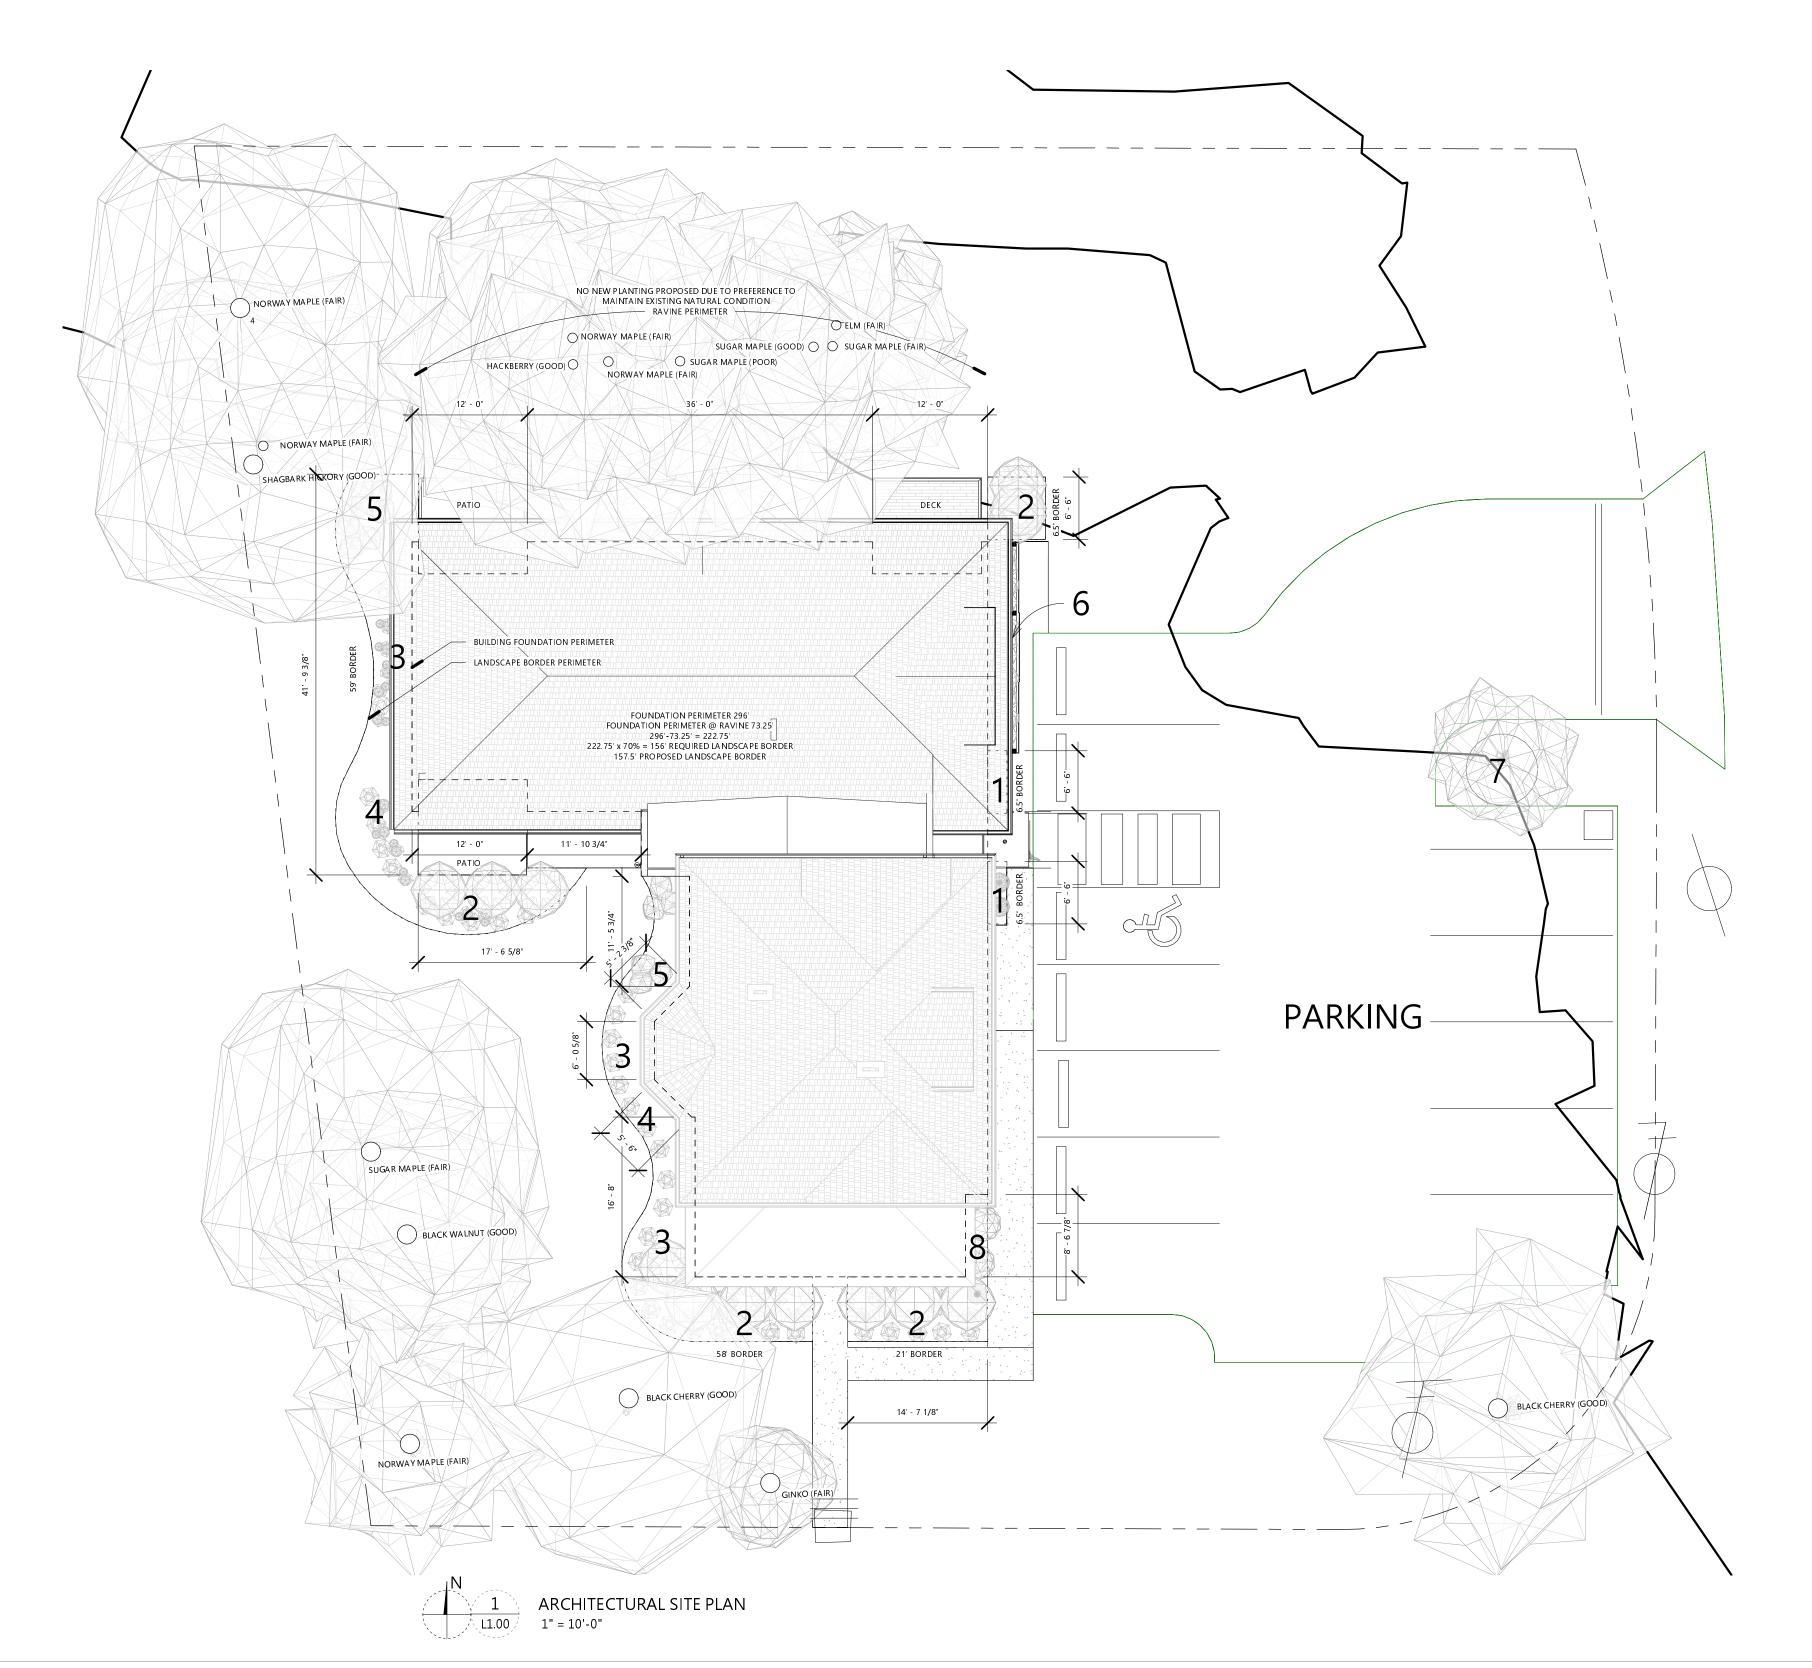

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80 E
OLENTANGY
POWELL, OHIO 43065

PROJECT NO. SJM_2010

ISSUE FINAL P&Z APPLICATION

ISSUE DATE 05.06.2021

LANDSCAPE


SHEET NO.

SHEET TITLE

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DEMOLITION NOTES

- THE GENERAL CONTRACTOR SHALL BE RESPONSIBLE FOR VERIFYING THE EXTENT OF DEMOLITION REQUIRED TO EXECUTE THE NEW WORK. THE AMOUNT OF DEMOLITION AND
- DISRUPTION SHOULD BE KEPT TO A MINIMUM. CONSULT OWNER TO VERIFY PROJECT SALVAGE REQUIREMENTS OF ITEMS NOT IDENTIFIED FOR REUSE HERE PRIOR TO REMOVAL
- OWNER SHALL BE RESPONSIBLE FOR THE REMOVAL OR RELOCATION OF EXISTING UNFIXED FURNITURE, FURNISHINGS AND EQUIPMENT IN THE AREAS OF THE WORK PRIOR TO COMMENCEMENT OF CONSTRUCTION. GENERAL CONTRACTOR SHALL BE RESPONSIBLE FOR OTHER REMOVALS AND RELOCATIONS AS INDICATED ON THE DRAWINGS AND/OR DIRECTED BY THE OWNER.
- ALL MATERIALS AND FINISHES INTENDED TO REMAIN SHALL BE PROTECTED FROM DAMAGE.
- ALL SALVAGED ITEMS SHALL BE SAFELY STORED ON THE PREMISES IN AN AREA DETERMINED BY THE OWNER.
- THE GENERAL CONTRACTOR SHALL COORDINATE ALL DISCONNECTIONS AND SHUT DOWNS THAT MAY BE REQUIRED FOR DEMOLITION AND CONSTRUCTION.

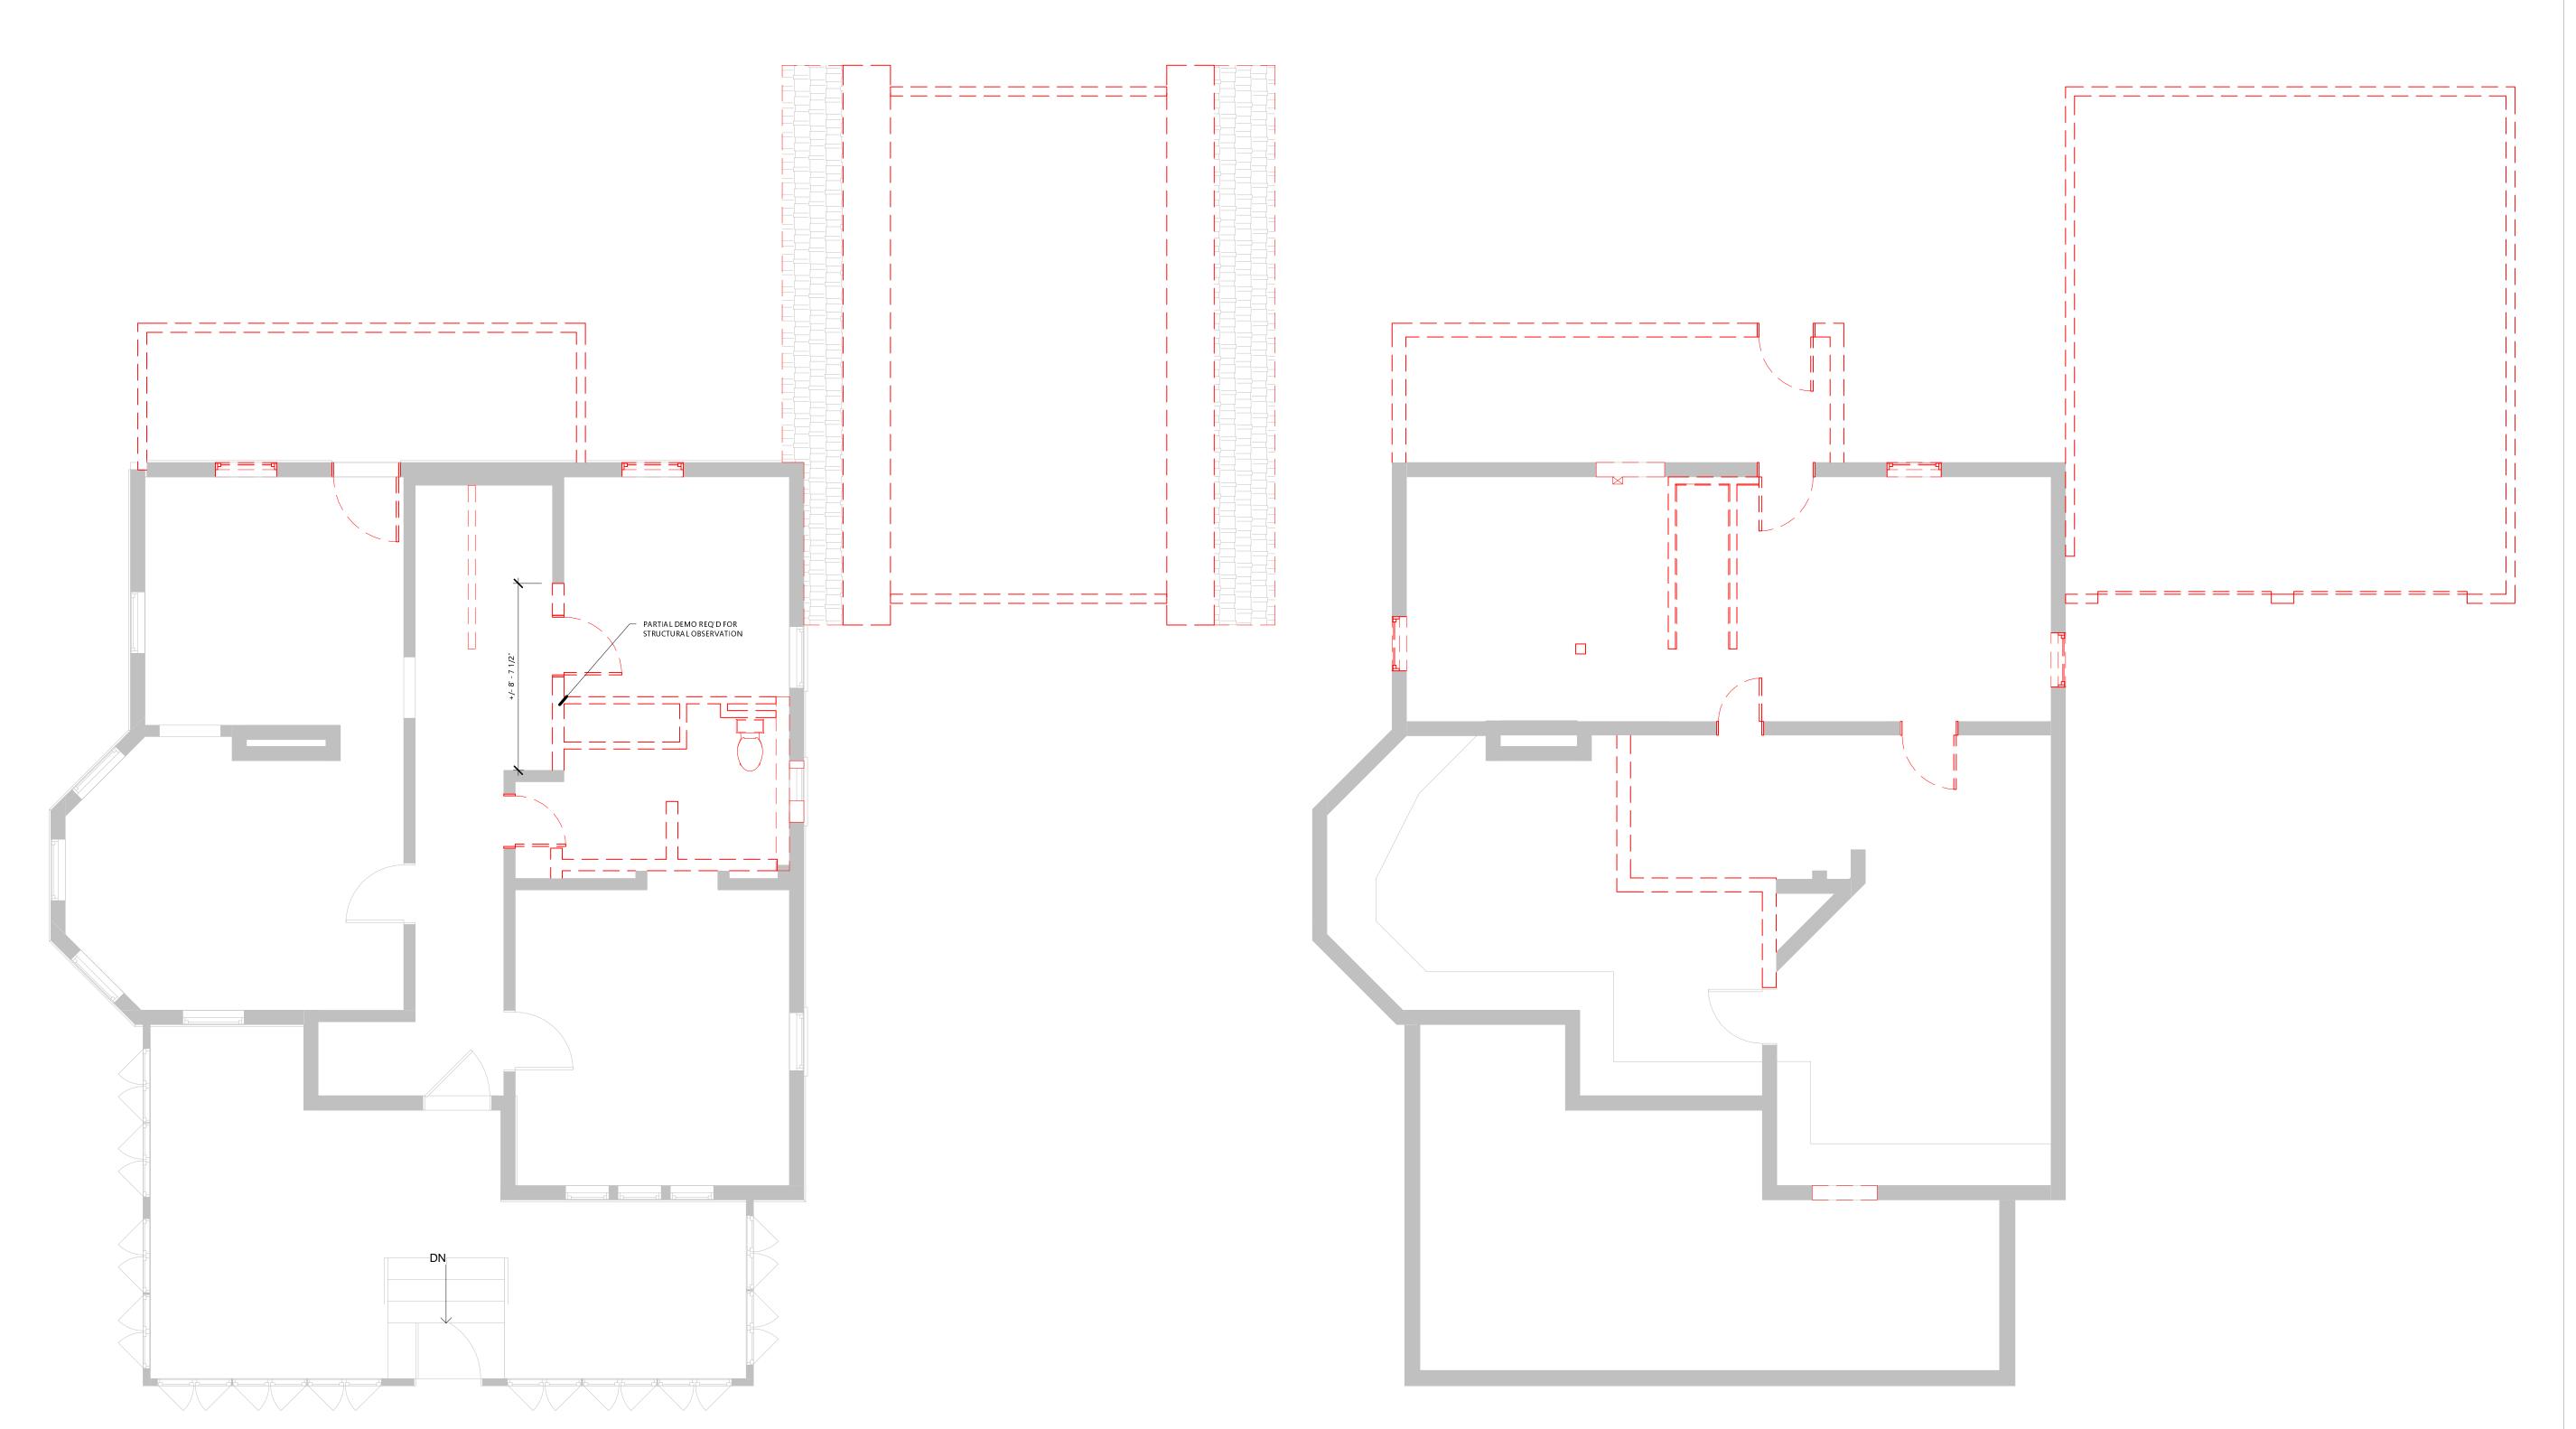

LEVEL 1 DEMOLITION PLAN
1/4" = 1'-0"

BASEMENT DEMOLITION PLAN
1/4" = 1'-0"

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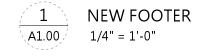
80 E **OLENTANGY** POWELL, OHIO 43065

PROJECT NO. SJM_2010 ISSUE FINAL P&Z APPLICATION ISSUE DATE

SHEET TITLE

BASEMENT + LEVEL 1 **DEMOLITION**

PLANS SHEET NO.



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 SEE G1.02 G1.03 FOR EXTENTS AND TECHNICAL
- SEE G1.02 G1.03 FOR EXTENTS AND TECHNICAL DETAILS OF FIRE-RATED BARRIERS, FIRE-RATED PARTITIONS AND SHAFT WALLS.
- SEE G1.04 FOR UL ASSEMBLIES.
 SEE G1.10 FOR TYPICAL ACCESSIBLE CLEARANCES AND DETAILS.
- 5. EXTERIOR DIMENSIONS ARE TO FACE OF FOUNDATION, FACE OF MASONRY OR FACE OF SHEATHING UNO.
- 6. INTERIOR DIMENSIONS ARE TO FACE OF STUD UNO.
 7. VERIFY ALL DIMENSIONS PRIOR TO BEGINNING WORK AND NOTIFY ARCHITECT FOR RESOLUTION OF ANY DISCREPANCIES.
- 8. EXTEND FIRE BARRIERS TO UNDERSIDE OF DECK ABOVE UNO.
- 9. PROVIDE SOUND BATT INSULATION AT ALL TOILET ROOMS AND MECHANICAL ROOMS.
- 10. PROVIDE 5/8" CEMENT BACKER BOARD AT ALL TILE WALL LOCATIONS W/ BLOCKING BEHIND ALL CEMENT BACKER BOARD SEAMS.
- PROVIDE 5/8" MOISTURE RESISTANT GWB AT ALL WET WALL LOCATIONS.
- 2. COMPLY WITH MANUFACTURER INSTRUCTIONS FOR INSTALLATION OF BUILDING MATERIALS AND FF&E.
- 13. LOCATION AND SIZE OF PENETRATIONS/MEMBRANE PENETRATIONS OF FIRE-RATED ASSEMBLIES ARE APPROXIMATE. GC TO FIELD VERIFY SIZE AND LOCATION.
- 14. CONSULT OWNER TO VERIFY PROJECT SALVAGE REQUIREMENTS OF ITEMS NOT IDENTIFIED FOR REUSE HERE PRIOR TO REMOVAL START.
- 15. PROTECT EXISTING ORIGINAL ARCHITECTURE
 THROUGHOUT INCLUDING WINDOWS, DOORS, MISC.
 GLASS, CASEWORK, MILLWORK, STAIRS, RAILINGS,
 HARDWARE AND (TO THE GREATEST EXTENT
 POSSIBLE) PLASTER.
 - COMMERCIAL SPACE SCOPE:

 A. GC TO PROVIDE "WARM GRAY BOX INCLUDING PLUMBING ROUGH-INS, ELECTRICAL SERVICE, TEMPORARY HEAT, LEVEL 4 FINISH ALL GWB SURFACES

FLOOR PLAN NOTES

NO. NO

EXTG. VENTILATION OPENINGS IN CRAWL SPACE

FOUNDATION WALL, TYP. OF (3)

REMOVE EXTG. STONE MASONRY AS REQ'D TO PROVIDE NEW SECURE, INSULATED CRAWL SPACE ACCESS PANEL.

EXTG. SPLIT SYSTEM AHU TO REMAIN. RECONFIGURE EXTG. DUCTWORK AS REQ'D TO ACCOMODATE OVERHEAD CLEARANCE IN BASEMENT ROOM 1 AND 2 PROVIDE NEW OPENING IN EXTG. LOAD BEARING

MASONRY WALL
PROVIDE NEW 4" CONC. SLAB THROUGHOUT BASEMENT
PROVIDE NEW 8" DOUBLE WYTHE BRICK MASONRY

PROVIDE NEW 8" DOUBLE WYTHE BRICK MASONRY WALL ON 16" WIDE X 8" DEEP REINFOCED CONC.
FOOTER AS INDICATED

MAINTAIN AS EMERGENCY EGRESS OPENING
NEW 90 MINUTE FIRE-RATED DOOR IN EXTG. OPENING

INFILL EXTG. WINDOW OPENING W/ MASONRY TO MATCH EXTG.
INFILL EXTG. DOOR OPENING W/ MASONRY TO MATCH

12 GLASS GUARDRAIL, 42"

65 GALLON REFUSE / RECYCLING TOTES AND/OR LAWNCARE AND MAINTENANCE STORAGE CONCEALED IN REFUSE ENCLOSURE

6 MAINTAIN AS EMERGENCY EGRESS OPENING

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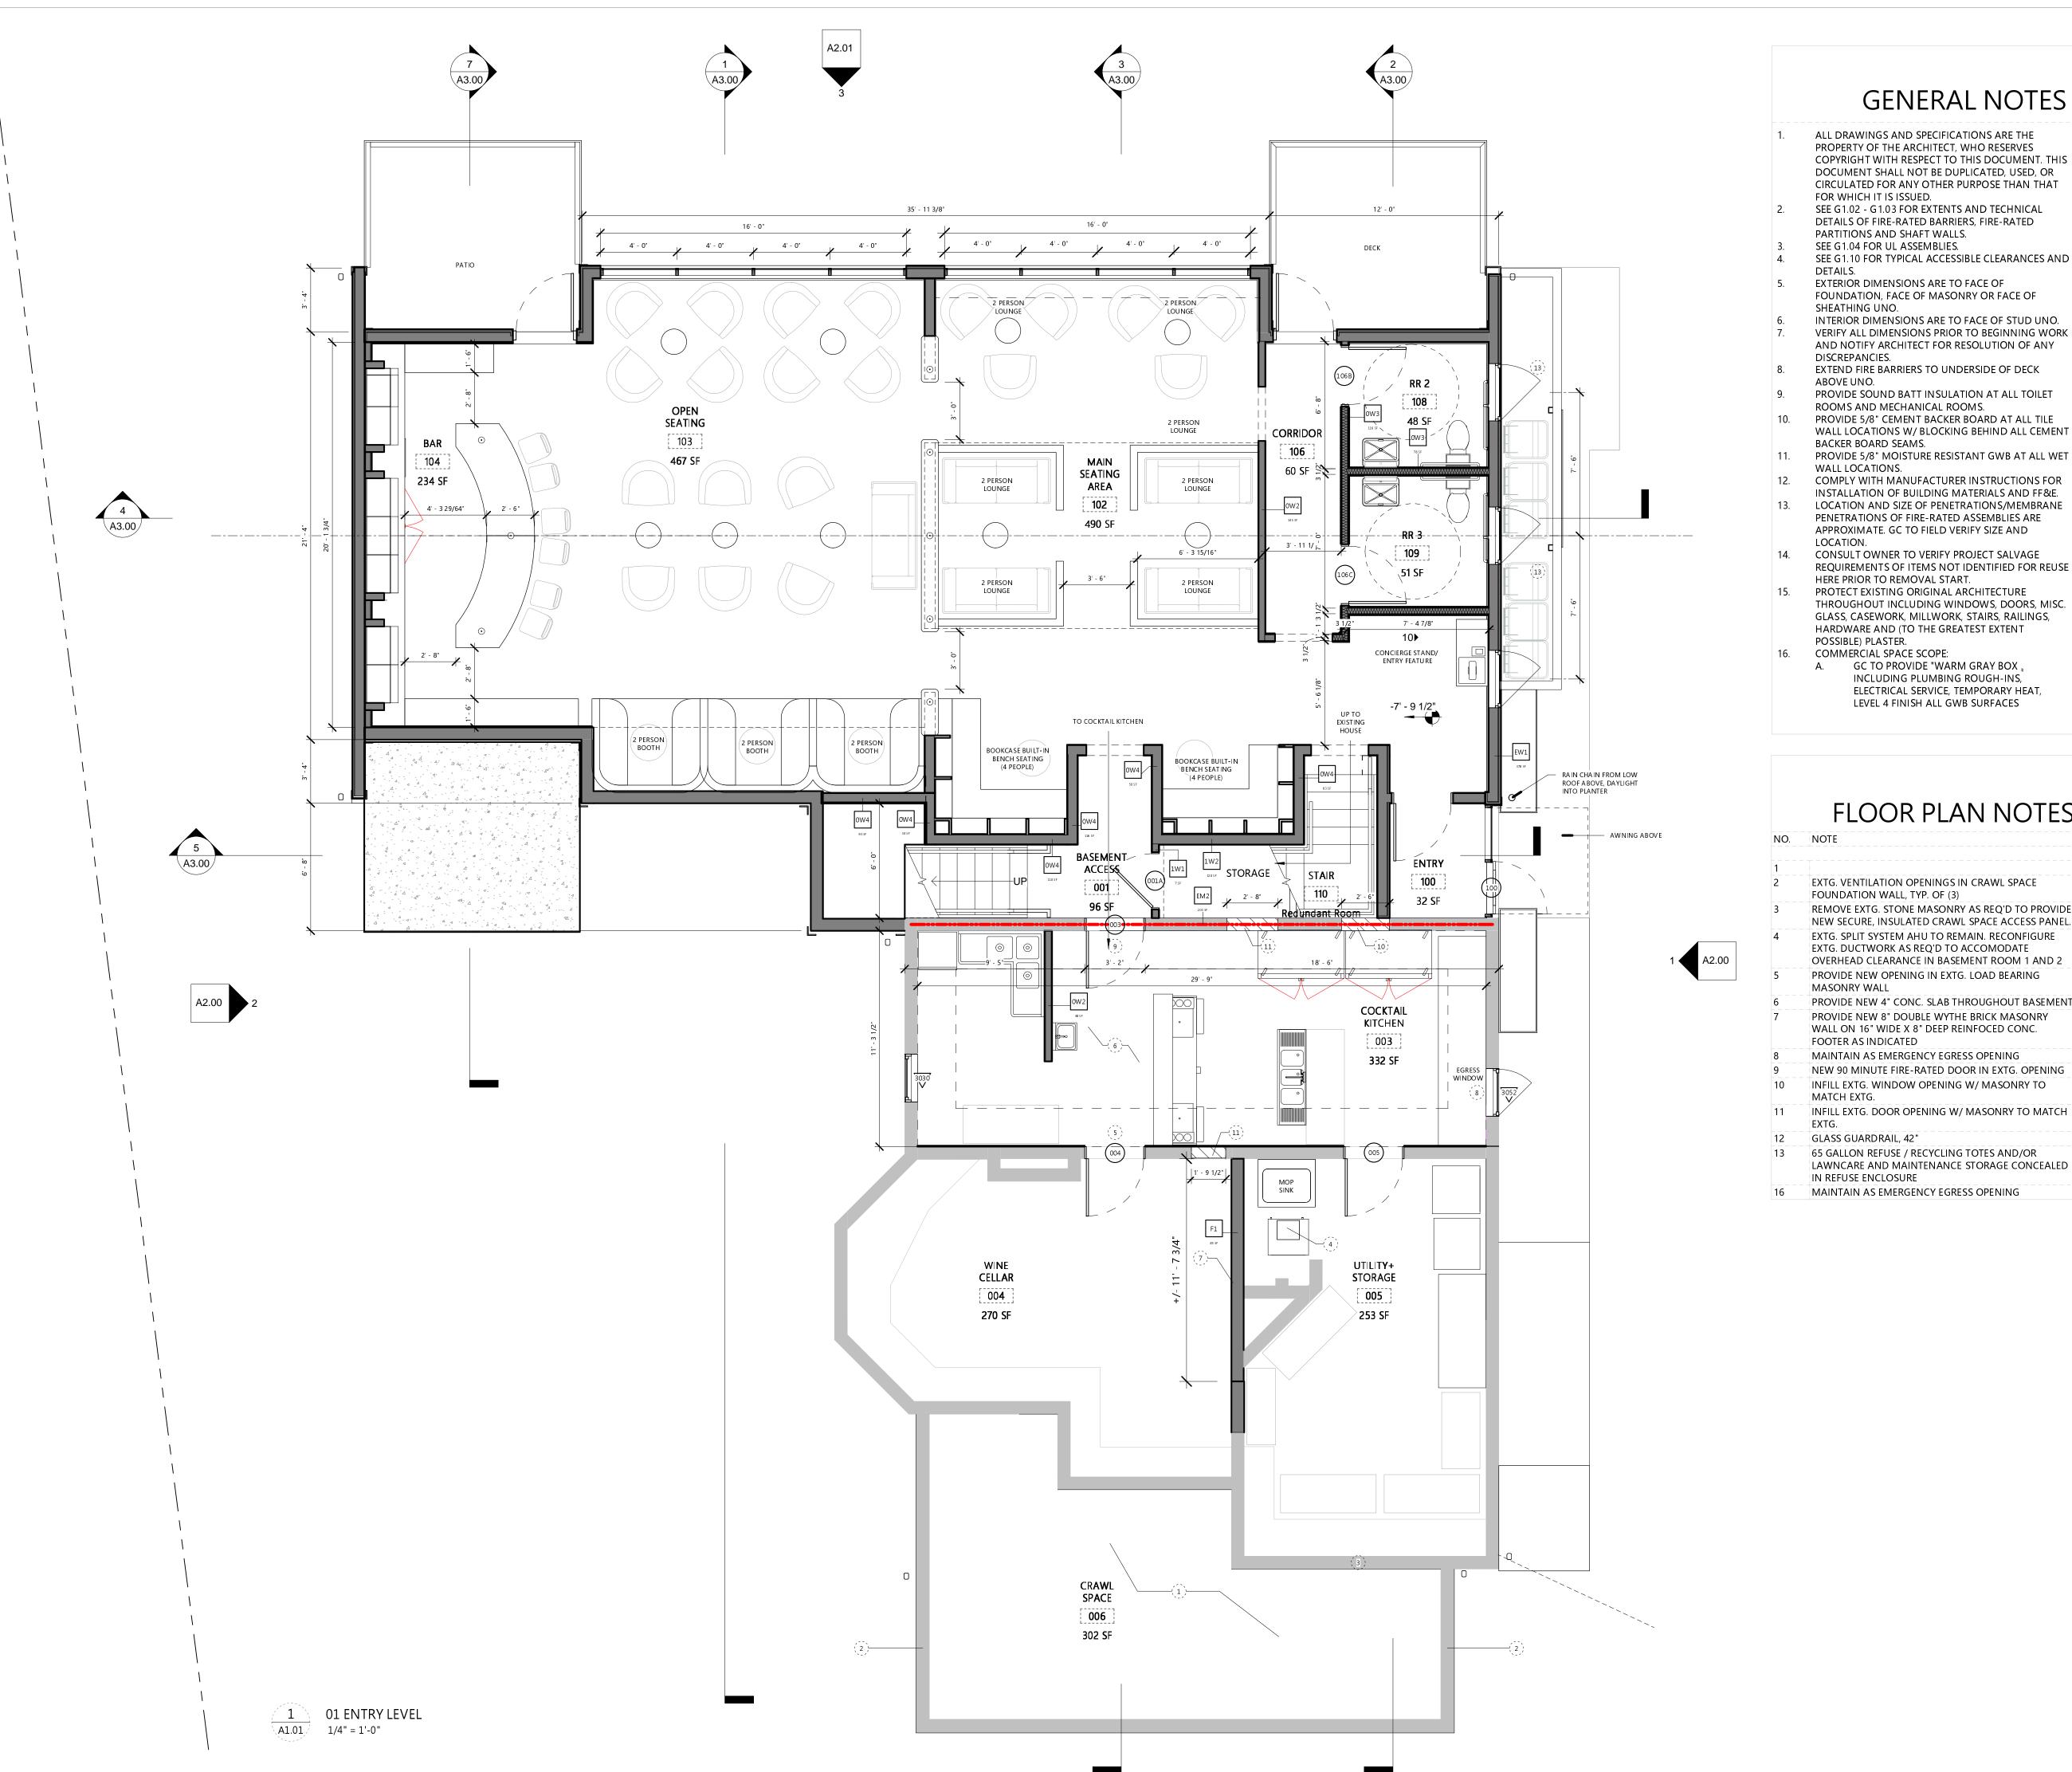
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FOUNDATION

PLAN

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DETAILS OF FIRE-RATED BARRIERS, FIRE-RATED PARTITIONS AND SHAFT WALLS.

SEE G1.10 FOR TYPICAL ACCESSIBLE CLEARANCES AND

EXTERIOR DIMENSIONS ARE TO FACE OF FOUNDATION, FACE OF MASONRY OR FACE OF

INTERIOR DIMENSIONS ARE TO FACE OF STUD UNO. VERIFY ALL DIMENSIONS PRIOR TO BEGINNING WORK AND NOTIFY ARCHITECT FOR RESOLUTION OF ANY

EXTEND FIRE BARRIERS TO UNDERSIDE OF DECK

PROVIDE SOUND BATT INSULATION AT ALL TOILET ROOMS AND MECHANICAL ROOMS.

PROVIDE 5/8" CEMENT BACKER BOARD AT ALL TILE WALL LOCATIONS W/ BLOCKING BEHIND ALL CEMENT

PROVIDE 5/8" MOISTURE RESISTANT GWB AT ALL WET

INSTALLATION OF BUILDING MATERIALS AND FF&E. LOCATION AND SIZE OF PENETRATIONS/MEMBRANE PENETRATIONS OF FIRE-RATED ASSEMBLIES ARE

CONSULT OWNER TO VERIFY PROJECT SALVAGE REQUIREMENTS OF ITEMS NOT IDENTIFIED FOR REUSE

PROTECT EXISTING ORIGINAL ARCHITECTURE THROUGHOUT INCLUDING WINDOWS, DOORS, MISC. GLASS, CASEWORK, MILLWORK, STAIRS, RAILINGS, HARDWARE AND (TO THE GREATEST EXTENT

GC TO PROVIDE "WARM GRAY BOX , INCLUDING PLUMBING ROUGH-INS, ELECTRICAL SERVICE, TEMPORARY HEAT, LEVEL 4 FINISH ALL GWB SURFACES

FLOOR PLAN NOTES

EXTG. VENTILATION OPENINGS IN CRAWL SPACE

REMOVE EXTG. STONE MASONRY AS REQ'D TO PROVIDE NEW SECURE, INSULATED CRAWL SPACE ACCESS PANEL. EXTG. SPLIT SYSTEM AHU TO REMAIN. RECONFIGURE EXTG. DUCTWORK AS REQ'D TO ACCOMODATE

PROVIDE NEW OPENING IN EXTG. LOAD BEARING PROVIDE NEW 4" CONC. SLAB THROUGHOUT BASEMENT PROVIDE NEW 8" DOUBLE WYTHE BRICK MASONRY

WALL ON 16" WIDE X 8" DEEP REINFOCED CONC. MAINTAIN AS EMERGENCY EGRESS OPENING

INFILL EXTG. DOOR OPENING W/ MASONRY TO MATCH

65 GALLON REFUSE / RECYCLING TOTES AND/OR LAWNCARE AND MAINTENANCE STORAGE CONCEALED

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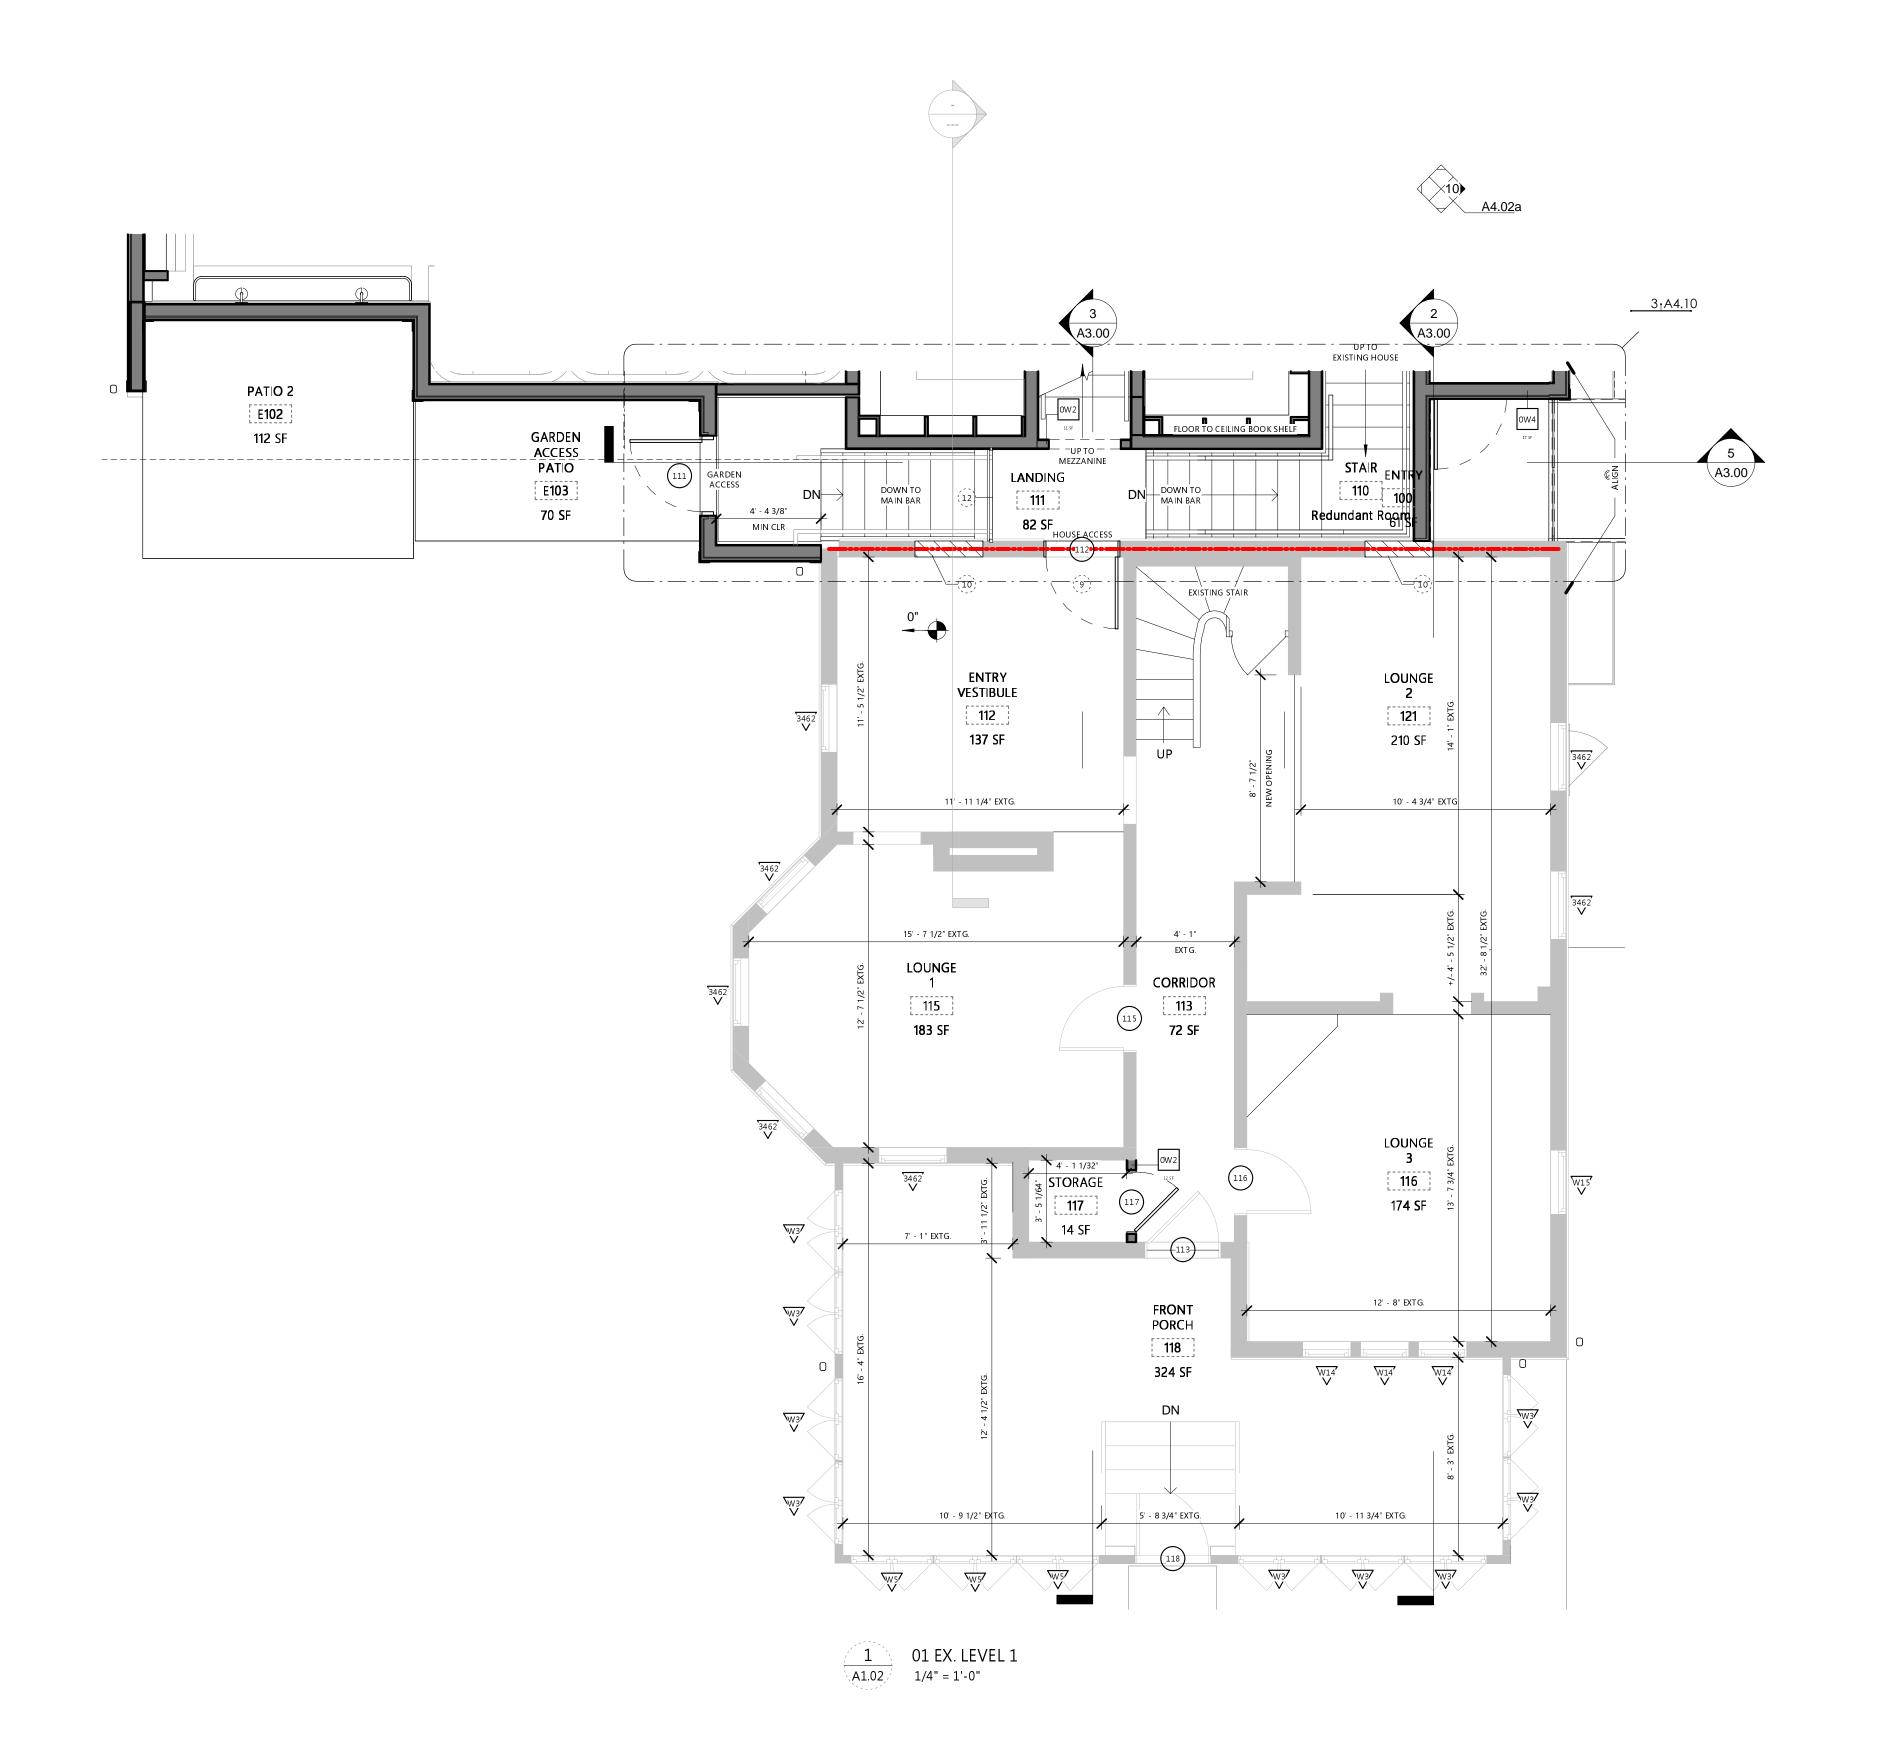
80 E **OLENTANGY** POWELL, OHIO 43065

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SHEET TITLE **EXTG. BASEMENT**

+ NEW LEVEL 1 **PLAN**

SHEET NO.



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FLOOR PLAN NOTES

NO. NOT

- EXTG. VENTILATION OPENINGS IN CRAWL SPACE
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- NEW 90 MINUTE FIRE-RATED DOOR IN EXTG. OPENING
 INFILL EXTG. WINDOW OPENING W/ MASONRY TO
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- 11 INFILL EXTG. DOOR OPENING W/ MASONRY TO MATCH EXTG.
- 12 GLASS GUARDRAIL, 42"
- 13 65 GALLON REFUSE / RECYCLING TOTES AND/OR LAWNCARE AND MAINTENANCE STORAGE CONCEALED IN REFUSE ENCLOSURE
- 16 MAINTAIN AS EMERGENCY EGRESS OPENING

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PROJECT NO. SJM_2010
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EXTG. LEVEL 1

PLAN

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FLOOR PLAN NOTES

EXTG. VENTILATION OPENINGS IN CRAWL SPACE FOUNDATION WALL, TYP. OF (3) REMOVE EXTG. STONE MASONRY AS REQ'D TO PROVIDE

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MAINTAIN AS EMERGENCY EGRESS OPENING NEW 90 MINUTE FIRE-RATED DOOR IN EXTG. OPENING INFILL EXTG. WINDOW OPENING W/ MASONRY TO

MATCH EXTG. INFILL EXTG. DOOR OPENING W/ MASONRY TO MATCH

GLASS GUARDRAIL, 42"

65 GALLON REFUSE / RECYCLING TOTES AND/OR LAWNCARE AND MAINTENANCE STORAGE CONCEALED IN REFUSE ENCLOSURE

16 MAINTAIN AS EMERGENCY EGRESS OPENING

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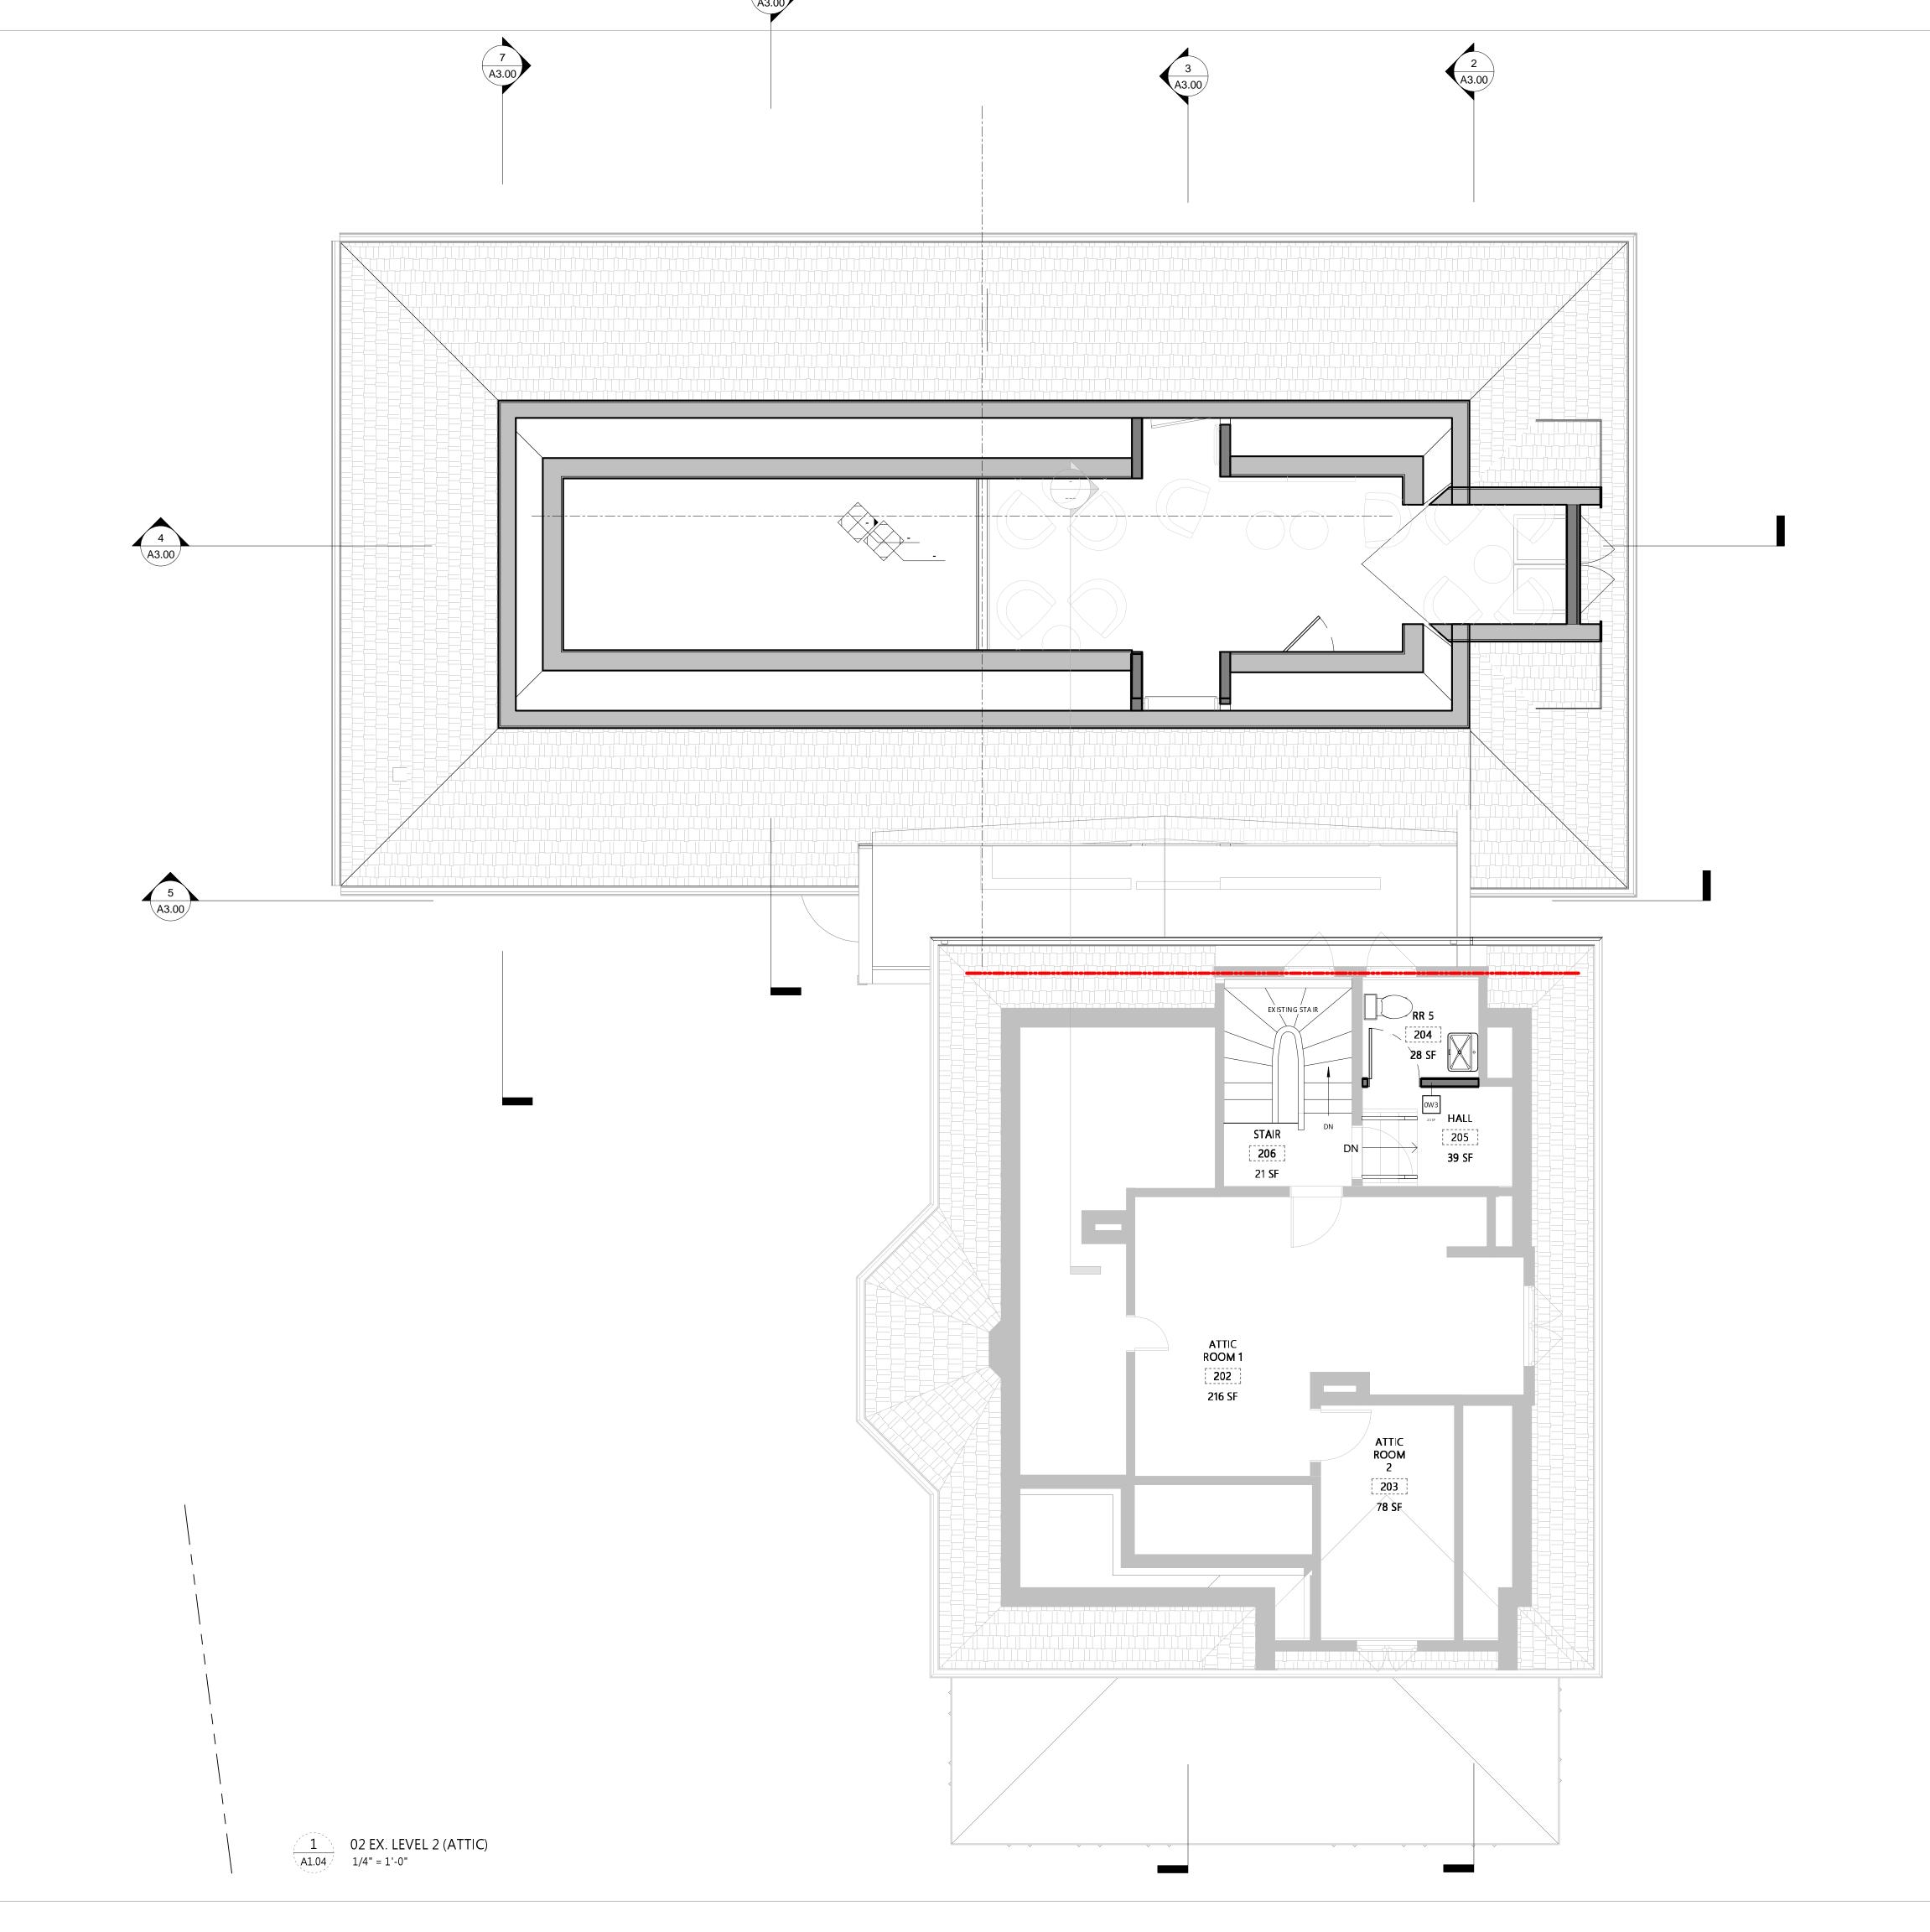
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PROJECT NO. SJM_2010 ISSUE FINAL P&Z APPLICATION **ISSUE DATE** 05.06.2021

SHEET TITLE NEW

MEZZANINE PLAN

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FLOOR PLAN NOTES

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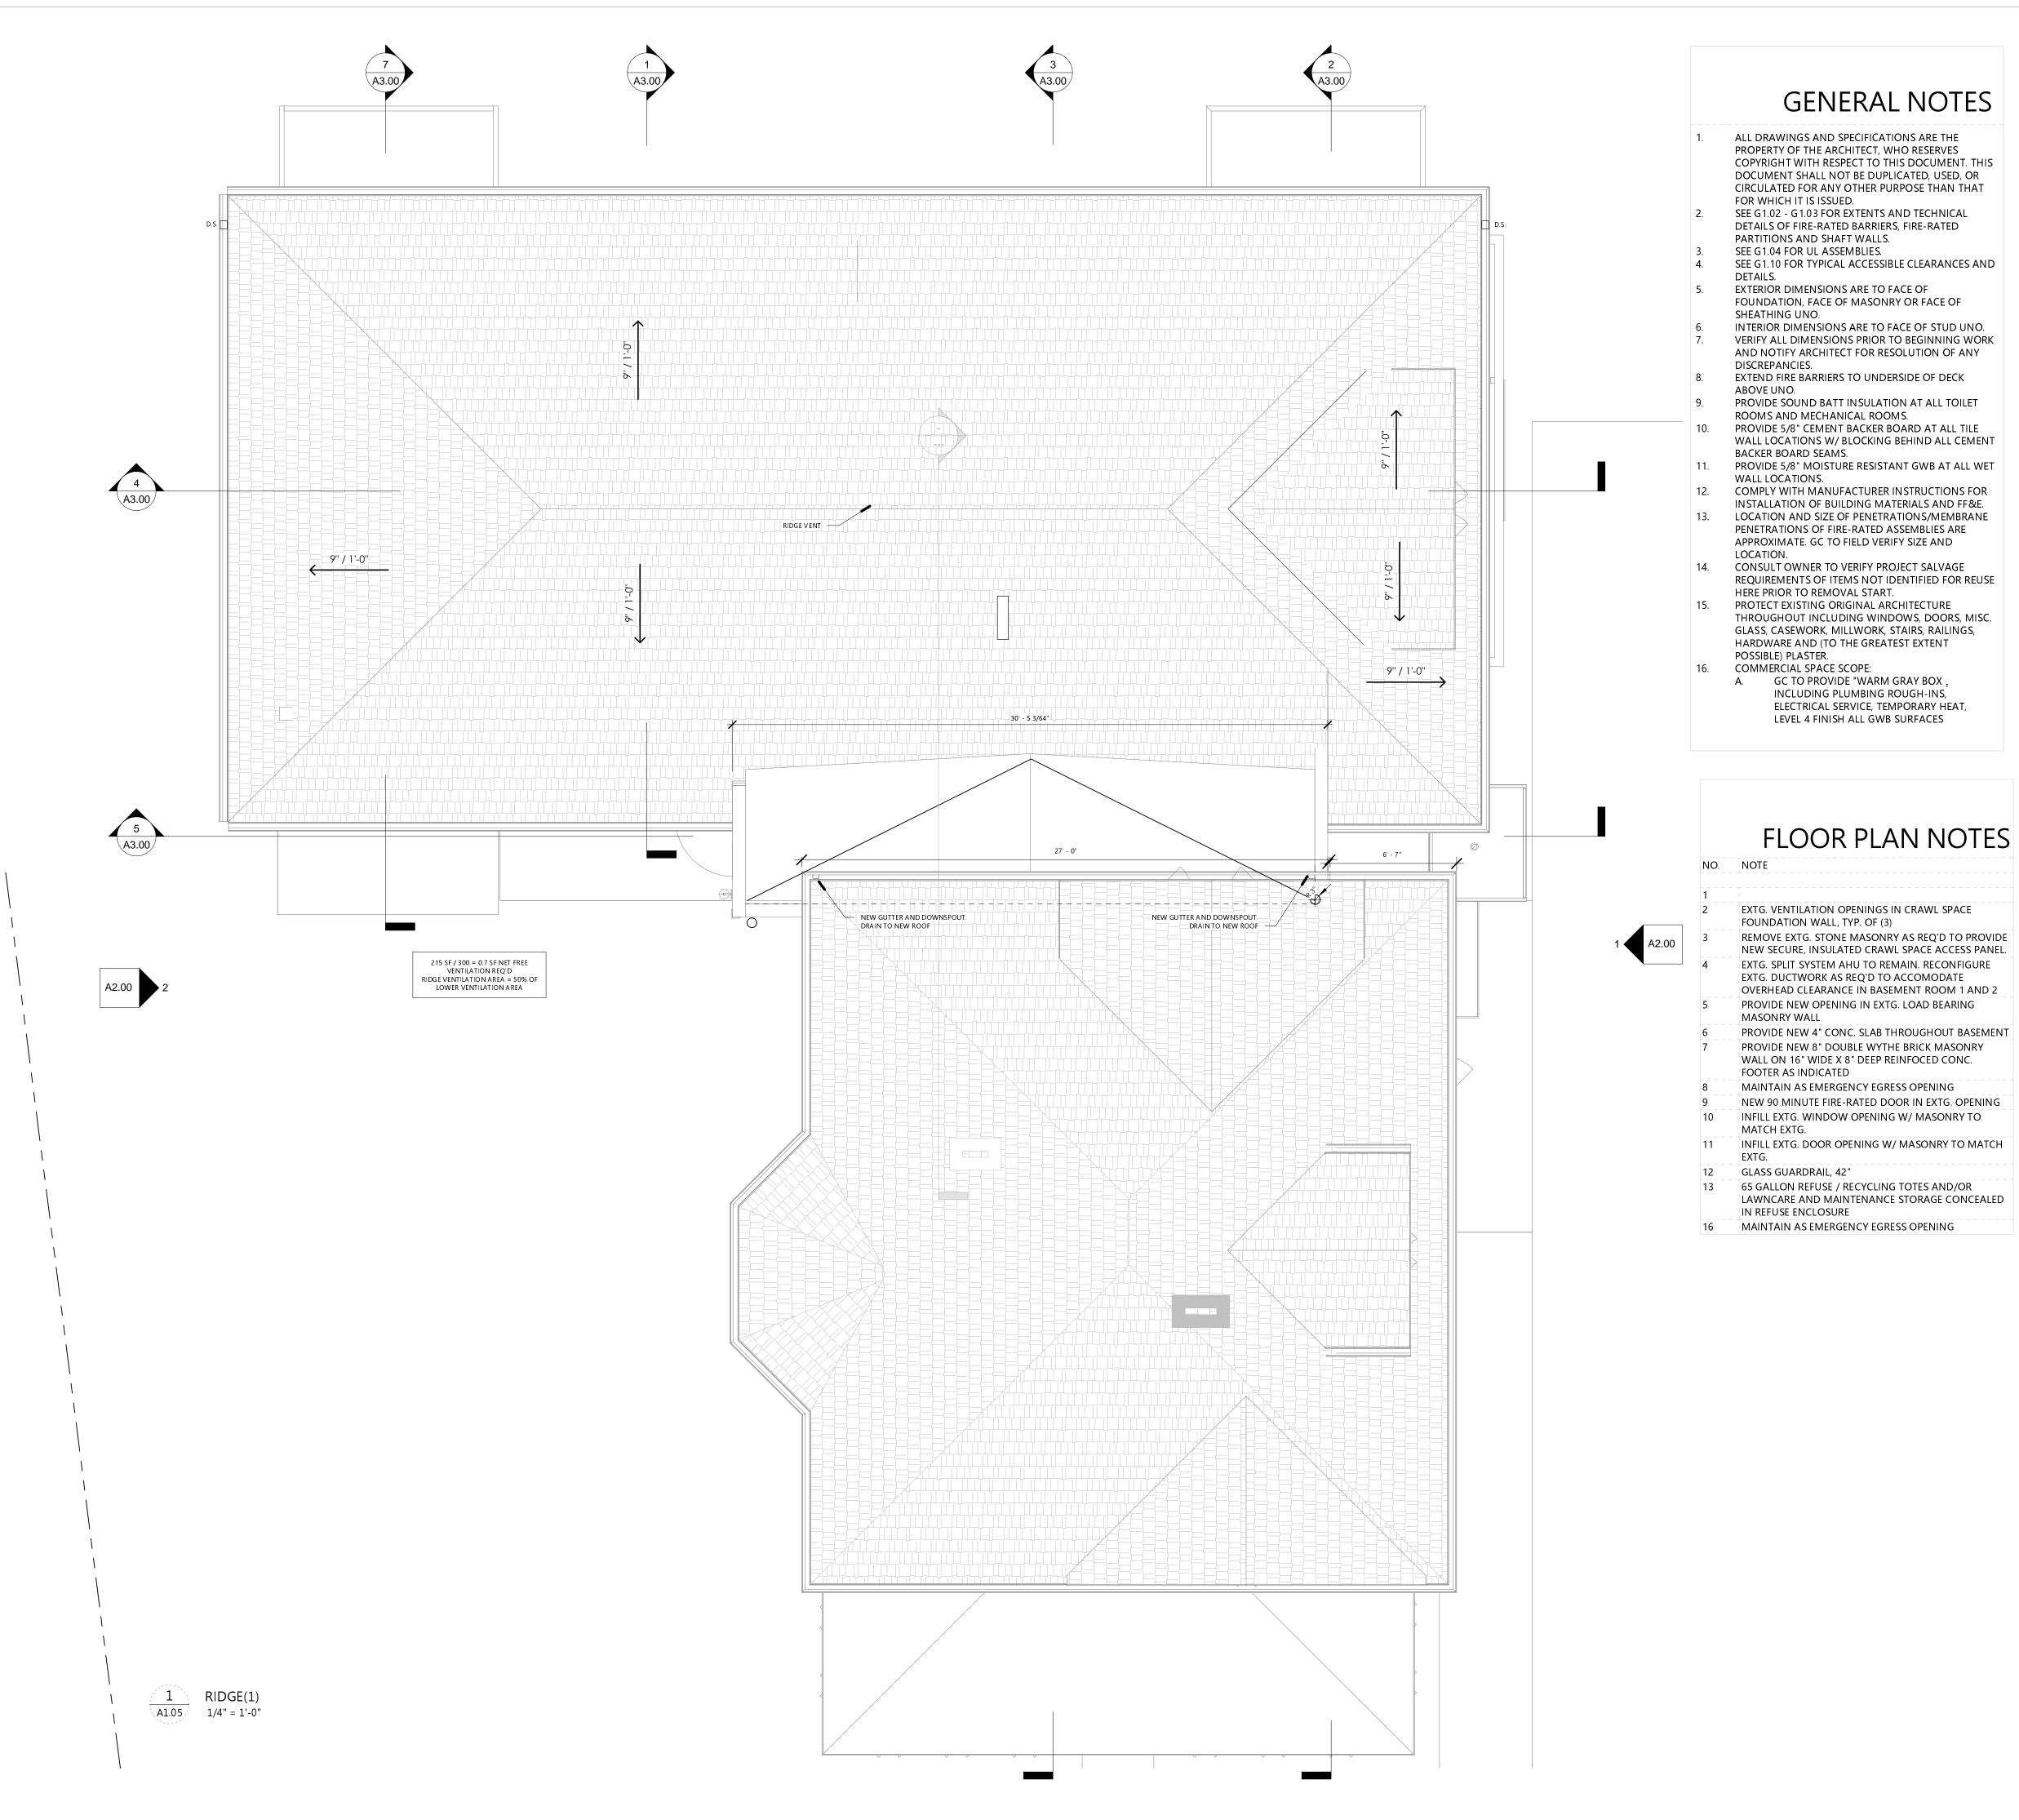
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SHEET NO.

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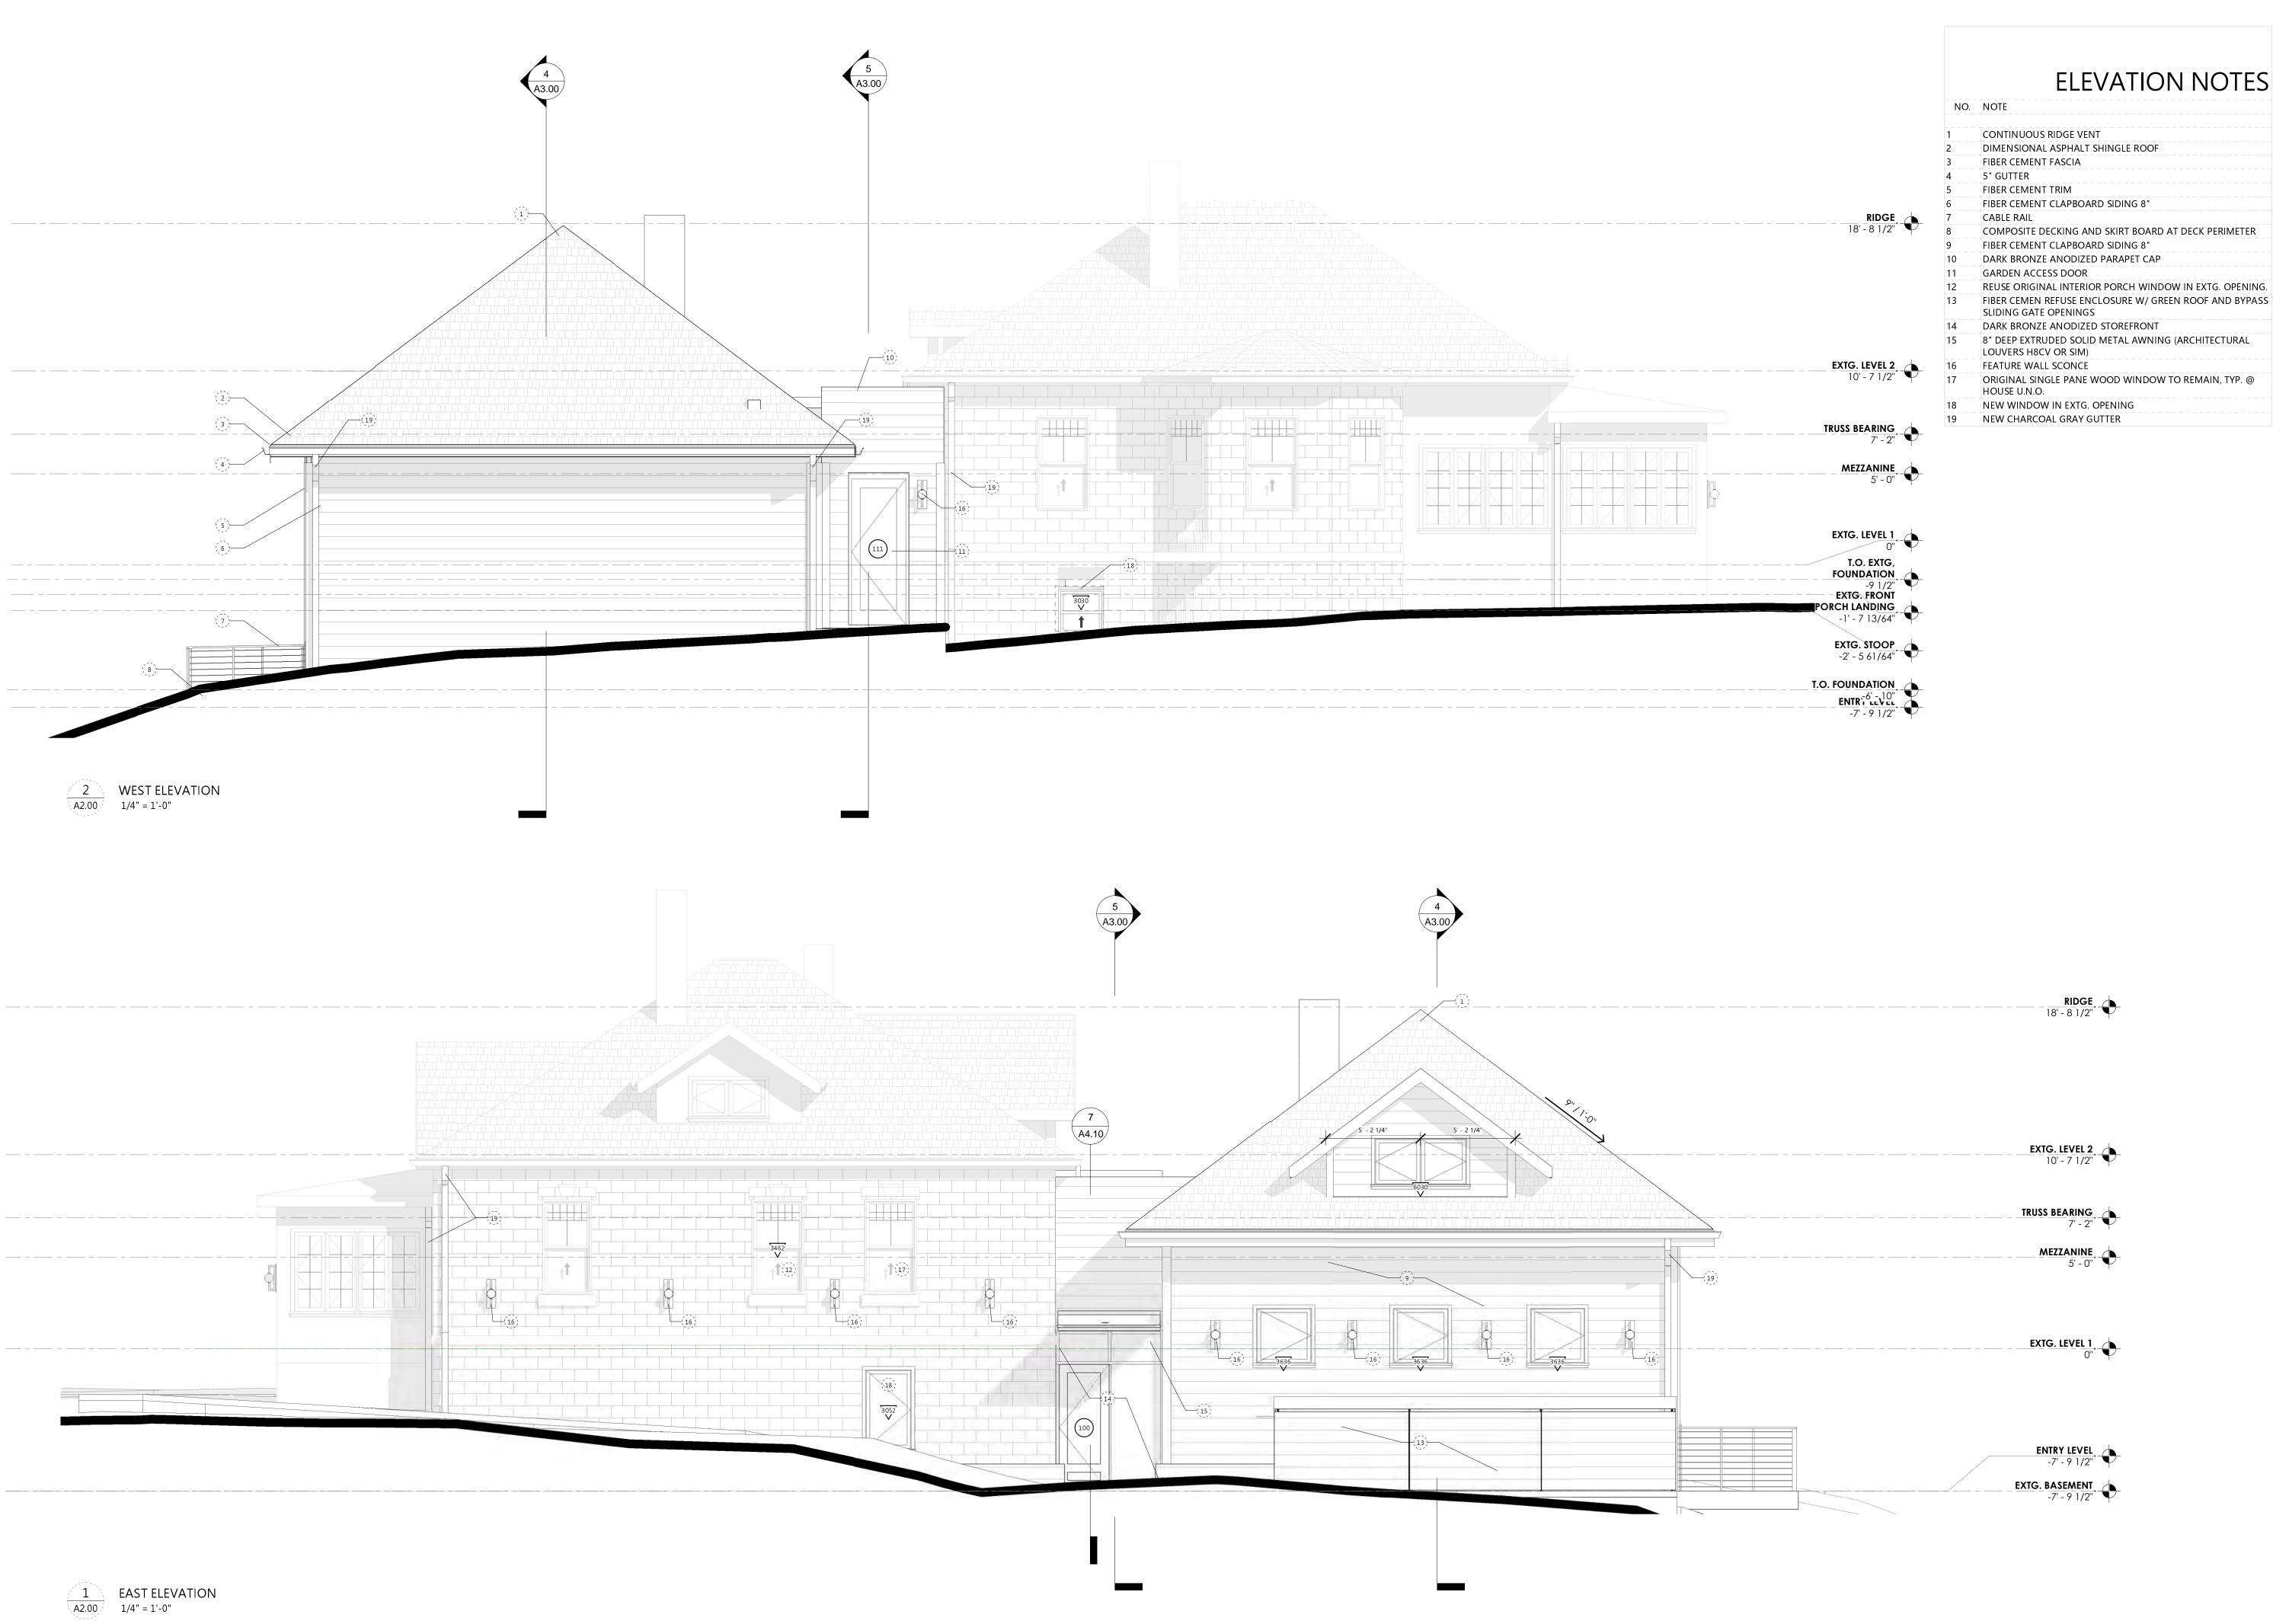
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SHEET TITLE

ROOF PLAN

SHEET NO.



ELEVATION NOTES

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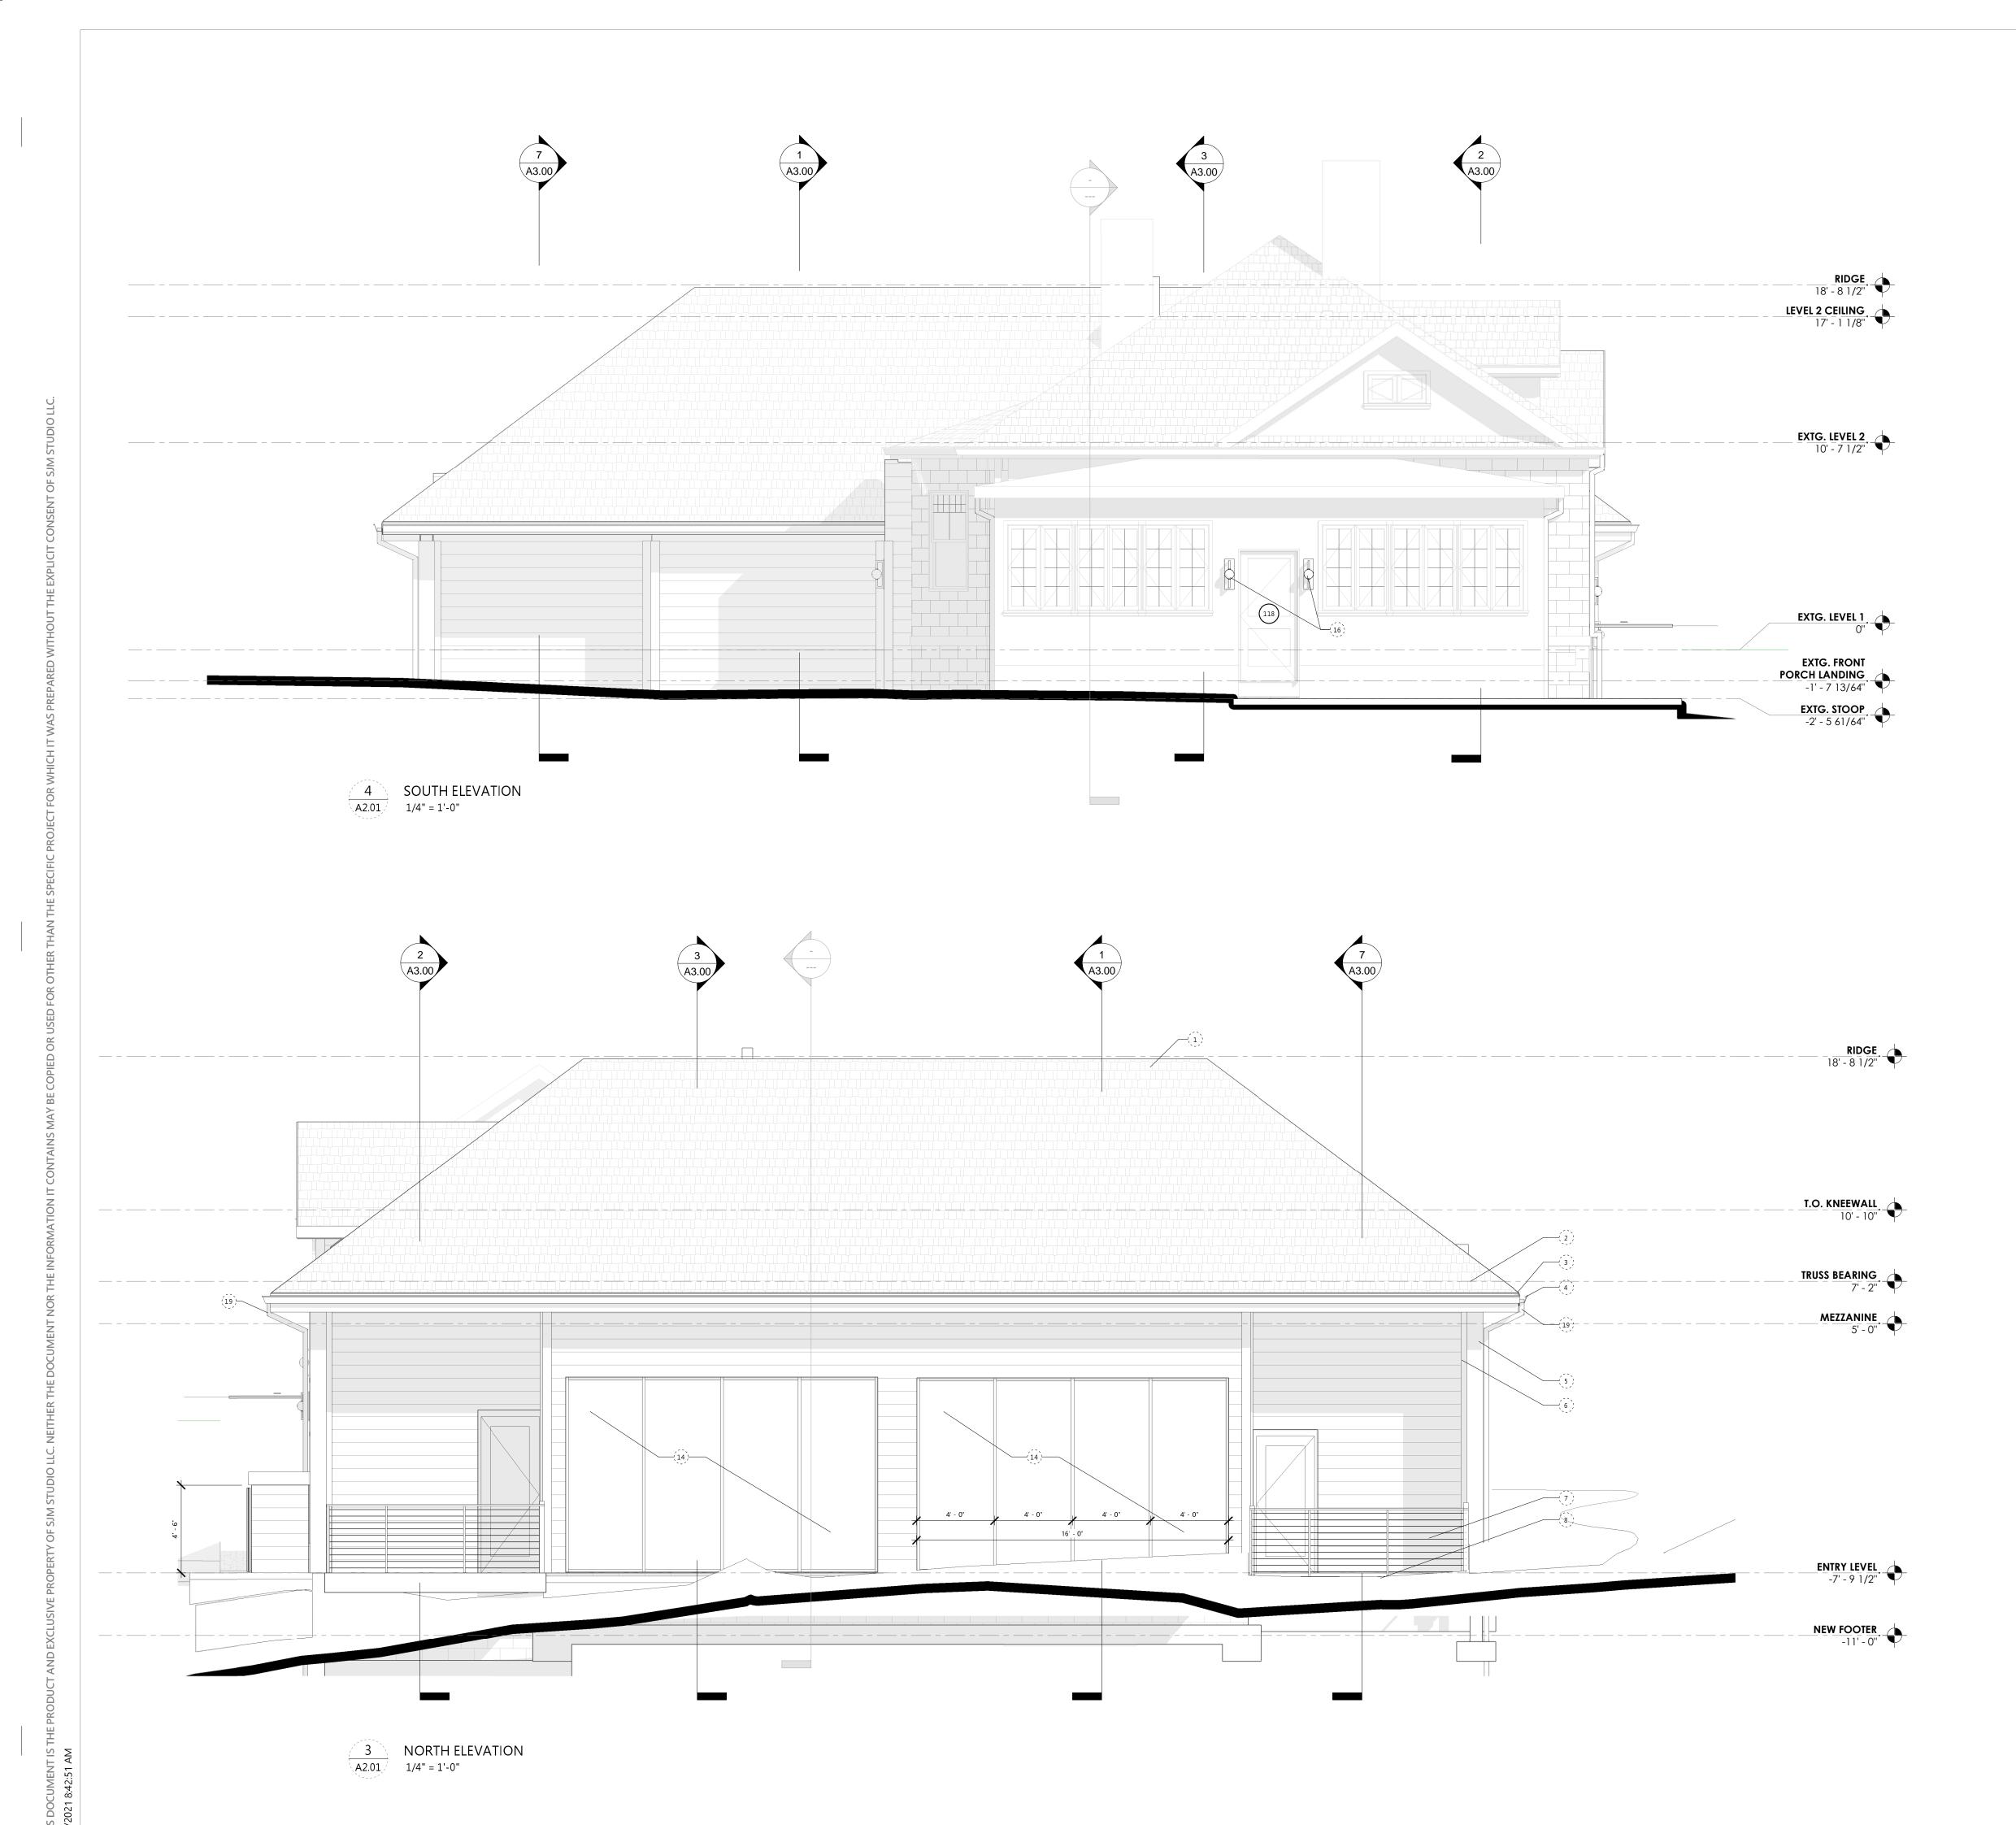
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ISSUE DATE 05.06.2021

BUILDING ELEVATIONS

A2.00



ELEVATION NOTES

NO. NOTE

CONTINUOUS RIDGE VENT DIMENSIONAL ASPHALT SHINGLE ROOF FIBER CEMENT FASCIA 5" GUTTER FIBER CEMENT TRIM FIBER CEMENT CLAPBOARD SIDING 8" CABLE RAIL

COMPOSITE DECKING AND SKIRT BOARD AT DECK PERIMETER FIBER CEMENT CLAPBOARD SIDING 8"

DARK BRONZE ANODIZED PARAPET CAP GARDEN ACCESS DOOR

REUSE ORIGINAL INTERIOR PORCH WINDOW IN EXTG. OPENING. 13 FIBER CEMEN REFUSE ENCLOSURE W/ GREEN ROOF AND BYPASS SLIDING GATE OPENINGS

14 DARK BRONZE ANODIZED STOREFRONT

15 8" DEEP EXTRUDED SOLID METAL AWNING (ARCHITECTURAL LOUVERS H8CV OR SIM) 16 FEATURE WALL SCONCE

ORIGINAL SINGLE PANE WOOD WINDOW TO REMAIN, TYP. @ HOUSE U.N.O.

18 NEW WINDOW IN EXTG. OPENING 19 NEW CHARCOAL GRAY GUTTER

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SHEET TITLE **BUILDING**

ELEVATIONS

SHEET NO.

RIDGE 18' - 8 1/2"

EXTG. LEVEL 2,

7' - 2" MEZZANINE

TRUSS BEARING


EXTG. LEVEL 1


EXTG. BASEMENI.
-7' -9 1/2"
-7' - 9 1/2"

PROJECT NO. SJM_2010 ISSUE FINAL P&Z APPLICATION 05.06.2021 **ISSUE DATE** SHEET TITLE


BUILDING **SECTIONS**


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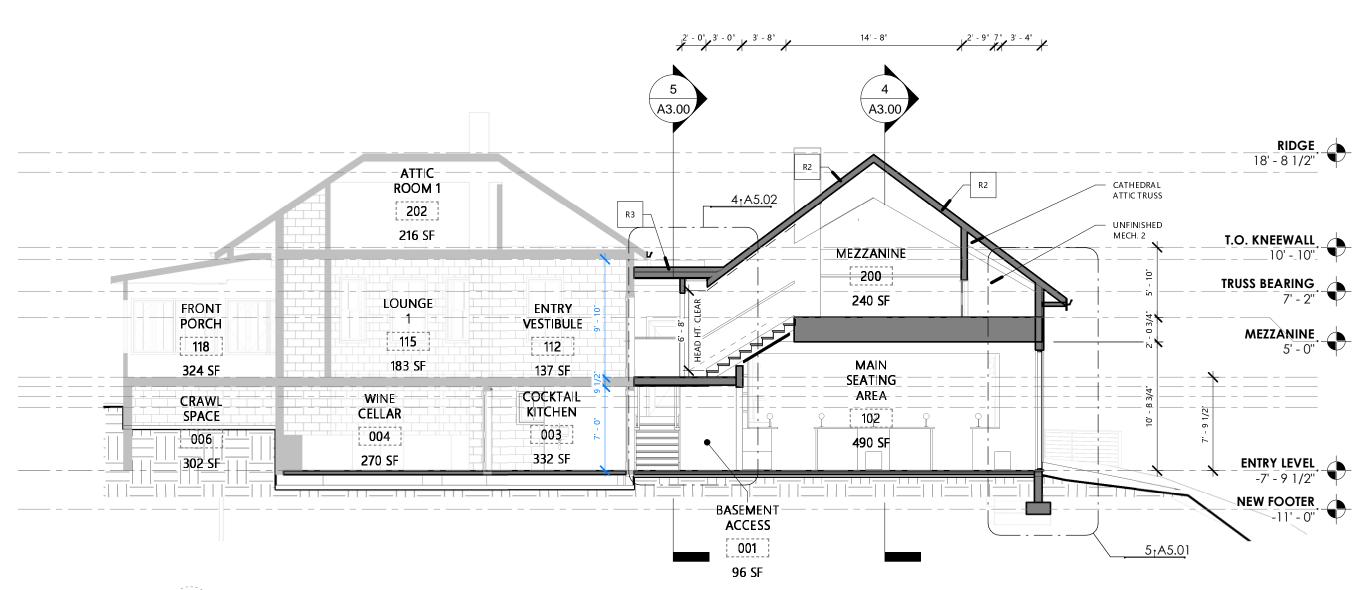


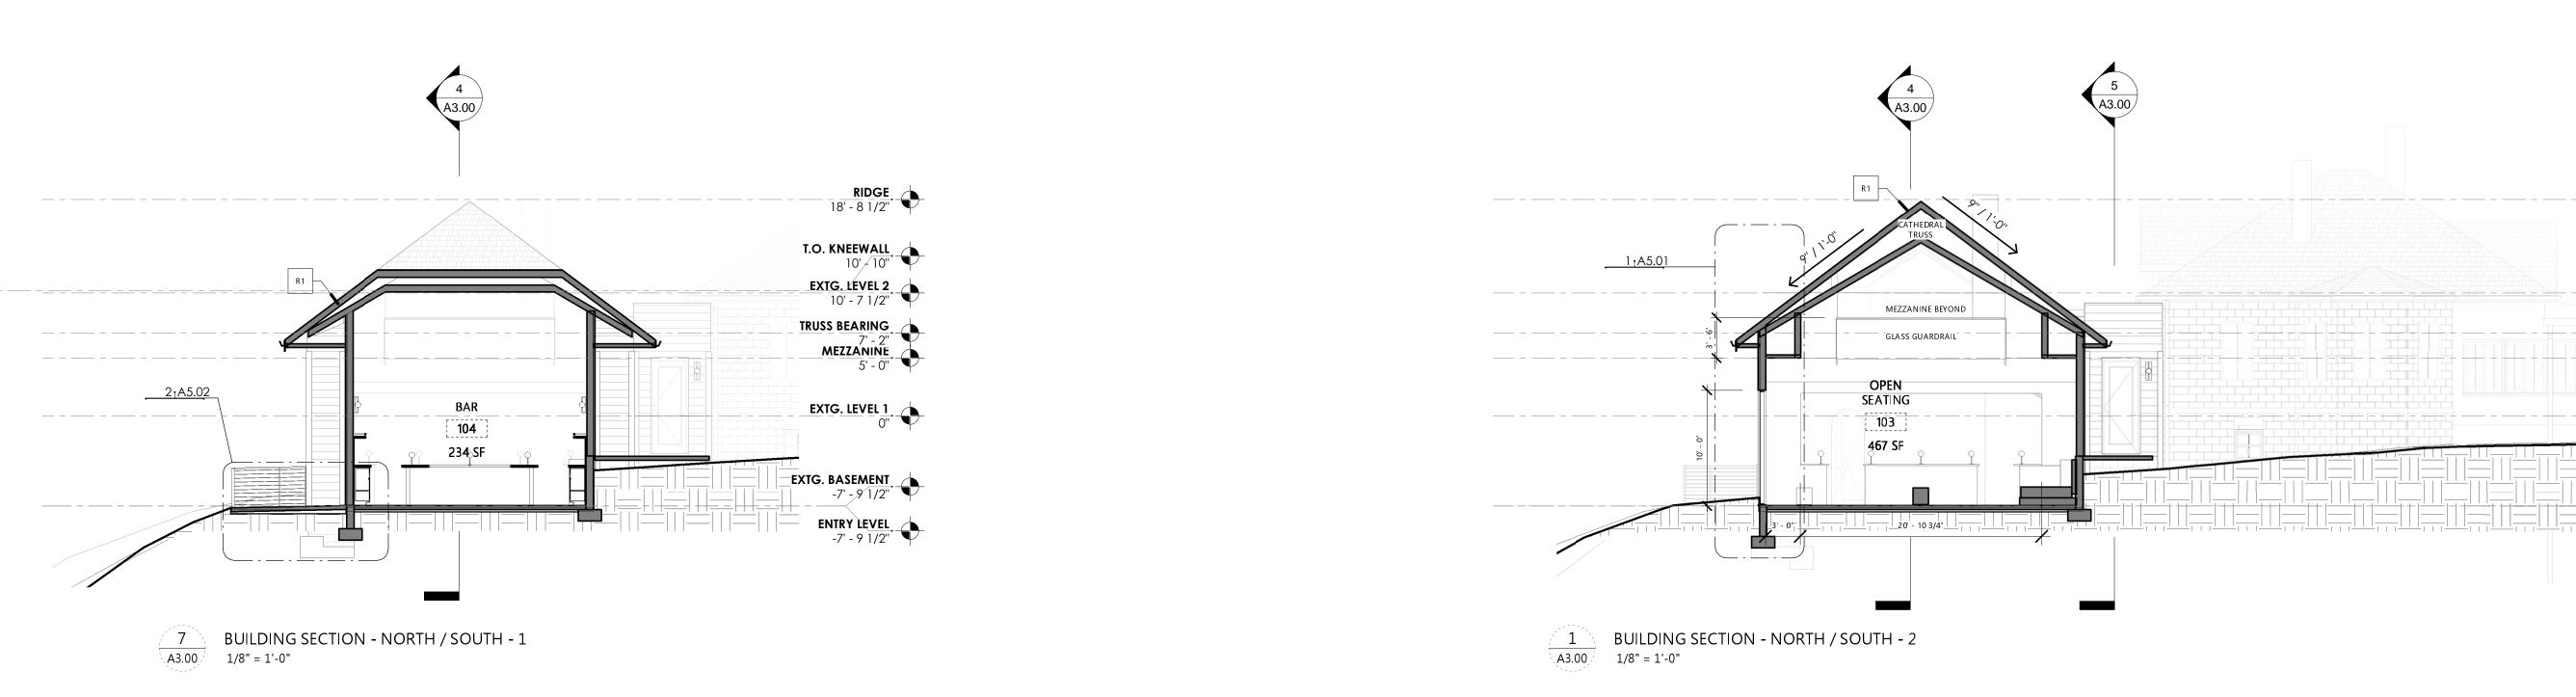

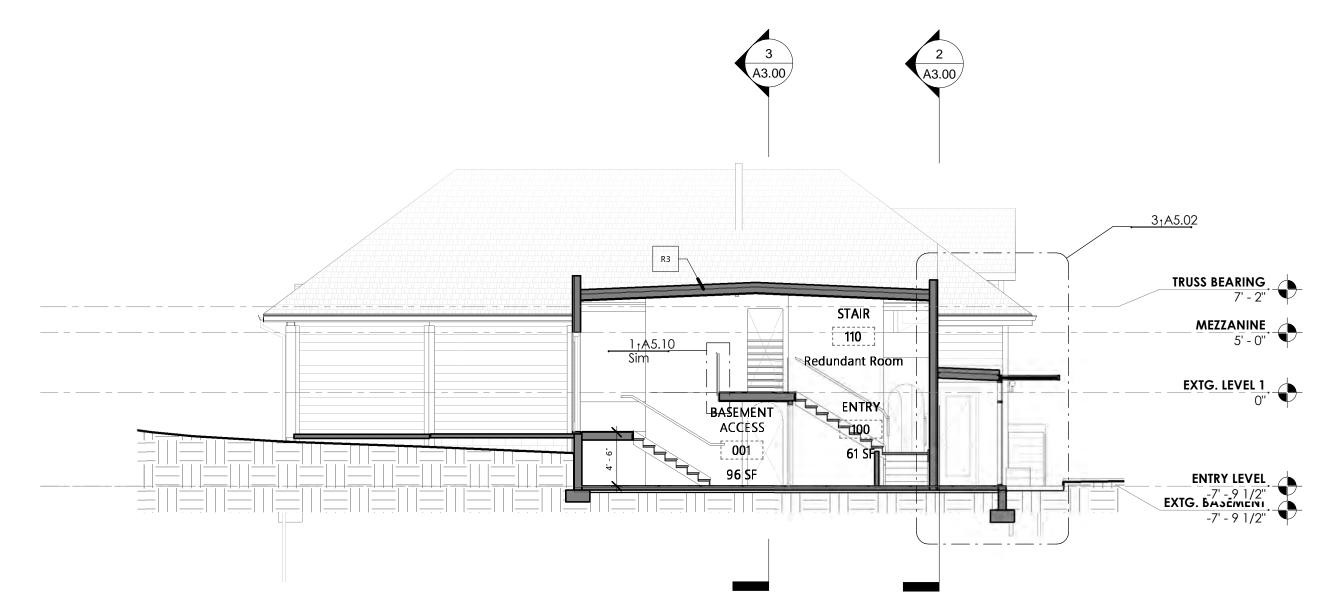BUILDING SECTION - EAST/WEST 1
1/8" = 1'-0"




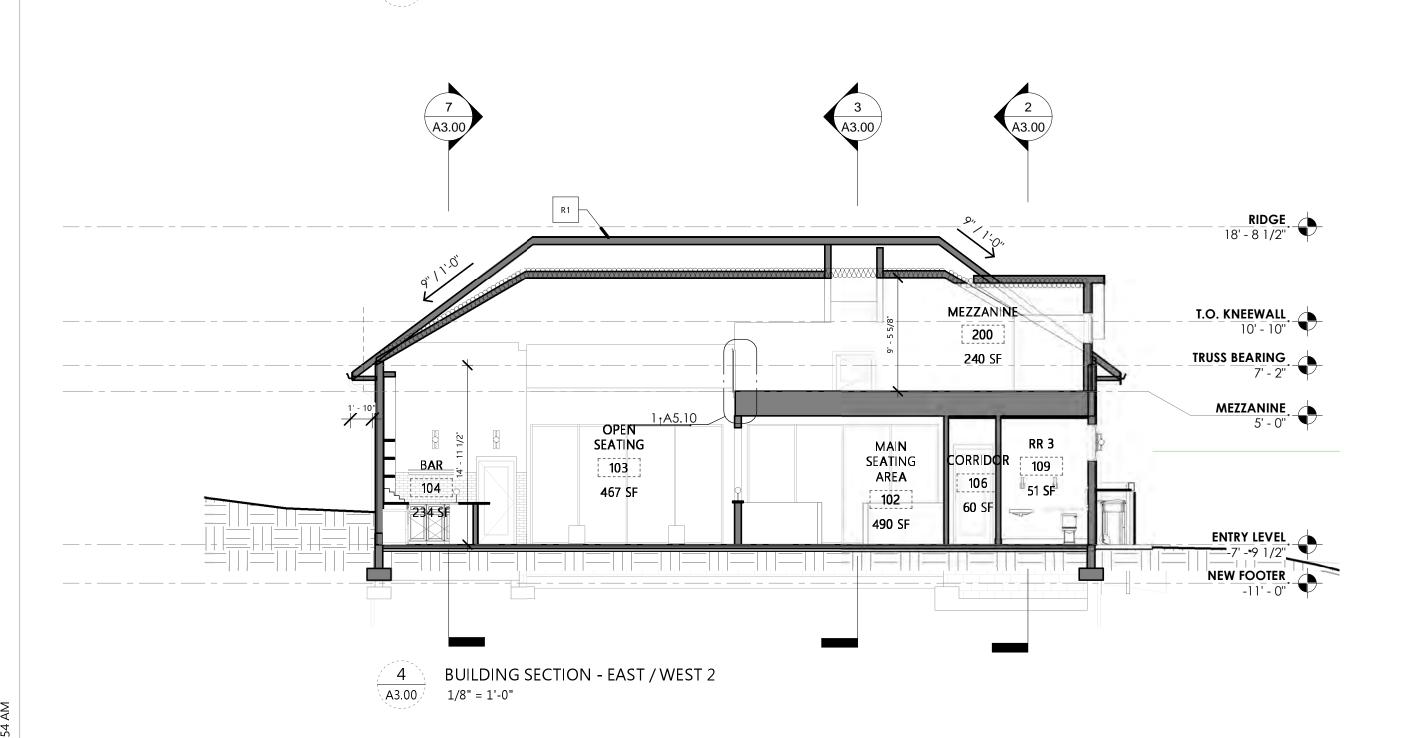

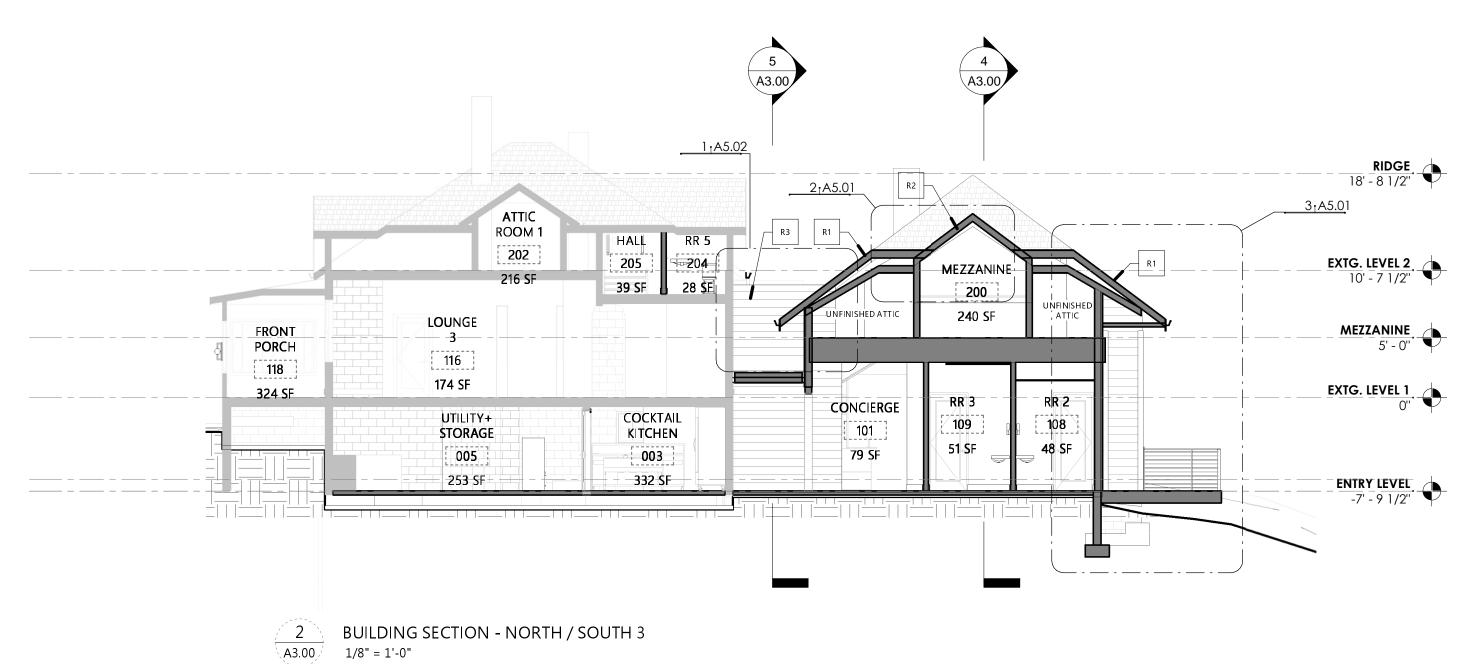

BUILDING SECTION - NORTH / SOUTH 4

1/8" = 1'-0"

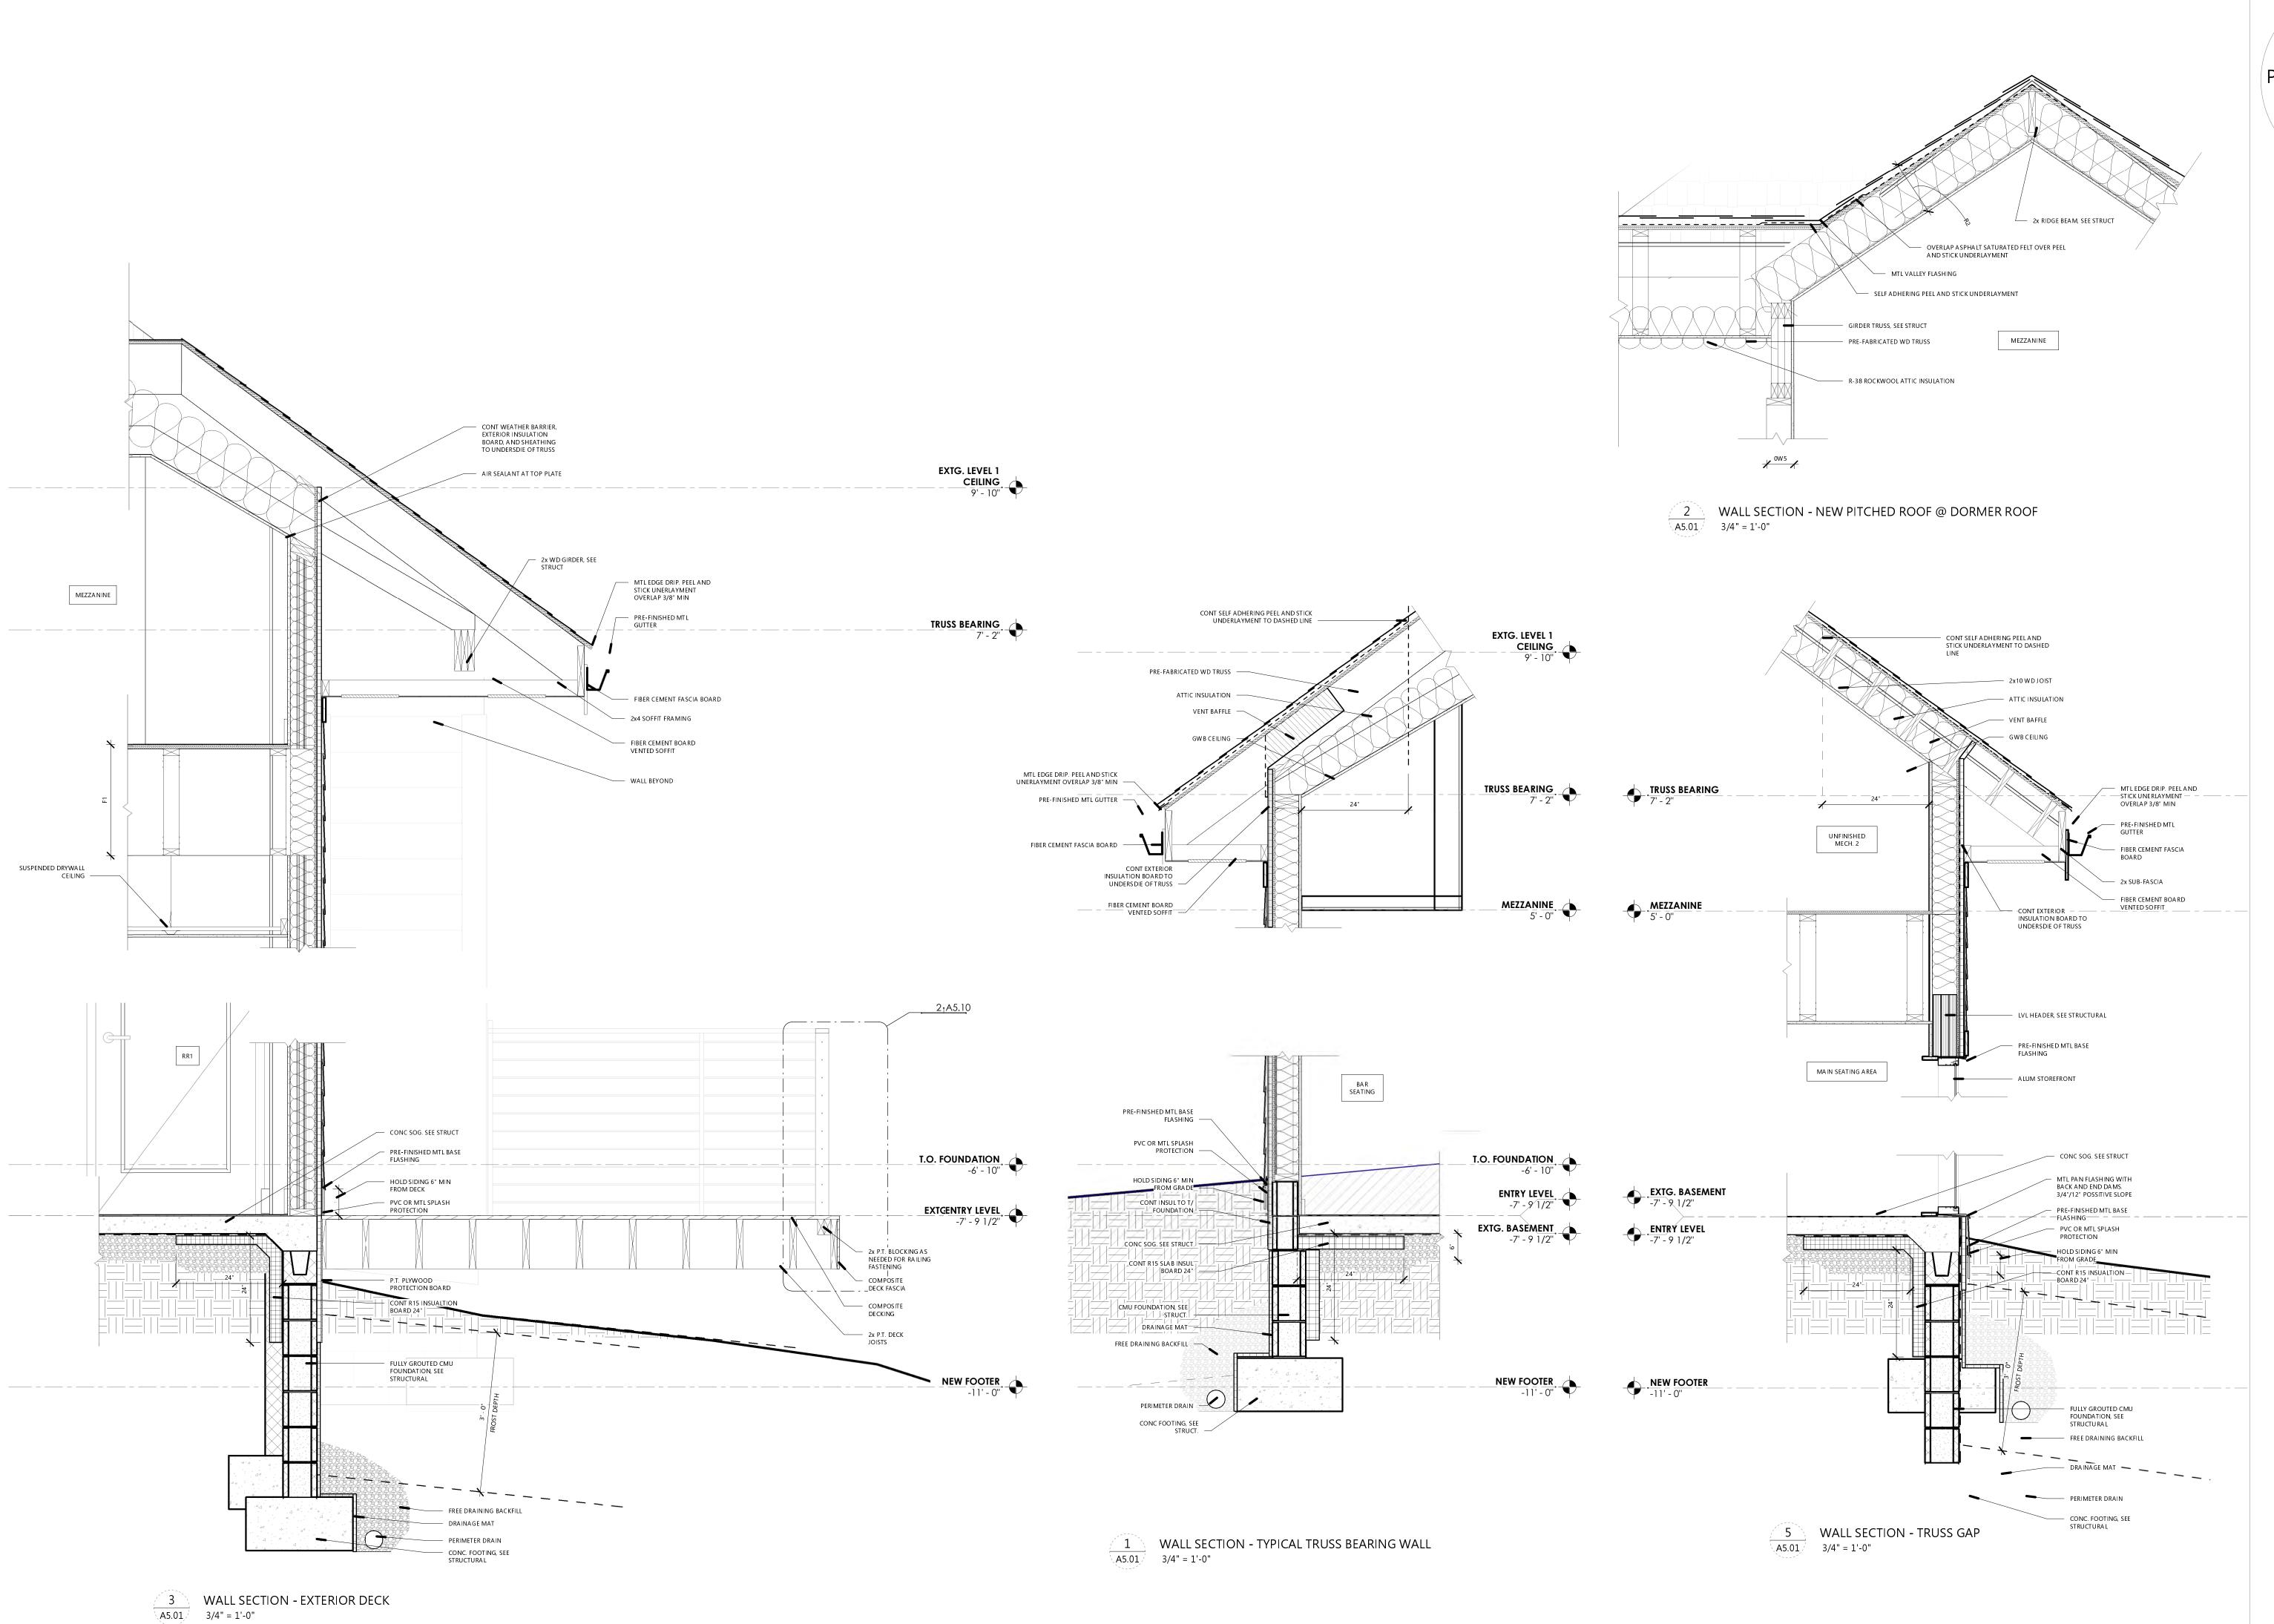

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SHEET TITLE

WALL SECTIONS + DETAILS

SHEET NO.

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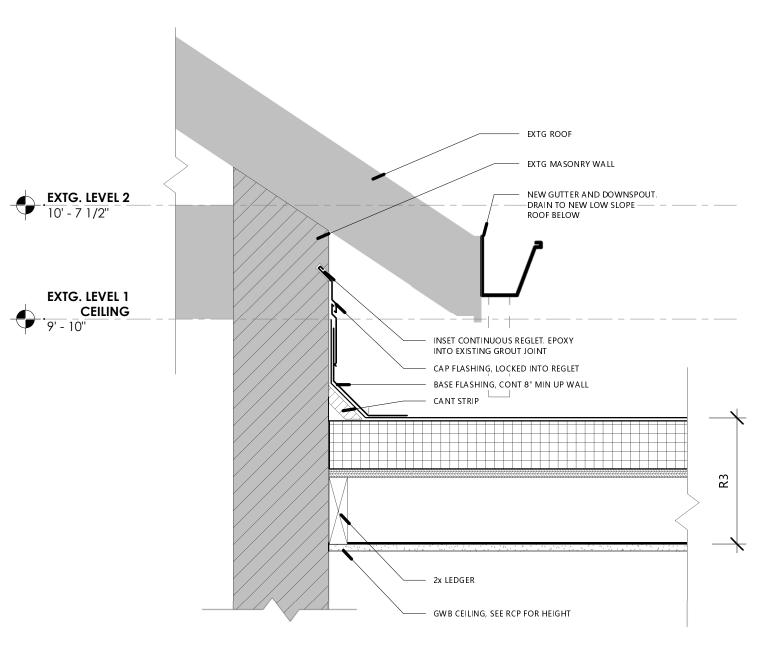
WALL SECTIONS + DETAILS

SHEET NO.


A5.02
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EXTG ROOF 2x PRE-FABRICATED ROOF TRUSS — - EXTG MASONRY WALL EXTG. LEVEL 2 ASPHALT SATURATED FELT UNDERLAYMENT — SELF A HHERING FLASHING @ TOP OF MTL FLASHING — EXTG. LEVEL 1 CEILING 9' - 10" TPO TERMINATION BAR, SEALED PER MNRF — - INSET CONTINUOUS REGLET. EPOXY INTO EXISTING GROUT JOINT PRE-FINISHED MTL FLASHING -CAP FLASHING, LOCKED INTO REGLET BASE FLASHING, CONT 8" MIN UP WALL - CANT STRIP ---- 2x LEDGER GWB CEILING, SEE RCP FOR HEIGHT

DETAIL SECTION - ROOF MEMBRANE @ SHINGLE ROOF 11/2" = 1'-0"




DETAIL SECTION - LOW SLOPE ROOF @ EXTG WALL 11/2" = 1'-0"

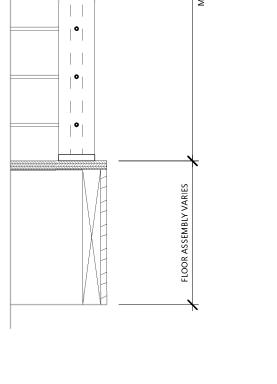

STL OR ALUM GUARDRAIL, POWDER COATED BLK



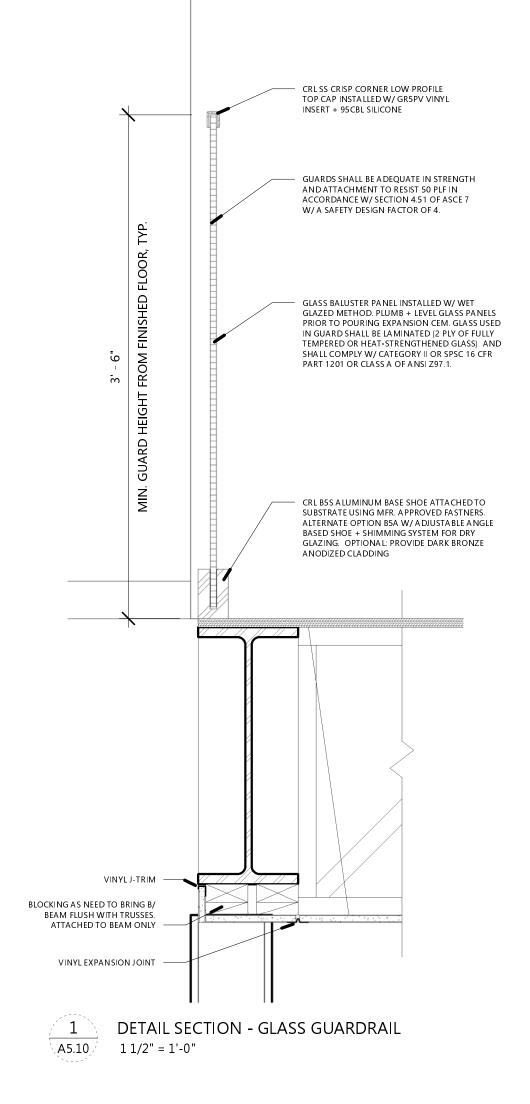

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DATE REVISION

PROJECT TITLE 80 E


OLENTANGY POWELL, OHIO 43065


PROJECT NO. SJM_2010 ISSUE FINAL P&Z APPLICATION 05.06.2021 ISSUE DATE SHEET TITLE

> **DETAIL SECTIONS**

SHEET NO.

													DOOR SCHEDULE
	OPENING						DOOR	FRAME		DETAILS			
DOOR			DIME	NSIONS		C	GLAZING	·					FIRE
NO	LOCATION	W	H .	THK	TYPE	MTRL	TYPE	MTRL	HEAD	JAMB	SILL	HDWR	RATING COMMENTS
NEW CON	NSTRUCTION VEL												
001A	BASEMENT ACCESS	2' - 10"	6' - 8"	1 3/8"	11	WD						6	45 MIN
100	ENTRY	2' - 9 1/16"	6' - 11 19/64"	1 3/4"	1	WD	SG	НМ				1	
106B	RR 2	3' - 0"	8' - 0"	1 3/8"	3	WD	SG	WD				4	
106C	RR 3	3' - 0"	8' - 0"	1 3/8"	3	WD	SG	WD				4	
111	GARDEN ACCESS PATIO	3' - 0"	8' - 0"	1 3/8"	6	НМ	SG	НМ				2	GARDEN ACCESS
EXTG. BAS	SEMENT												
003	BASEMENT ACCESS	3' - 0"	6' - 8"	1 3/8"	4	WD						3	90 MIN
004	COCKTAIL KITCHEN	3' - 0"	6' - 8"	1 3/8"	4	WD							
005	COCKTAIL KITCHEN	3' - 0"	6' - 8"	1 3/8"	4	WD							
103		3' - 0"	8' - 0"	1 3/8"	6	НМ	SG	НМ				2	
106		3' - 0"	7' - 0"	1 3/8"	25	НМ	SG	НМ				2	
120	MAIN SEATING AREA	0"	0"		4								
123	CONCIERGE	3' - 0"	8' - 0"	1 3/8"	2	WD		STEEL				5	CUSTOM LEATHER UPHOLSTRY FINISH
EXTG. LEV	'EL 1												
112	LANDING	3' - 0"	6' - 8"	1 3/8"	4	WD						3	90 MIN
117	STORAGE	2' - 6"	6' - 8"	1 3/8"	5	WD						5	DOOR TO MATCH EXTG. ORIGINAL INTERIOR DOORS
128	LANDING	0"	0"	<u>-</u>	13	 - !						5	
MEZZANI	NE												
124	MEZZANINE	2' - 8"	6' - 8"	1 3/8"	4	WD		!					
	-+	+											

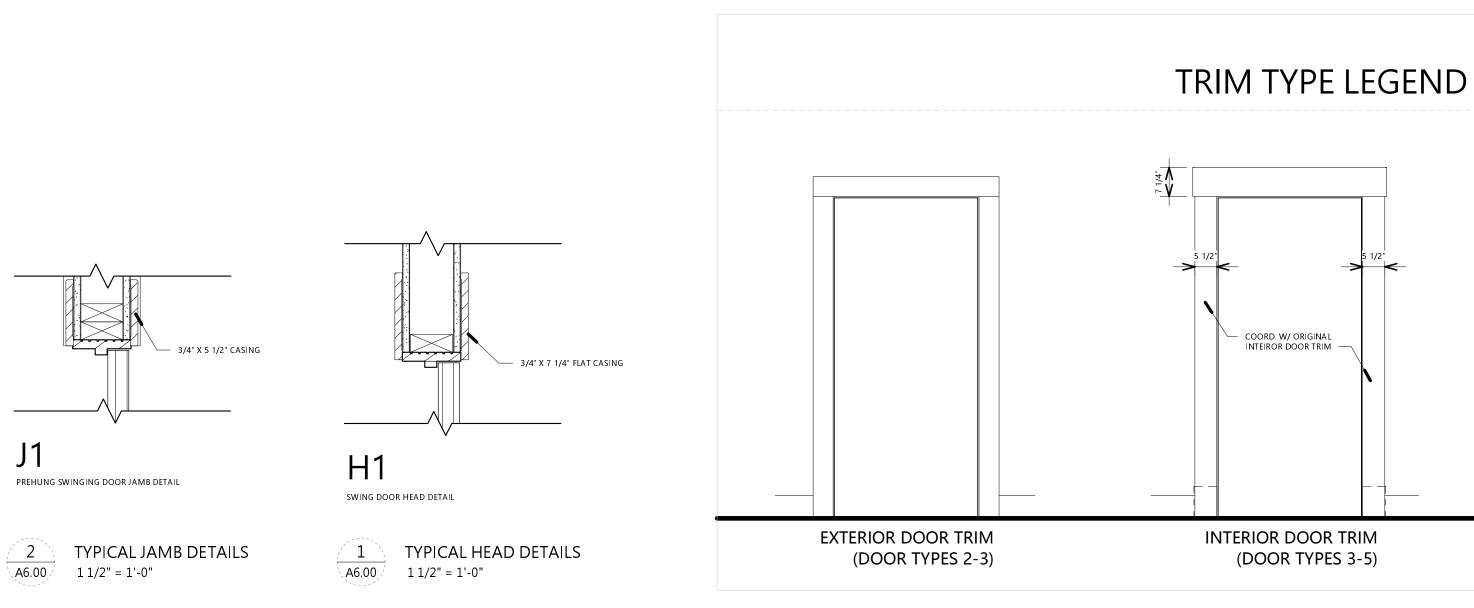

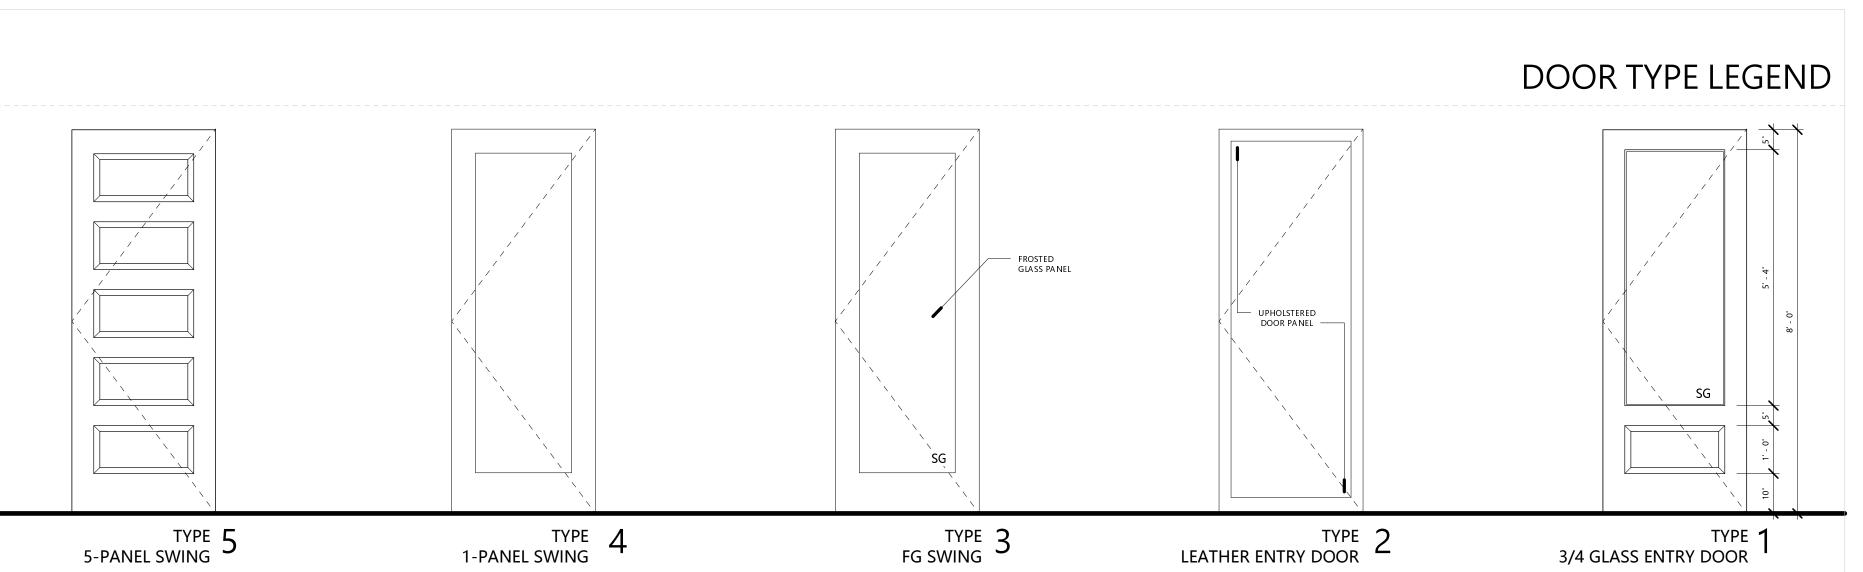

3' - 0"

3' - 0"

5' - 10"

1 3/8"

1 3/8"

1 3/8"

24

WD

3' - 0"

2' - 6"

126

129

202

SG = SAFETY GLASS

EXTG. LEVEL 2

MEZZANINE

RR 5

GENERAL DOOR NOTES

PROVIDE 3/8" MIN SILICONE SEALANT AT EXTERIOR DOOR JAMBS & HEADS.
MEANS OF EGRESS DOOR SHALL NOT REQUIRE USE OF A KEY,
TOOL, OR SPECIAL KNOWLEDGE FOR OPERATION.
THE MAX. FORCE FOR PUSHING OR PULLING INTERIOR EGRESS
DOORS TO BE 5 LBS. FOR OTHER DOORS, THE FORCE REQ'D TO

DISENGAGE THE DOOR LATCH SHALL BE 15 LBS. AND THE FORCE

ALL ORIGINAL MORTISED DOOR HARDWARE TO REMAIN INCLUDING ORIGINAL DOOR KNOBS.
 DOOR HARDWARE SUBCONTRACTOR TO COORDINATE KEYING.

 A. ALL EXTERIOR DOOR HARDWARE TO BE KEYED ALIKE.
 B. ALL INTERIOR DOOR HARDWARE TO BE KEYED ALIKE.

REQ'D TO SET THE DOOR IN MOTION SHALL BE 30 LBS.

EXCEPT AS NOTED.

NEW EXTERIOR ENTRY DOOR 100 AND INTERIOR ENTRY DOOR

101 TO BE OPERATED WITH ELECTRIC DOOR LOCKS. COORDINATE
WITH TENANT SECURITY SUBCONTRACTOR AS REQ'D.
ELECTRIFIED DOOR HARDWARE SHALL BE LISTED AND LABELED AS
DEFINIED IN NFPA 70, BY A QUALIFIED TESTING AGENCY, AND
MARKED FOR INTENDED LOCATION AND APPLICATION.
A. PROVIDE SENSOR RELEASE OF ELECTRICALLY LOCKED

EGRESS DOOR(S)

a. THE SENSOR SHALL BE INSTALLED ON THE
EGRESS SIDE AND ARRANGED TO DETECT AN
OCCUPANT APPROACHING THE DOOR. THE
DOOR SHALL BE ARRANGED TO UNLOCK BY A
SIGNAL FROM OR LOSS OF POWER.

b. THE LOSS OF POWER TO THE LOCK OR LOCKING SYSTEM SHALL AUTOMATICALLY UNLOCK THE DOOR.

C. THE DOOR SHALL BE ARRANGED TO UNLOCK FROM A MANUAL UNLOCKING DEVICE LOCATED 40" MIN. TO 48" MAX. VERTICALL A.F.F. READY ACCESS SHALL BE PROVIDED TO THE MANUAL UNLOCKING DEVICE AND THE DEVICE SHALL BE CLEARLY IDENTIFIED BY A SIGN THAT READS "PUSH TO EXIT". WHEN OPERATED, THE MANUAL UNLOCKING DEVICE SHALL RESULT IN DIRECT INTERRUPTION OF POWER TO THE LOCK - INDEPENDENT OF OTHER ELECTRONICS - AND THE DOOR SHALL REMAIN UNLOCKED FOR NOT LESS THAN 30 SECONDS.

d. ACTIVATION OF THE BUILDING FIRE ALARM
SYSTEM SHALL AUTOMATICALLY UNLOCK THE
DOOR AND THE DOOR SHALL REMAIN
UNLOCKED UNTIL THE FIRE ALARM SYSTEM HAS

BEEN RESET.
e. THE DOOR LOCKING SYSTEM UNITS SHALL BE
LISTED IN ACCORDANCE WITH UL 294.

7. ALL EXTERIOR DOOR HARDWARE TO BE GRADE 1, SS BY SCHLAGE.

8. ALL NEW INTERIOR DOOR HARDWARE TO BE DEXTER SOLSTICE BY SHLAGE IN AGED BRONZE

DOOR HANDLES, PULLS, LATCHES, LOCKS AND OTHER OPERATING DEVICES SHALL BE INSTALLED 34" MIN. AND 48" MAX. A.F.F.

	DOC	OR HARDWARE
NO.	ASSEMBLY DESCRIPTION	COMMENTS
1	EXTERIOR 3 EA. HINGE 1 EA. SFIC CORE + RIM HOUSING 1 EA. DOOR PULL 1 EA. CONCEALED CLOSER* 1 EA. KICK PLATE 1 EA. GASKETING 1 EA. DOOR SWEEP 1 EA. THRESHOLD	OWNER TO VERIFY SALVAGE VS. NEW DOOR *FINAL SPEC PENDING
2	EXTERIOR 3 EA. HINGE 1 EA. PASSAGE SET, LEVER HANDLE 1 EA. SGL CYL DEADBOLT 1 EA. SURFACE CLOSER 1 EA. DOOR STOP 1 EA. KICK PLATE 1 EA. GASKETING 1 EA. DOOR SWEEP 1 EA. THRESHOLD 1 EA. DRIP CAP - ADD ALT.	NEW EXTERIOR SINGLE DOOR
3	INTERIOR - 90 MIN. 3 EA. HINGE 1 EA. PASSAGE SET, LEVER HANDLE 1 EA. SGL CYL DEADBOLT 1 EA. SURFACE CLOSER 1 EA. DOOR STOP 1 EA. GASKETING 1 EA. DOOR SWEEP 1 EA. THRESHOLD	PROVIDE DOOR HARDWARE COMPLYING WITH NFPA 80 THAT IS LISTED AND LABELED BY A QUALIFIED TESTING AGENCY, FOR FIRE-PROTECTION RATINGS AS INDICATED.
4	INTERIOR 3 EA. HINGE 1 EA. KEYED PRIVACY SET, LEVER HANDLE 1 EA. DOOR STOP	NEW INTERIOR RESTROOM DOORS
5	INTERIOR 3 EA. HINGE 1 EA. KEYED PRIVACY SET, LEVER HANDLE 1 EA. KEYED DEAD BOLT 1 EA. DOOR STOP	EXTG. INTERIOR STAIR DOOR E113 DOOR LOCKED FROM STAIR SIDE, OPERABLE WITHOUT KEY FROM BASEMENT SIDE.
	INITEDIOD	

6 3 EA. HINGE
1 EA. STOREROOM LOCKSET, LEVER HANDLE
1 EA. DOOR STOP

DOOR LOCKED FROM OUTSIDE, OPERABLE WITHOUT KEY FROM INSIDE

NO PANIC OR FIRE EXIT HARDWARE REQ'D.

INTERIOR

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PROJECT TITLE

80 E OLENTANGYPOWELL, OHIO 43065

PROJECT NO. SJM_2010

ISSUE FINAL P&Z APPLICATION

ISSUE DATE 05.06.2021

DOOR SCHEDULE
+ DETAILS

SHEET NO.

A6.00







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www.7254 Eastwood A

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PROJECT TITLE

80 E OLENTANGYPOWELL, OHIO 43065

PROJECT NO. SJM_2010

ISSUE FINAL P&Z APPLICATION

ISSUE DATE 05.06.2021

SHEET TITLE

RENDERINGS

SHEET NO.

48.00

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EXTERIOR LIGHTING



PATH LIGHTING

FEATURE WALL SCONCE


EXISTING HOUSE









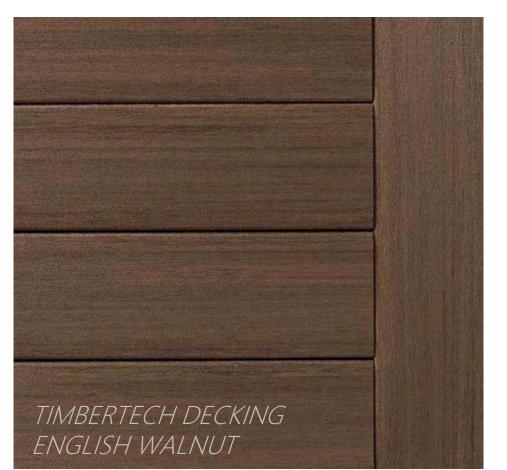







DIMENSIONAL ROOF SHINGLE

SHERWIN WILLIAMS DARK NIGHT

> SHERWIN WILLIAMS MOUNT ETNA

MATERIAL PALETTE


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SJM_2010 ISSUE FINAL P&Z APPLICATION SHEET TITLE

SHEET NO.

Setbacks

Most buildings in Powell are set back approximately 20 to 40 feet from the road with modest front lawns. The exceptions are the commercial buildings at the corner of Olentangy and Liberty Streets, which are built right up to their property lines at the sidewalks. Rear yards are generally long and narrow. Residential buildings on adjacent lots throughout the City are set approximately 20 feet apart from each other at their sides. New construction should follow the setback lines appropriate to its location and purpose.

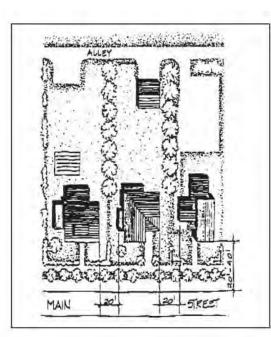


One of the charms of rural areas is the complete darkness of nightfall away from the 24 hour light of the city. However, proper lighting fixtures can increase the safety of Powell, and may become more necessary as development continues. Exterior lighting in the Historic District should be incandescent, and low in wattage. Entrance lights and individual free standing path lights are acceptable. Lighting fixtures should be simple Victorian or turn of the century in design, with round or egg-shaped globes on metal posts with minimal detailing.

Colonial style "coach lights" are not appropriate in the Historic District. These types belong to an earlier historical period, and generally belong on coaches.

Site Considerations

Free standing, pole mounted lamps may be used to light paths or drives. These lights should not be taller than the height of the first story of adjacent buildings. Metal posts should be painted in dark, muted colors such as black, brown, or dark green. The more elaborate the shape of the globe, the simpler the detailing of the post should be. Simple globes can be mounted on more detailed posts, All pole mounted lights should be individual, <u>Clusters of lights</u> are not acceptable in the Historic District.

Contemporary lights which incorporate simple, round or oval globes and modest posts or brackets may be appropriate in the Historic District. Frosted globes should be used in all lights in the Historic District, as they will provide softer light than clear

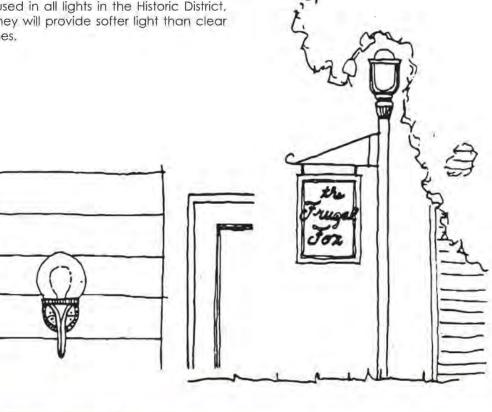

A FEATURE WALL SCONCE

- B PATH LIGHTING
- C RECESSED EXTERIOR CAN LIGHT IN AWNING
- D FEATURE HANGING CHANDELIER
- RECESS EXTERIOR CAN LIGHTS IN DECK OVERHANGS
- F FEATURE WALL SCONCE

EXISTING LIGHT POST

Site Considerations



TRAFFIC LIGHT POST



A, F



SEE CIVIL SITE PLAN



EXISTING TRAFFIC SIGNAL LIGHT POST

FEATURE CHANDELIER IN VESTIBULE, D

SITE LIGHTING

POWELL, OHIO 43065 PROJECT NO. SJM_2010 ISSUE FINAL P&Z APPLICATION ISSUE DATE 05.06.2021

80 E

OLENTANGY

DATE REVISION

PROJECT TITLE

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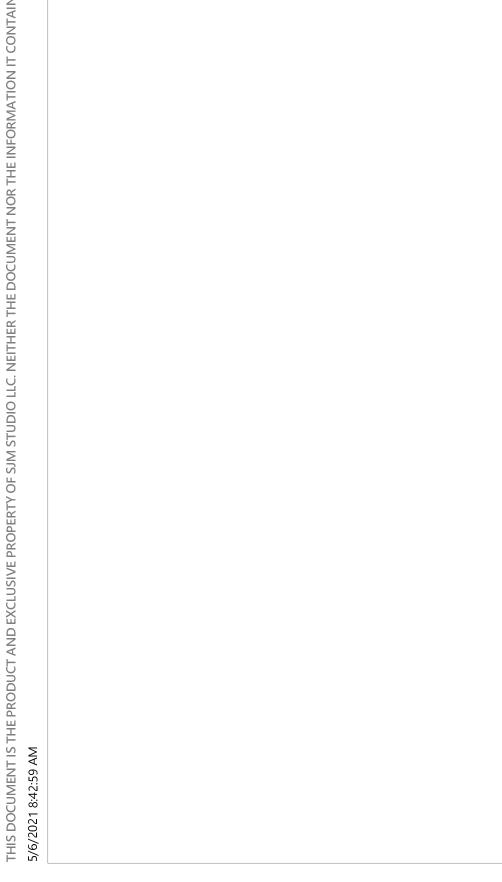
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SHEET TITLE SITE LIGHTING


SHEET NO.

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1 SITE LIGHTING 1" = 10'-0"

LIGHT POST





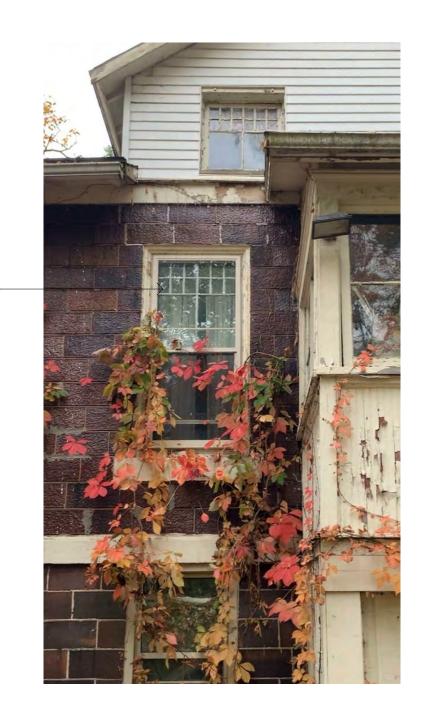


















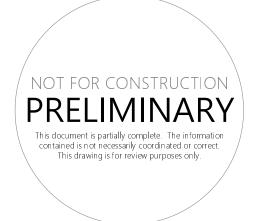

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PROJECT TITLE

80 E OLENTANGYPOWELL, OHIO 43065

PROJECT NO. SJM_2010

ISSUE FINAL P&Z APPLICATION


ISSUE DATE 05.05.2021

SHEET TITLE

EXISTING IMAGES

SHEET NO.

A8.04

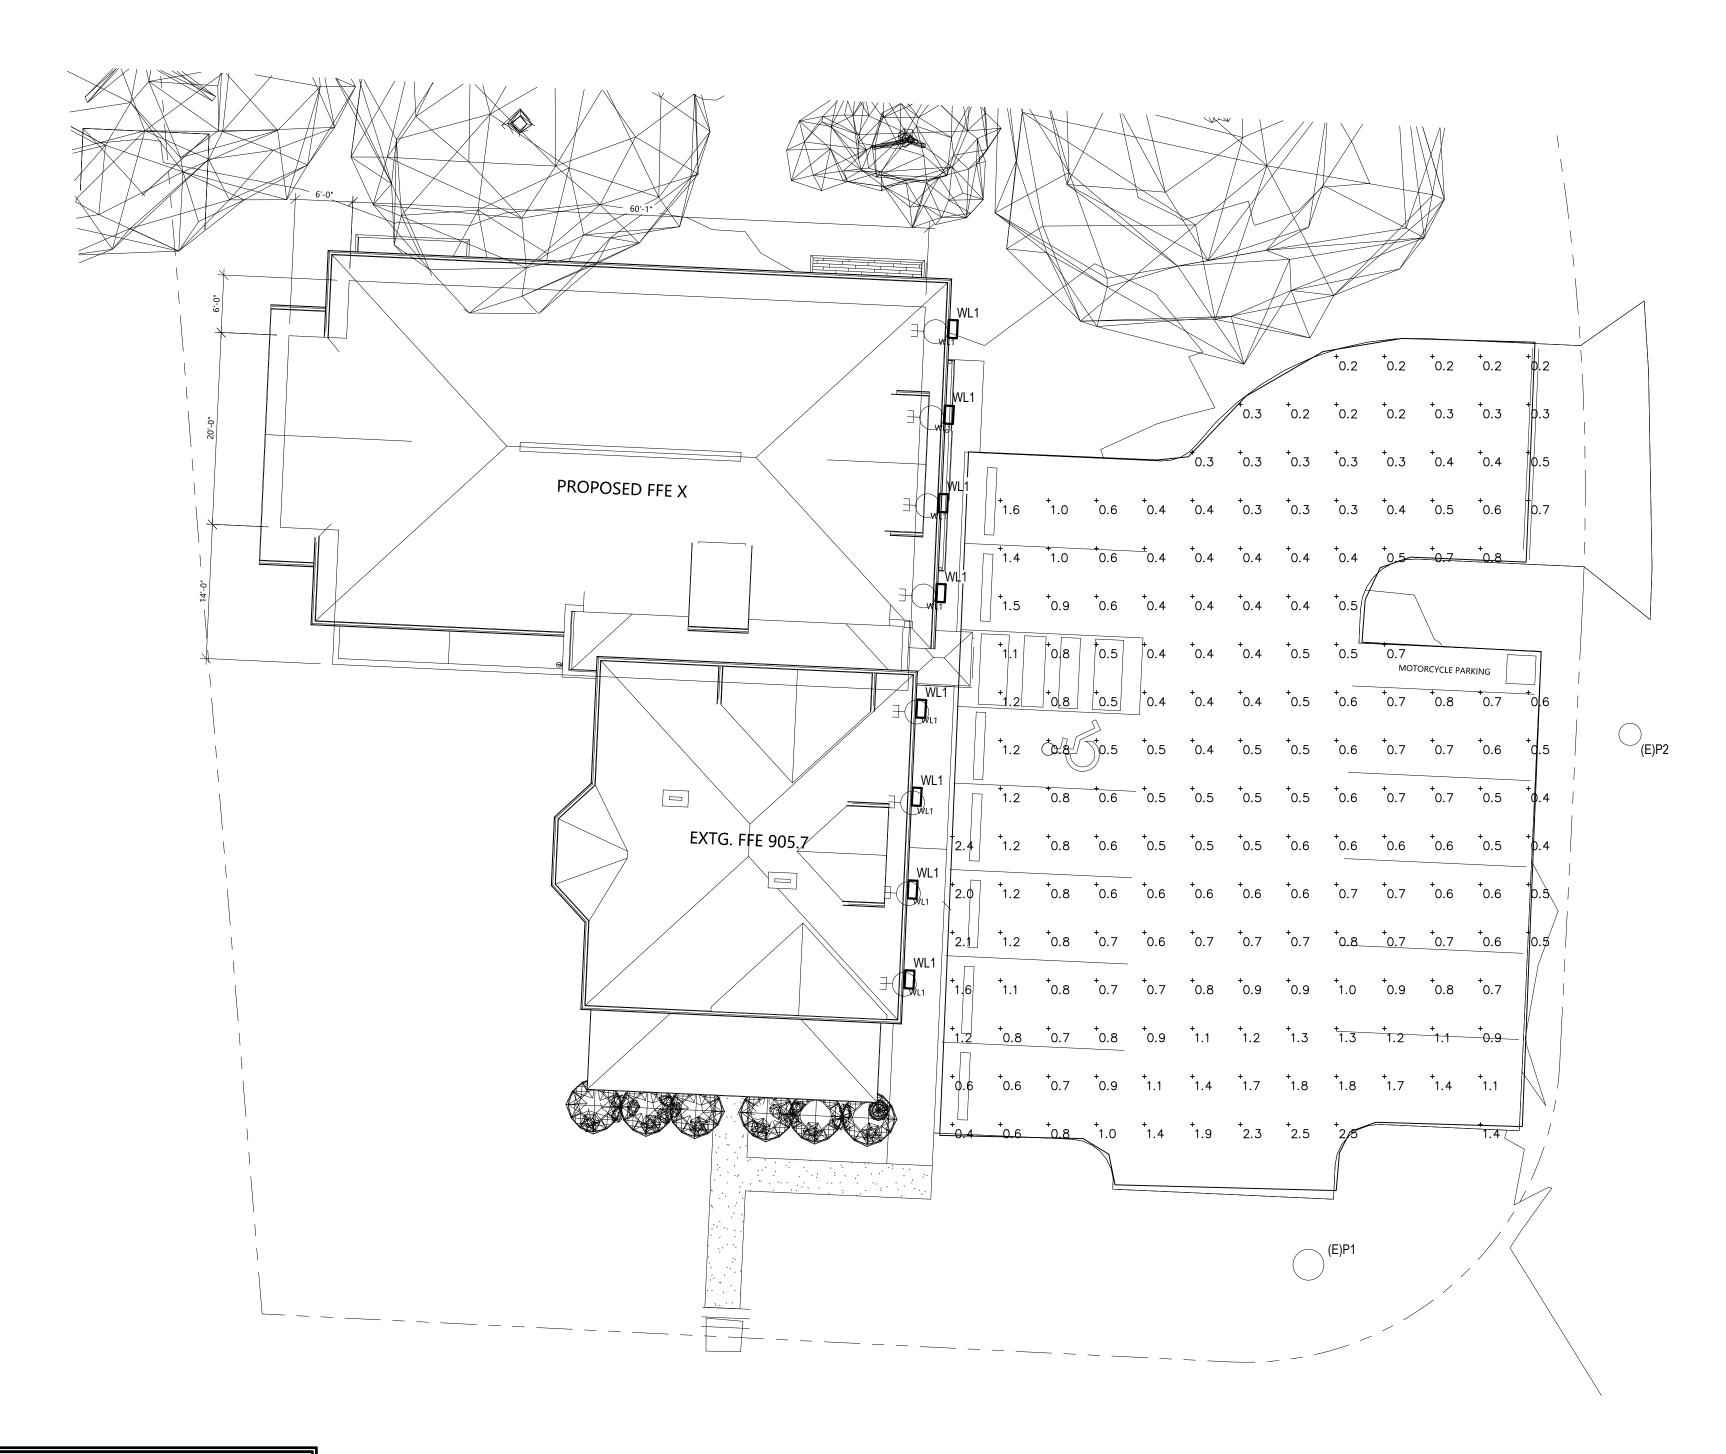

Statistics						
Description	Symbol	Avg	Max	Min	Max/Min	Avg/Min
PARKING LOT	+	0.8 fc	2.5 fc	0.2 fc	12.5:1	4.0:1

	LIGHTING FIXTURE SCHEDULE					
MARK	DESCRIPTION	VOLT	LAMP	MOUNT	MANUFACTURER	
(E) P1	POLE MOUNTED OUTDOOR PENDANT WITH LED BULB (OWNED BY CITY OF POWELL)	EXIST.	EXIST. 60W LED BULB, 7600 LUM (APPROX.)	MOUNTED TO EXISTING POLE 16' (APPROX.)	EXISTING TO REMAIN	
(E) P2	POST TOP LANTERN WITH LED BULB (OWNED BY CITY OF POWELL)	EXIST.	EXIST. 60W LED BULB, 7600 LUM (APPROX.)	MOUNTED TO EXISTING POLE 14' (APPROX.)	EXISTING TO REMAIN	
WL1	EXTERIOR WALL PACK	120	60 W INC. 800 LUM (APPROX.) 4000 K	WALL MOUNT @8'-0" A.F.F.	SHADES OF LIGHT #OL20023	



!					
1					
<u></u>				mbus, Ohio 43231	

80 E. OLENTANGY STREE POWELL, OHIO 43065 SITE PHOTOMETRIC PLAN

PROJECT NO. TBD CHECKED BY: VWE AS NOTED 04-09-2021

Sheet No.



Russell Tree Experts Itd · 3427 E Dublin Granville Rd Westerville, Ohio 43081 · 614-895-7000 · RussellTreeExperts.com

Customer:

Arborist:

Gretchen Bonasera 80 East Olentangy St. Powell, OH 43065 614.477.8030



José Fernández Regional Manager, Russell Tree Experts ISA Board Certified Master Arborist® OH-5129B Jose@RussellTreeExperts.com 614-586-5777

April 7, 2021

Dear Gretchen,

I am pleased to submit my report for the tree inventory at the above address. As stated in Proposal #54617, work completed was to be:

- 1. Locate trees within 12 feet from the perimeter of the new structure that have a trunk diameter of six inches or greater... that cannot be preserved in their current location and condition.
- 2. Advise on whether or not these trees can be relocated.
- 3. Note other trees on site that are recommended as removals due to damage, disease or inappropriate or undesirable species.

The documents in this packet include this letter, one Excel spreadsheet with tree tabulation, and one .pdf of the site plan with my marked-in tree canopy footprint for each tree. All trees inventoried are at least 6 inches in diameter as measured at 24" above grade per your instructions when we met on site yesterday.

Trees were graded as Dead, Poor, Fair, Good. Items considered during grading were tree canopy health, degree of lean, presence of structural flaws, overall tree vigor. A tree graded as Poor would be considered to not be offering much landscape value and is



likely not going to have a long-term presence at the site regardless of human intervention.

Results:

- 1. There were a total of 22 trees in or within 12 feet of the proposed construction zone as currently shown on the site plan.
 - These trees are highlighted in red on the spreadsheet and written onto the site plan in red ink.
 - Of these 22 trees, 8 were graded as Poor. Tree numbers 1, 13, 18, 21, 25, 26, 28, 30.
- 2. None of these 22 trees are considered good candidates for relocation with a good chance of survival.
- 3. Within the size specification, there were 17 trees on the site that are more than 12 feet away from proposed construction zones.
 - These trees are written onto the site plan with green ink.
 - Of these 17 trees, 2 were graded as Dead or Poor. Tree numbers 5, 14.
 - Removal of these trees is a matter of personal choice.

Final observations:

Norway maple is a prominent tree at this site. 7 of the 22 trees within the
proposed construction zone are of this species. 5 of the remaining 17 trees are of
this species. Norway maple is a foreign species of tree that has naturalized.
Currently the Ohio Invasive Plants Council designates this tree species as
"Potentially invasive". This means that currently it is not considered invasive but
its status could change if its invasiveness score increases.

(https://www.oipc.info/assessment-results.html).

2. There are some other trees and shrubs that are considered invasive, such as honeysuckle and Callery pear. All of these were less than 6 inches in diameter so I did not include them in my inventory. If desired, Walter Reins can include these in a removal quote as part of the site preparation when the time comes. Once you are ready to proceed with the removal plan, please contact me and I will share this report with Walter so he can provide a quote.



Thank you for using Russell Tree Experts Consulting Services. Please feel free to call me directly if you wish to discuss this project further or even to meet on site if needed. Also, I can provide more information if you determine that is needed.

Sincerely,

José Fernández

fore Hewand


Regional Manager, Russell Tree Experts ISA Board Certified Master Arborist® OH-5129B

Jose@RussellTreeExperts.com

614-586-5777

80 E Olentangy Tree Survey Schedule April 7, 2021

Number	Species	Common name	Condition	Within 12 feet?	Remove?	Notes
1	Acer platanoides	Norway maple	Poor	Υ	Υ	Hollow/decayed trunk
2	Carya ovata	Shagbark hickory	Good	N	N	
3	Acer platanoides	Norway maple	Fair	N	N	
4	Acer platanoides	Norway maple	Fair	N	N	
5	Acer saccharum	Sugar maple	Dead	N	?	Remove if desired. Currently providing habitat for woodpeckers.
6	Celtis occidentalis	Hackberry	Good	Υ	Υ	
7	Celtis occidentalis	Hackberry	Good	Υ	Υ	
8	Celtis occidentalis	Hackberry	Good	Υ	Υ	
9	Juglans nigra	Black walnut	Good	Υ	Υ	
10	Celtis occidentalis	Hackberry	Good	N	N	
11	Acer platanoides	Norway maple	Fair	N	N	
12	Acer platanoides	Norway maple	Fair	N	N	
13	Acer platanoides	Norway maple	Poor	Υ	Υ	
14	Acer saccharum	Sugar maple	Poor	N	?	Remove if desired. Nearly dead. Can leave as erosion control.
15	Acer saccharum	Sugar maple	Good	N	N	
16	Acer saccharum	Sugar maple	Fair	N	N	
17	Ulmus spp.	Elm	Fair	N	N	
18	Acer platanoides	Norway maple	Poor	Υ	Υ	
19	Acer platanoides	Norway maple	Good	Υ	Υ	
20	Acer platanoides	Norway maple	Fair	Υ	Υ	
21	Acer platanoides	Norway maple	Poor	Υ	Υ	
22	Acer saccharum	Sugar maple	Fair	Υ	Υ	
23	Ulmus spp.	Elm	Fair	Υ	Υ	
24	Acer platanoides	Norway maple	Fair	Υ	Υ	
25	Acer saccharum	Sugar maple	Poor	Υ	Υ	
26	Maclura pomifera	Osage orange	Poor	Υ	Υ	Declining rapidly.
27	Acer saccharum	Sugar maple	Fair	Υ	Υ	
28	Picea pungens 'Glauca'	Colorado blue spruce	Poor	Υ	Υ	Nearly dead.
29	Magnolia x soulangeana	Saucer magnolia	Good	Υ	Υ	,
30	Magnolia x soulangeana	Saucer magnolia	Poor	Υ	Υ	
31	Ginkgo biloba	Ginkgo	Fair	N	N	
32	Prunus serotina	Black cherry	Good	N	N	
33	Acer platanoides	Norway maple	Fair	N	N	
34	Juglans nigra	Black walnut	Good	N	N	
35	Acer saccharum	Sugar maple	Fair	N	N	Multiple codominant stems.
36	Quercus spp.	Oak	Fair	N	N	Street tree
37		Oak	Fair	Y	Y	Street tree
	Quercus spp.			Y		
38	Quercus spp.	Oak	Fair		Y	Street tree
39	Quercus spp.	Oak	Fair	Υ	Υ	Street tree

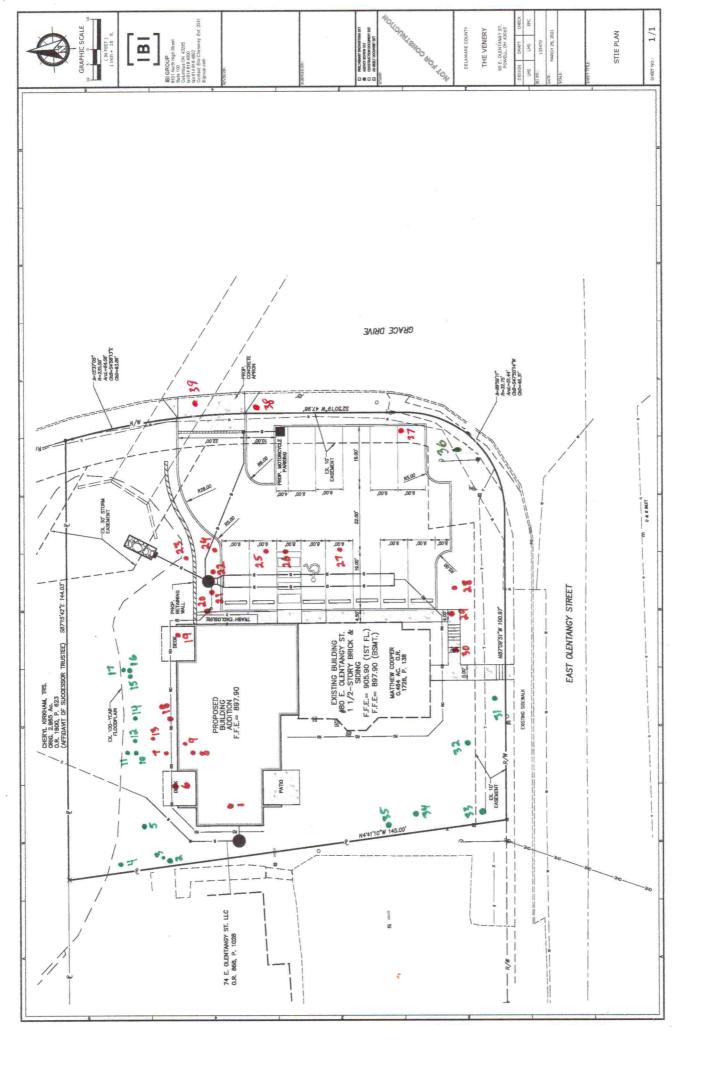

Station 321 Administrative Offices 7761 Liberty Road Powell, Ohio 43065 (740) 938-2021 (740) 938-2031 Fax

Liberty Township

Fire Department

Thomas J. O'Brien, EFO/CFO/MBA/MIFireE Fire Chief Station 322 Fire Prevention Bureau 10150 Sawmill Parkway Powell, Ohio 43065 (740) 938-2022 (740) 938-2032 Fax

04/23/2021

Ms. Gretchen Bonasera 4200 Macduff Way Dublin Ohio, 43016

Regarding: Serviceability request for The Venery: 80 E. Olentangy St. located in Powell / Liberty Township, Delaware County

Ms. Bonasera,

There is adequate water supply and The Liberty Township Fire Department can provide fire service to the following parcel in Powell / Liberty Township, Delaware County Ohio; this parcel is within 1.6 miles of the Liberty Township Fire station that is located at 10150 Sawmill Parkway Powell, Ohio 43065.

Delaware County Parcel # 319-425-13-051-002

If you should have any questions please contact me.

In the interest of public safety, of

Thomas J. O'Brien, EFO/CFO/MBA/MIFir Fire Chief

Liberty Township Fire Department #21-117

Cc: Lt. Tom Saunders

Liberty Township Fire Department



Email Letter

To: Gretchen Bonasera

Email: gretchen@goodnightinvestments.com

From: Lt. Tom Saunders Date: April 23, 2021 Re: 80 E. Olentangy St.

Ms. Bonasera,

I have reviewed the submitted site plans dated April 21, 2021 for the above development and find the turning radius and fire hydrant locations meet the intent of the Liberty Twp. Fire Code sections 503.2.4. and 507.3.

Can the proposed concrete island at the drive entrance be removed or constructed with a mountable or soft curb to provide easier access for our ladder truck in the event of an emergency.

If you have any questions regarding this review, please contact me at 740-938-2027

This review may be subject to additional zoning requirements.

Lt. Tom Saunders

Stores

 Q Search



CHANDELIERS LIGHTS FANS LIGHTS SHA	RUGS INSPIRATION	>
------------------------------------	------------------	---

Home / OUTDOOR LIGHTS / All Outdoor Lights / Veritas Outdoor Wall Light - Sall



















\$158.00

• In stock and ready to ship

Qty 1

ADD TO CART

+ Add to Wish List

Description

Adorn your outdoors with a piece from our Veritas Collection. Offered in a range of sizes, these mid-century fixtures are structured with textured black hardware and center globe shade. Stylish and functional, these glowing components will make your home stand-out on the block.

- Actual Size: 18.75"Hx6"Wx8"D
- Backplate/Canopy Size: 18.75"Hx5"W Rectangular
- Bulb Base: US Candelabra-E12
- Bulb Included: No
- Color: Black / Opal Glass

- Indoor-Outdoor: Yes
- **Limited Warranty:** 1 Year
- Material: Aluminum, Glass
- Max Bulb Wattage: 60
- Number of Lights: 1
- Safety Rating: Wet

California Residents See PROP 65 WARNINGS 🔻



4 0 / 5 • **1** reviews

EXPAND +

SHOP COLLECTION

VIEW ALL





VERITAS OUTDOOR WALL LIGHT -**MEDIUM**

\$218.00

VERITAS OUTDOOR WALL LIGHT -LARGE \$338.00

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