Gretchen Bonasera, member Goodnight Investments, LLC 80 E Olentangy Street, Powell Ohio 43065

#### Projected Membership Attendance & Parking Plan for our 192 Members

We plan to have 23 total spaces. Our 12 plus the 11 at the Historical society and then the Powell Center can be a backup plan as needed once we are open and have a better idea what are actual parking needs are.

Our pro forma projects a peak attendance of 66 guests at the busiest time on Saturday evening.

Membership Growth Curve will smooth out "new establishment rush"

		1st	2nd	3rd	4th	5th	6th	7th	8th							
	preview				month	D-C-11	0.011			Membe	ership ca	pped				
Total # of members	25	50	75	100	120	140	160	180	192							
Access w	ill be r	estricte	ed to t	hese n	umber	s in or	der of	applica	ation re	eceive	d to en	sure	elevate	d gue	est experi	ence
	**Not	te - the	ere wil	l be no	dinne	r servi	ce, onl	y snac	ks to a	ccomp		spons	sible dr	inking	risit of 2 h g, so we f	
															of guests	Additiona Staff per evening at one
	4pm		5pm		6pm		7pm		8pm		9pm		10pm		that evening	
М	4pm		5pm ~~~~	~~~	6pm	,~~~		closed		~~~	9pm	~~~	10pm	~~~		
M T	4pm	2	5pm ~~~~ 2	~~~~	~~~	10				~~~~	9pm ~~~~	~~~	10pm ~~~~	~~~		
Т	4pm	2	~~~	~~~~ 7 13	~~~	10		10	10	_	9pm	~~~	10pm ~~~~	~~~	evening	time
M T W	4pm ~~~		2	-	7		15	10 12	10		~~~	~~~	10pm	~~~	evening 17	time 3
T W	~~~	4	2	13	7 13 26	21	15 17	10 12 22	10 12 20	12	~~~	~~~ 8 40	~~~	14	17 25 51	time 3
T W R	5	4 7	2 8 11	13 21	7 13 26	21 32	15 17 28	10 12 22 30	10 12 20 22	12	12		~~~	14	17 25 51 104	3 3 4 6
T W R	5	4 7 12	2 8 11 24	13 21 34	7 13 26 46 60	21 32 52	15 17 28 40	10 12 22 30 32	10 12 20 22 36	12 26 38	12	40	28		17 25 51 104	3 3 4 6

Giving our members room to spread out in certain areas of the club is key to our vivion. Attendance will be reservation only. The purpose for these limits is to maximize our guests overall experience while at the club. The attendance of 380 visits per week was established on our pro forma by calculating the number of times our average member would attend each month versus our frequent flyers and our low attendance members.

Preliminary Terms of Parking Leases in addition to our 12 spaces:

- Powell Historical Society... 11 of the 12 spots in that lot are available for use during our business hours at an agreed upon price (minus one weekend each year when they host their retreat weekend). This lease we drafted was just returned to us from their lawyer and we are close to signing.
- Powell Center... have agreed upon preliminary structure of lease and pricing to include
   5 spaces as employee parking every night and up to 20 spaces during busier times.


Gretchen Bonasera, member Goodnight Investments, LLC 80 E Olentangy Street, Powell Ohio 43065

#### Projected Membership Attendance & Parking Plan for our 192 Members

\*Note\* Our target membership are those living in the immediate Powell area that is only a \$10 Uber/Lyft ride from home, so that our members can imbibe responsibly. This will also alleviate pressure on our parking situation.

We are happy to have a right in / right out signage plan in place per Chris's suggestion, but would prefer to have it limited to rush hour (same limited hours as other turn restrictions in Downtown Powell).



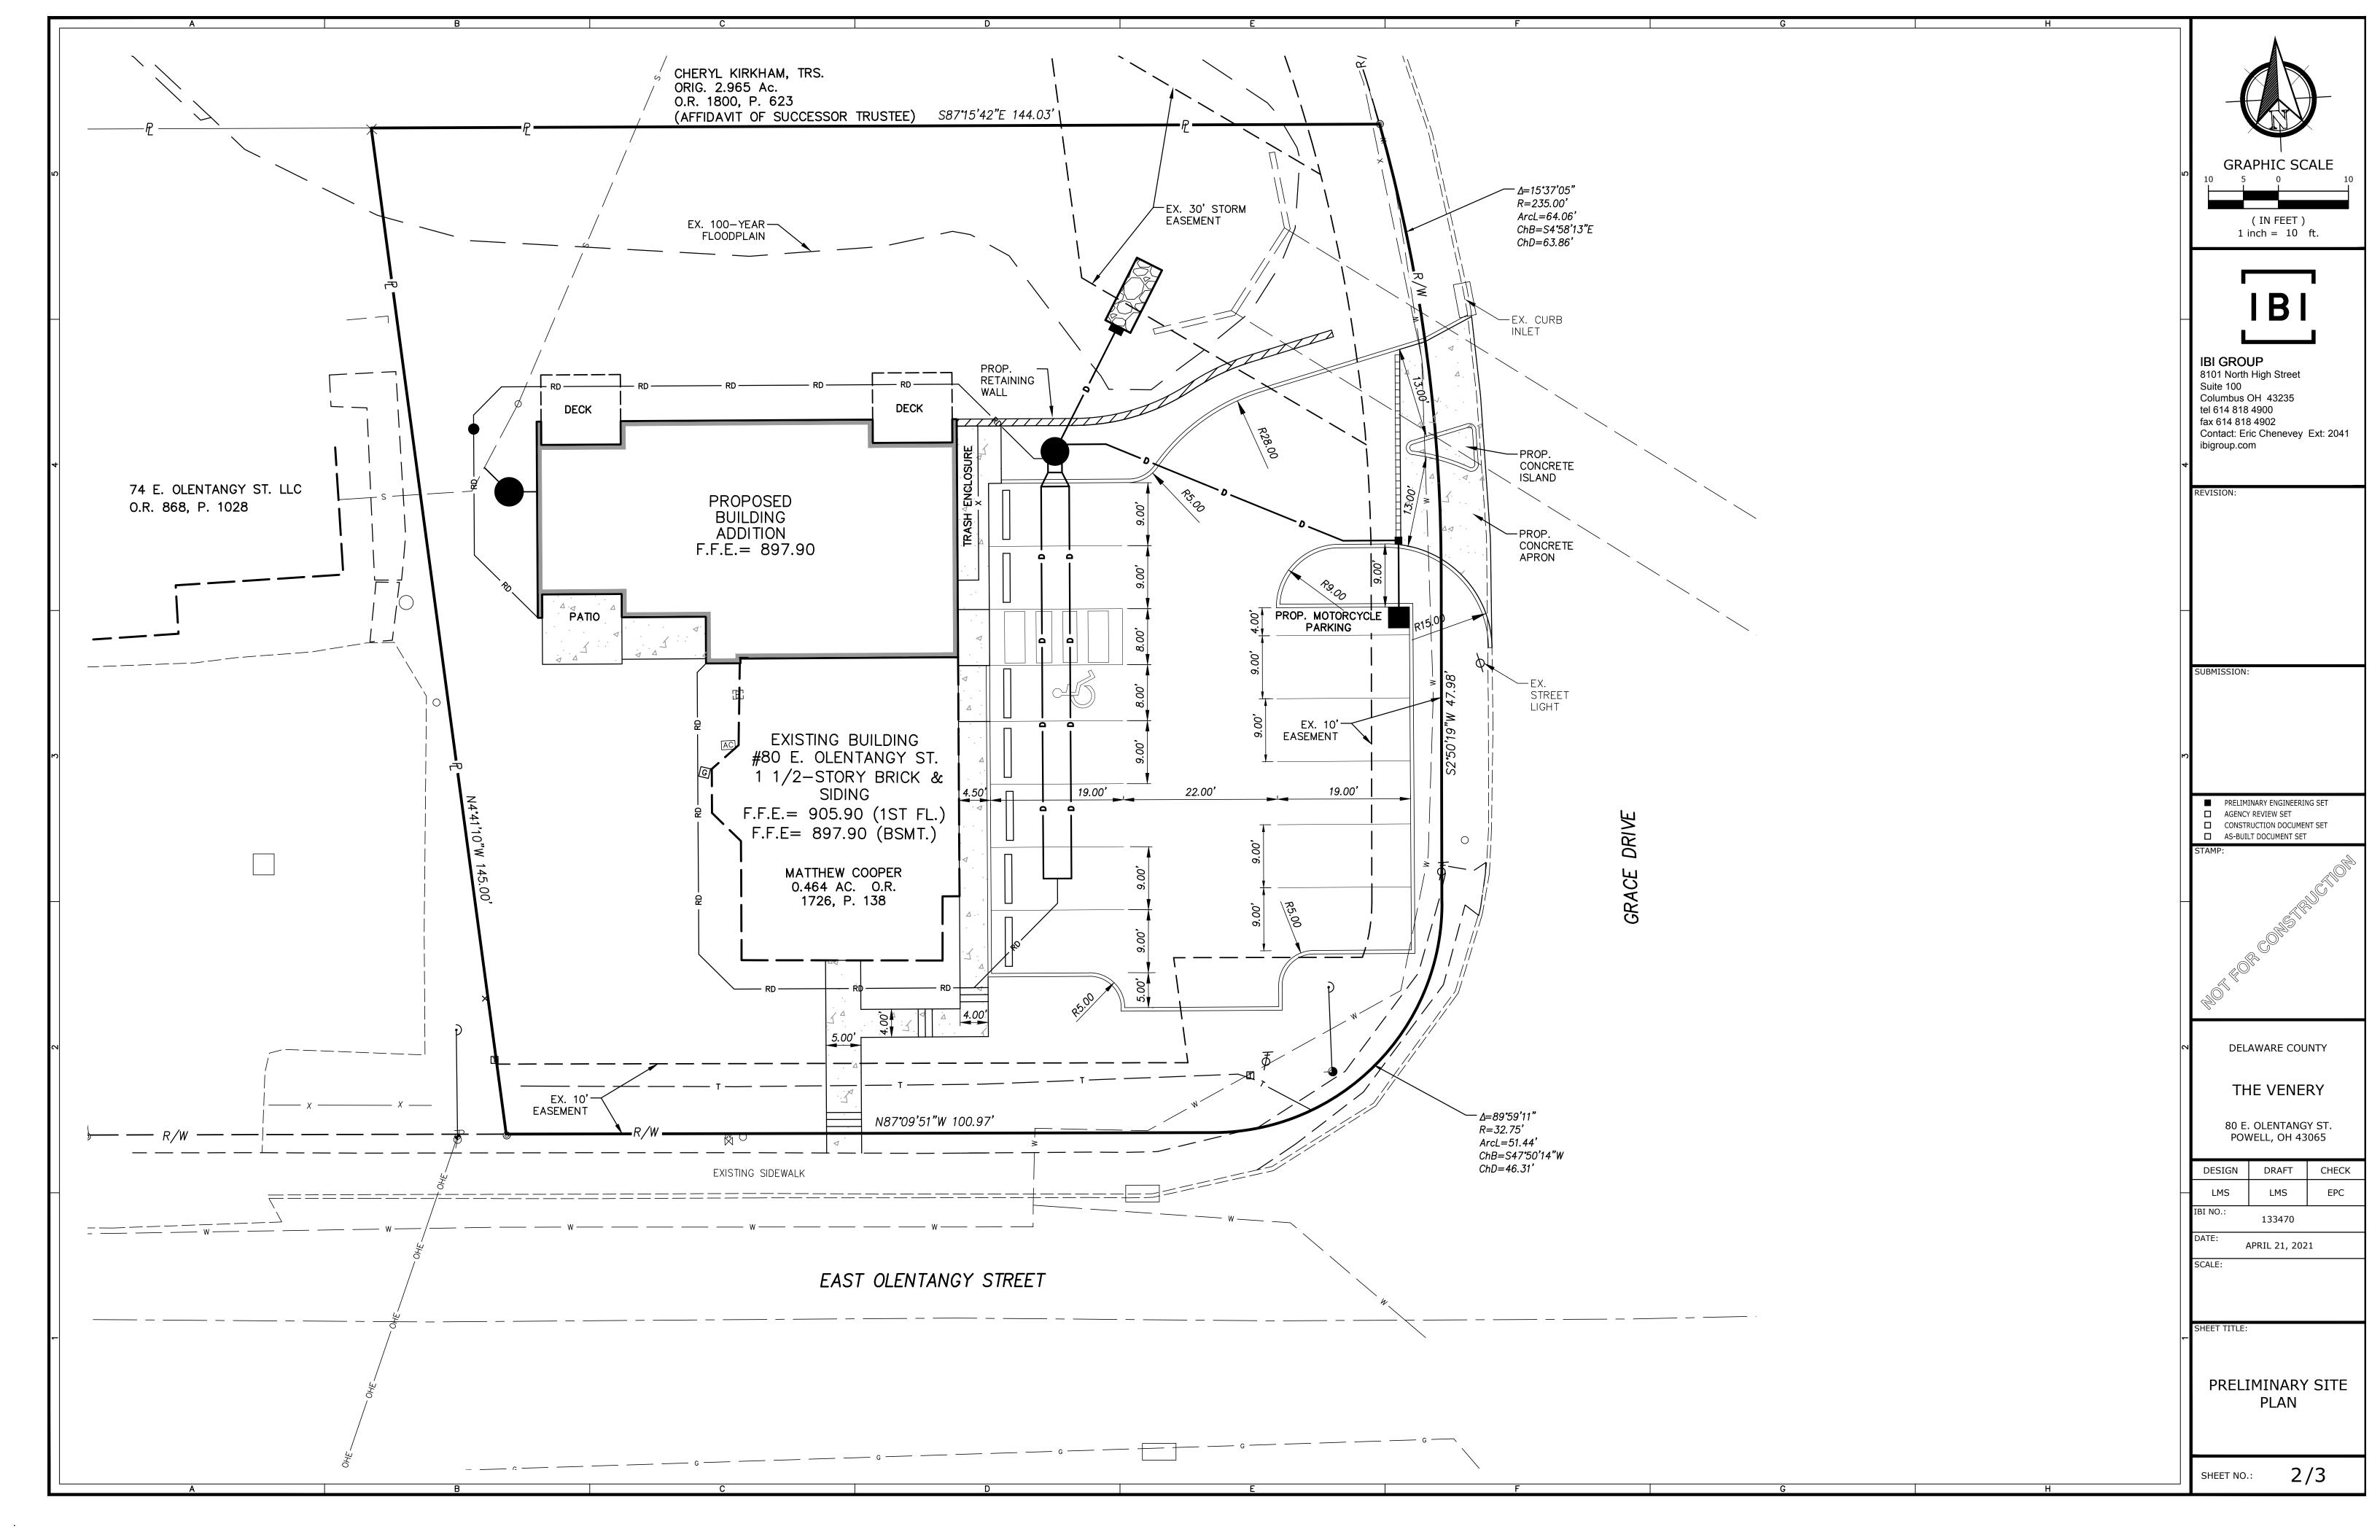



Russell Tree Experts Itd · 3427 E Dublin Granville Rd Westerville, Ohio 43081 · 614-895-7000 · RussellTreeExperts.com

#### **Customer:**

#### Arborist:

Gretchen Bonasera 80 East Olentangy St. Powell, OH 43065 614.477.8030



José Fernández Regional Manager, Russell Tree Experts ISA Board Certified Master Arborist® OH-5129B Jose@RussellTreeExperts.com 614-586-5777

April 7, 2021

Dear Gretchen,

I am pleased to submit my report for the tree inventory at the above address. As stated in Proposal #54617, work completed was to be:

- 1. Locate trees within 12 feet from the perimeter of the new structure that have a trunk diameter of six inches or greater... that cannot be preserved in their current location and condition.
- 2. Advise on whether or not these trees can be relocated.
- 3. Note other trees on site that are recommended as removals due to damage, disease or inappropriate or undesirable species.

The documents in this packet include this letter, one Excel spreadsheet with tree tabulation, and one .pdf of the site plan with my marked-in tree canopy footprint for each tree. All trees inventoried are at least 6 inches in diameter as measured at 24" above grade per your instructions when we met on site yesterday.

Trees were graded as Dead, Poor, Fair, Good. Items considered during grading were tree canopy health, degree of lean, presence of structural flaws, overall tree vigor. A tree graded as Poor would be considered to not be offering much landscape value and is



likely not going to have a long-term presence at the site regardless of human intervention.

#### **Results:**

- 1. There were a total of 22 trees in or within 12 feet of the proposed construction zone as currently shown on the site plan.
  - These trees are highlighted in red on the spreadsheet and written onto the site plan in red ink.
  - Of these 22 trees, 8 were graded as Poor. Tree numbers 1, 13, 18, 21, 25, 26, 28, 30.
- 2. None of these 22 trees are considered good candidates for relocation with a good chance of survival.
- 3. Within the size specification, there were 17 trees on the site that are more than 12 feet away from proposed construction zones.
  - These trees are written onto the site plan with green ink.
  - Of these 17 trees, 2 were graded as Dead or Poor. Tree numbers 5, 14.
  - Removal of these trees is a matter of personal choice.

#### Final observations:

Norway maple is a prominent tree at this site. 7 of the 22 trees within the
proposed construction zone are of this species. 5 of the remaining 17 trees are of
this species. Norway maple is a foreign species of tree that has naturalized.
Currently the Ohio Invasive Plants Council designates this tree species as
"Potentially invasive". This means that currently it is not considered invasive but
its status could change if its invasiveness score increases.

(https://www.oipc.info/assessment-results.html).

2. There are some other trees and shrubs that are considered invasive, such as honeysuckle and Callery pear. All of these were less than 6 inches in diameter so I did not include them in my inventory. If desired, Walter Reins can include these in a removal quote as part of the site preparation when the time comes. Once you are ready to proceed with the removal plan, please contact me and I will share this report with Walter so he can provide a quote.



Thank you for using Russell Tree Experts Consulting Services. Please feel free to call me directly if you wish to discuss this project further or even to meet on site if needed. Also, I can provide more information if you determine that is needed.

Sincerely,

José Fernández

fore Hewand


Regional Manager, Russell Tree Experts ISA Board Certified Master Arborist® OH-5129B

Jose@RussellTreeExperts.com

614-586-5777

#### 80 E Olentangy Tree Survey Schedule April 7, 2021

Number	Species	Common name	Condition	Within 12 feet?	Remove?	Notes
1	Acer platanoides	Norway maple	Poor	Υ	Υ	Hollow/decayed trunk
2	Carya ovata	Shagbark hickory	Good	N	N	
3	Acer platanoides	Norway maple	Fair	N	N	
4	Acer platanoides	Norway maple	Fair	N	N	
5	Acer saccharum	Sugar maple	Dead	N	?	Remove if desired. Currently providing habitat for woodpeckers.
6	Celtis occidentalis	Hackberry	Good	Υ	Υ	
7	Celtis occidentalis	Hackberry	Good	Υ	Υ	
8	Celtis occidentalis	Hackberry	Good	Υ	Υ	
9	Juglans nigra	Black walnut	Good	Υ	Υ	
10	Celtis occidentalis	Hackberry	Good	N	N	
11	Acer platanoides	Norway maple	Fair	N	N	
12	Acer platanoides	Norway maple	Fair	N	N	
13	Acer platanoides	Norway maple	Poor	Υ	Υ	
14	Acer saccharum	Sugar maple	Poor	N	?	Remove if desired. Nearly dead. Can leave as erosion control.
15	Acer saccharum	Sugar maple	Good	N	N	
16	Acer saccharum	Sugar maple	Fair	N	N	
17	Ulmus spp.	Elm	Fair	N	N	
18	Acer platanoides	Norway maple	Poor	Υ	Υ	
19	Acer platanoides	Norway maple	Good	Υ	Υ	
20	Acer platanoides	Norway maple	Fair	Υ	Υ	
21	Acer platanoides	Norway maple	Poor	Υ	Υ	
22	Acer saccharum	Sugar maple	Fair	Υ	Υ	
23	Ulmus spp.	Elm	Fair	Υ	Υ	
24	Acer platanoides	Norway maple	Fair	Υ	Υ	
25	Acer saccharum	Sugar maple	Poor	Υ	Υ	
26	Maclura pomifera	Osage orange	Poor	Υ	Υ	Declining rapidly.
27	Acer saccharum	Sugar maple	Fair	Υ	Υ	
28	Picea pungens 'Glauca'	Colorado blue spruce	Poor	Υ	Υ	Nearly dead.
29	Magnolia x soulangeana	Saucer magnolia	Good	Υ	Υ	,
30	Magnolia x soulangeana	Saucer magnolia	Poor	Υ	Υ	
31	Ginkgo biloba	Ginkgo	Fair	N	N	
32	Prunus serotina	Black cherry	Good	N	N	
33	Acer platanoides	Norway maple	Fair	N	N	
34	Juglans nigra	Black walnut	Good	N	N	
35	Acer saccharum	Sugar maple	Fair	N	N	Multiple codominant stems.
36	Quercus spp.	Oak	Fair	N	N	Street tree
37	Quercus spp.	Oak	Fair	Y	Y	Street tree
	• • • • • • • • • • • • • • • • • • • •			Y		
38	Quercus spp.	Oak	Fair		Y	Street tree
39	Quercus spp.	Oak	Fair	Υ	Υ	Street tree

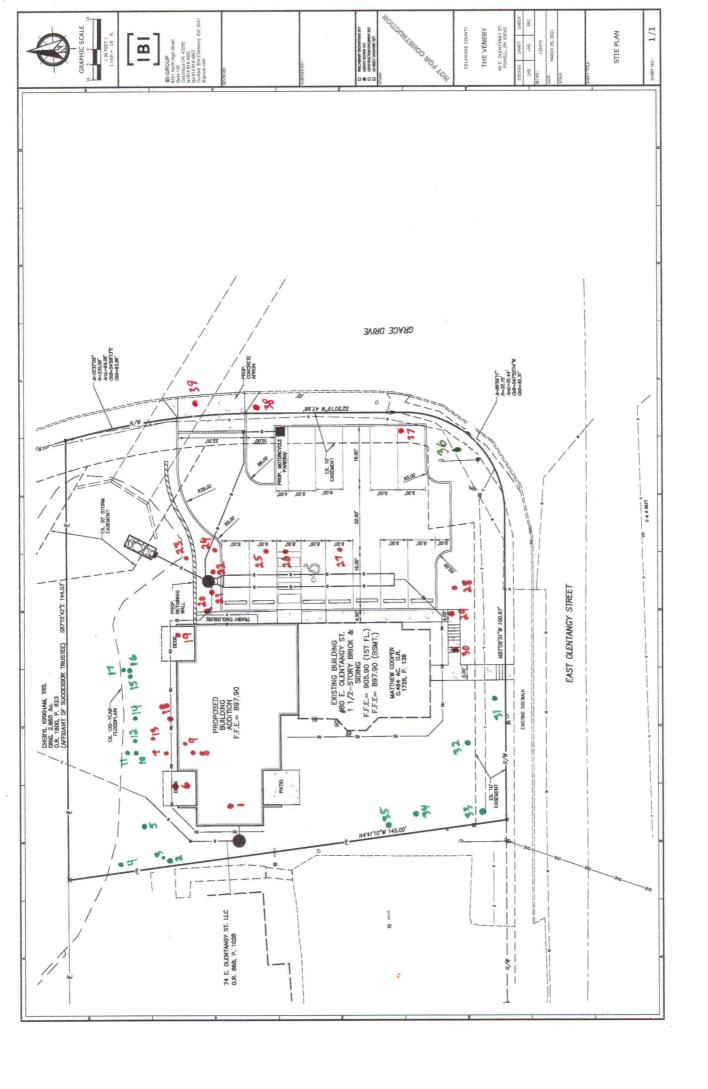

POWELL, OHIO 43065

# ABREVIATIONS

@ = ATG = GASGA = GAUGEAB = ANCHOR BOLT A/C = AIR CONDITIONING GALV = GALVANIZED GC = GENERAL CONTRACTOR ADJ = ADJACENTAFF = ABOVE FINISHED FLOOR GEN L = GENERAL AFS = ABOVE FINISHED SLAB GL = GLASSALS = ACRYLIC LATEX SEALANT GR = GRANITE GRND = GROUND ALUM = ALUMINUM ANOD = ANODIZED ARA = AREA OF RESCUE ASSISTANCE AP = ACCESS PANEL APPROX = APPROXIMATELY HB = HOSE BIBB

ARCH = ARCHITECT AS = ACOUSTICAL SEALANT B/ = BOTTOM OF B/B = BACK TO BACK BD = BOARDBFG = BELOW FINISHED GRADE BLDG = BUILDING

BLK = BLOCK (BLOCKING)BM = BEAMBMT = BUTYL MASTIC TAPE SEALANT BRK = BRICKBRS = BUTYL RUBBER SEALANT BRZ = BRONZEBSMT = BASEMENT BTW = BETWEENBYD = BEYOND

C/C = CENTER TO CENTERCIP = CAST-IN-PLACE CEM = CEMENTCER = CERAMICCFL = COUNTERFLASH (ING) CJ = CONTROL JOINT CL = CENTER LINE CLG = CEILING

CT = CERAMIC TILE

CTSK = COUNTERSINK

CLO = CLOSET CLR = CLEAR OPENING CMU = CONCRETE MASONRY UNIT CO = CLEAN OUT COL = COLUMNCONC = CONCRETE CONST = CONSTRUCTION CONTR - CONTRACTOR CONT = CONTINUOUS COOR = COORDINATE CORR = CORRIDOR CPT = CARPET

CTR = CENTER CU = CUBICDB = DIRECT BURIAL DBL = DOUBLEDD = DECK DRAINDIA = DIAMETER DIFF = DIFFUSER DIM = DIMENSION DIR = DIRECTION DN = DOWNDR = DOORDS = DOWN SPOUT DTL = DETAILDW = DRY WALL MGT = MANAGEMENT

DWG(S) = DRAWING(S)EA = EACHEB = EXPANSION BOLT EC = EXPOSED CONSTRUCTION EF = EXHAUST FANEJ = EXPANSION JOINT EL = ELEVATORELEC = ELECTRIC ELEV = ELEVATION EOS = EDGE OF SLAB EQ = EQUALEQUIP = EQUIPMENT EXTG = EXISTING

F = FEMALEFA = FIRE ALARM FACP = FIRE ALARM CONTROL PANEL FB = FACE BRICK F/C = FAN COILFD = FLOOR DRAIN FE = FIRE EXTINGUISHER FEC = FIRE EXTINGUISHER CABINET FF = FINISHED FLOOR FIN = FINISH (ED)FIXT = FIXTURE FLR = FLOOR FLUOR = FLUORESCENT

EXT = EXTERIOR

FND = FOUNDATION FOC = FACE OF CONCRETE FOF = FACE OF FINISH FOS = FACE OF STUD FSD = FIRE SEPARATION DISTANCE FRT = FIRE RETARDANT TREATED FT = FEETFTG = FOOTING FV = FIELD VERIFY

# QT = QUARRY TILE

QTY = QUALITY

R = RADIUSRA = RETURN AIR

QUANT = QUANTITY

RB = RESILIENT BASE

RD = ROOF DRAIN

REF = REFERENCE

REG = REGISTER

REV = REVISION

RFL = REFLECTED

RMV = REMOVE

SA = SUPPLY AIR

SECT = SECTION

SHTG = SHEATHING

SPEC = SPECIFICATION

SQYD = SQUARE YARD

SS = STAINLESS STEEL

ST = SEALANT TAPE

STD = STANDARD

STOR = STORAGE

T = TOWNHOUSE

TEL = TELEPHONE

TH = TOWNHOUSE

THK = THICK (NESS)

THR = THRESHOLD

UG = UNDERGROUND

UNO = UNLESS NOTED OTHERWISE

VCT = VINYL COMPOSITION TILE

VWC = VINYL WALL COVERING

UNF = UNFISNISHED

TYP = TYPICAL

UC = UNDERCUT

VA = VOLT-AMPS

VERT = VERTICAL

VEST = VESTIBULE

VIF = VERIFY IN FIELD

VAL = VALVE

W = WEST

W/ = WITH

W/O = WITH OUT

WD = WOOD

WT = WEIGHT

YD = YARD

WDW = WINDOW

WPT = WORK POINT

WC = WATER CLOSET

WCO = WALL CLEAN OUT

WPR = WATERPROOFING

WWF = WELDED WIRE FABRIC

WRB = WEATHER RESISTIVE BARRIER

TEMP = TEMPERATURE

STRUCT = STRUCTURAL

SUSP = SUSPENDED

STL = STEELSTM = STORM

SYS = SYSTEM

T/ = TOP OF

SHT = SHEET

SIM = SIMILAR

SQ = SQUARESQFT = SQUARE FEET

RO = ROUGH OPENING RoW = RIGHT OF WAY

SD = SMOKE DETECTOR

SGG = SILICONE GLAZING GASKET

SJS = SILICONE JOINT SEALANT

SGS = SILICONE GLAZING SEALANT

RI = RISER

S = SOUTH

RM = ROOM

RGTR = REGISTER

REINF = REINFORCED

REQ D = REQUIRED

RC = REINFORCED CONCRETE

GST = GLAZED STRUCTURAL TILE

GWB = GYPSUM WALL BOARD BDW = HARDWARE HDWD = HARDWOOD HM = HOLLOW METAL HORIZ = HORIZONTAL HR = HOURHS = HIGH STRENGTH HT = HEIGHT HVAC = HEATING, VENTILATION, A/C

ID = INSIDE DIAMETER IG = INSIDE GLAZED IN = INCHINFO = INFORMATION INSUL = INSULATION INT = INTERIOR

J = JOISTJAN = JANITOR JB = JUNCTION BOX JC = JANITORS CLOSET KIT = KITCHEN

KP = KICK PLATE

L = LENGTHLAM = LAMINATE (D) LAV = LAVATORY LB = POUNDLBL = LABELLH = LEFT HAND LIN = LINEARLLH = LONG LEG HORIZONTAL LLV = LONG LEG VERTICAL LNFT = LINEAR FEET LP = LOW POINT

LT(G) = LIGHTING(ING)LVPL = LEVELING PLATE LVR = LOUVERM = MALEMACH = MACHINE MAINT = MAINTENANCE MAR = MARBLE MAS = MASONRY MATL = MATERIAL

MAX = MAXIMUMMDF = MEDIUM DENSITY FIBER MDO = MEDIUM DENSITY OVERLAY MECH = MECHANICAL MEMB = MEMBRANE MEZZ = MEZZANINE MFD = MANUFACTURED MFR = MANUFACTURER MGR = MANAGER

MH = MAN HOLE MIN = MINIMUM MIR = MIRROR MISC = MISCELLANEOUS MO = MASONRY OPENING MP = METAL PANEL MTD = MOUNTED MTG = MEETINGMTL = METAL

N = NORTHNAT = NATURAL NIC = NOT IN CONTRACT NO = NUMBERNOM = NOMINAL NTS = NOT TO SCALE

O.R.C. = OHIO RESIDENTIAL CODE OA = OVERALL OC = ON CENTER OD = OUTSIDE DIAMETER OH = OPPOSITE HAND O/O = OUT TO OUT OPNG = OPENING OPP = OPPOSITE OZ = OUNCE

PARTN = PARTITION PC = PERPENDICULAR PCP = PRECAST CONCRETE PLATE PERF = PERFORATED PFN = PREFINISH (ED) PH = PHASEP/L = PROPERTY LINE PL = PLATEPLAM = PLASTIC LAMINATE PLY WD = PLY WOOD PR = PAIRPREFAB = PREFABRICATED PSF = POUNDS PER SQUARE FOOT PSI = POUNDS PER SQUARE INCH P.T. = PRESSURE TREATED

PTD = PAINTED

# SYMBOLS LEGEND

DETAIL NO. SHEET NO.	BUILDING SECTION	AREA NAME	AREA TAG
A101	BOILDING SECTION	100 SF	ARLA TAG
DETAIL NO. SHEET NO.		ROOM NAME	
1) A101	WALL SECTION	101	ROOM TAG
DETAIL NO. SHEET NO.		150 SF	
SIM A101	DETAIL SECTION	(1) NOTE	CODED NOTE
DETAIL NO.  SHEET NO.  DETAIL  AREA  SIM	DETAIL CALLOUT	?	KEYNOTE
DETAIL NO.  SHEET NO.  DETAIL NO.	EXTERIOR ELEVATION	1	REVISION TAG
1 A101 1	INTERIOR ELEVATION	W22	WALL TAG
	ELEVATION	Ā	WINDOW TAG
XXX.X'	SPOT ELEVATION	101)	DOOR TAG
	STURCTURAL GRID LINE		FLOOR/ROOF TAG
	MATCH LINE	(ÁCÌ)	ACCESSORY TAG

CENTERLINE

DETAIL NO.			
1 SIM A101	BUILDING SECTION	AREA NAME 100 SF	AREA TAG
DETAIL NO. SHEET NO. SI M		ROOM NAME	
A101	WALL SECTION	101	ROOM TAG
DETAIL NO.		150 SF	
1 SIM A101	DETAIL SECTION	(1) NOTE	CODED NOTE
DETAIL NO. SHEET NO.			
DETAIL 1 <sub>1</sub> A5.00 SIM	DETAIL CALLOUT	?	KEYNOTE
DETAIL NO. SHEET NO.			
1 A101 1	EXTERIOR ELEVATION	1	REVISION TAG
DETAIL NO.  SHEET NO.			
1 (A101) 1	INTERIOR ELEVATION	W22	WALL TAG
1			
- <b>LEVEL</b> 876' - 0"	ELEVATION	\rightarrow	WINDOW TAG
XXX.X'			
	SPOT ELEVATION	101	DOOR TAG
	STURCTURAL GRID LINE		FLOOR/ROOF TAG
	MATCH LINE	〈AC1〉>	ACCESSORY TAG

# MATERIALS LEGEND

SITEWORK  EARTH	GRAVEL	GEOLOGICAL ROCK
CONCRETE  CIP/PRECAST	GROUT	+ + + + + + + + MORTAR
MASONRY BRICK	CMU	FIREBRICK
STONE  CUT STONE	RUBBLE	SLATE
METAL STEEL	ALUMINUM	BRASS
WOOD	ROUGH	BLOCKING
PLYWOOD (LARGE SCALE)	PLYWOOD (SMALL SCALE)	CORK
FINISHES PLASTIC	GYPSUM PLASTER	CERAMIC TILE
NSULATION  BATT/ LOOSE	RIGID	SPRAY FOAM
31 ΔSS		

# HDAC DRAWING INDEX

PROJECT SUMMARY

DELAWARE COUNTY PARCEL NO. 31942513051002

OCCUPANCY WITH ALTERATIONS TO AN EXISTING

2,461 SF IIIB STRUCTURE LOCATED WITHIN THE

VILLAGE OF POWELL, OHIO. A 2,083 SF ADDITION

OF TYPE VB CONSTRUCTION WILL BE ADDED TO

ACCOMMODATE AN A-2 ASSEMBLY OCCUPANCY

UTILITY AND CIRCULATION AS REQUIRED FOR A

WITH SUPPORTING OFFICE, RESTROOMS, STORAGE,

THE NORTH. THESE COMBINED SPACES WILL

THE PROJECT CONSISTS OF A CHANGE OF

0.46 ACRES

PRIVATE SOCIAL CLUB.

PARCEL SUMMARY:

PROJECT DESCRIPTION:

NO.	NAME	REVISION NO.	REVISIO DATE
INT.	Unnamed		
01 - GEN	NERAL		
G0.00	COVER SHEET	T	
G0.01	ARCHITECTURAL SITE PLAN		+
G1.02	LIFE SAFTEY FLOOR PLANS + BUILDING SECTIONS		+
05 - CIV	IL		
C1	SITE PLAN		
06 - LAN	IDSCAPE		
L1.00	LANDSCAPE		
	CHITECTURAL DEMOLITION		
	BASEMENT + LEVEL 1 DEMOLITION PLANS	+	+
AD1.02	LEVELS 2-3 DEMOLITION PLANS		
09 - ARG	CHITECTURAL		
A1.00	FOUNDATION PLAN		
A1.01	EXTG. BASEMENT + NEW LEVEL 1 PLAN	+	+
A1.02	EXTG. LEVEL 1 PLAN	+	+
A1.03	NEW MEZZANINE PLAN	+	+
A1.04	EXTG. ATTIC	+	+
A1.05	ROOF PLAN	+	+
A2.00	BUILDING ELEVATIONS	+	+
A2.01	BUILDING ELEVATIONS	+	+
A4.11	ENLARGED EXTERIOR SITE DETAILS	+	+
A5.01	WALL SECTIONS + DETAILS	+	+
A5.02	WALL SECTIONS + DETAILS	+	+
A8.00	RENDERINGS	+	+
A8.01	RENDERINGS	+	+
A8.02	MATERIAL PALETTE	+	+
A8.03	SITE LIGHTING	+	+
	SITE EIGITING		+
A8.04	EXISTING IMAGES		

# PROJECT DIRECTORY

Owner: Goodnight Investments Michael + Gretchen Bonasera thefoodsmith@foodsmith.com Owner Phone No. SJM studio, LLC **Architect:** Sarah Mackert sjm@sjmstudiollc.com (937) 215-0845 Civil Engineer: IBI Group **Eric Chenevey** eric.chenevey@ibigroup.com 614.679.3645 Structural Engineer: Ehlers Engineering, LLC Derek Ehlers, PE derek@ehlersengineering.com 614.330.2298 MEP Engineer: Allemang Engineering, LLC Donald K. Allemang, PE dalleman@columbus.rr.com 614.580.9006 **General Contractor: Lincoln Construction** Greg Schmitt gschmitt@lincolnconstruction.com 614.457.0180

# APPLICABLE CODES

VILLAGE OF POWELL, PLANNING AND ZONING CODE 2017 OHIO BUILDING CODE (OBCO + AMENDMENTS 2017 OHIO PLUMBING CODE (OPC) + AMENDMENTS 2017 OHIO MECHANICAL CODE (OMC) + AMENDMENTS 2017 NATIONAL ELECTRIC CODE (NEC) | NFPA 70 ICC A117.1-2009 ACCESSIBLE + USABLE BUILDINGS + FACILITIES 2012 INTERNATIONAL ENERGY CONSERVATION CODE + AMENDMENTS 2015 INTERNATIONAL FUEL GAS CODE ASHRAE 90.1 2010 NATIONAL FIRE ALARM + SIGNALING CODE (NFPA 72-10) OHIO FIRE CODE 2017

# VICINITY MAP



#\DATE

www.SJMstudiollc.com

This drawing is for review purposes only.

PROJECT TITLE


PROJECT NO. SJM\_2010 ISSUE FINAL P&Z APPLICATION **ISSUE DATE** 04.21.2021 SHEET TITLE

**COVER SHEET** 

SHEET NO.

80 E **OLENTANGY** POWELL, OHIO 43065

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ARCHITEC 1" = 10'-0"

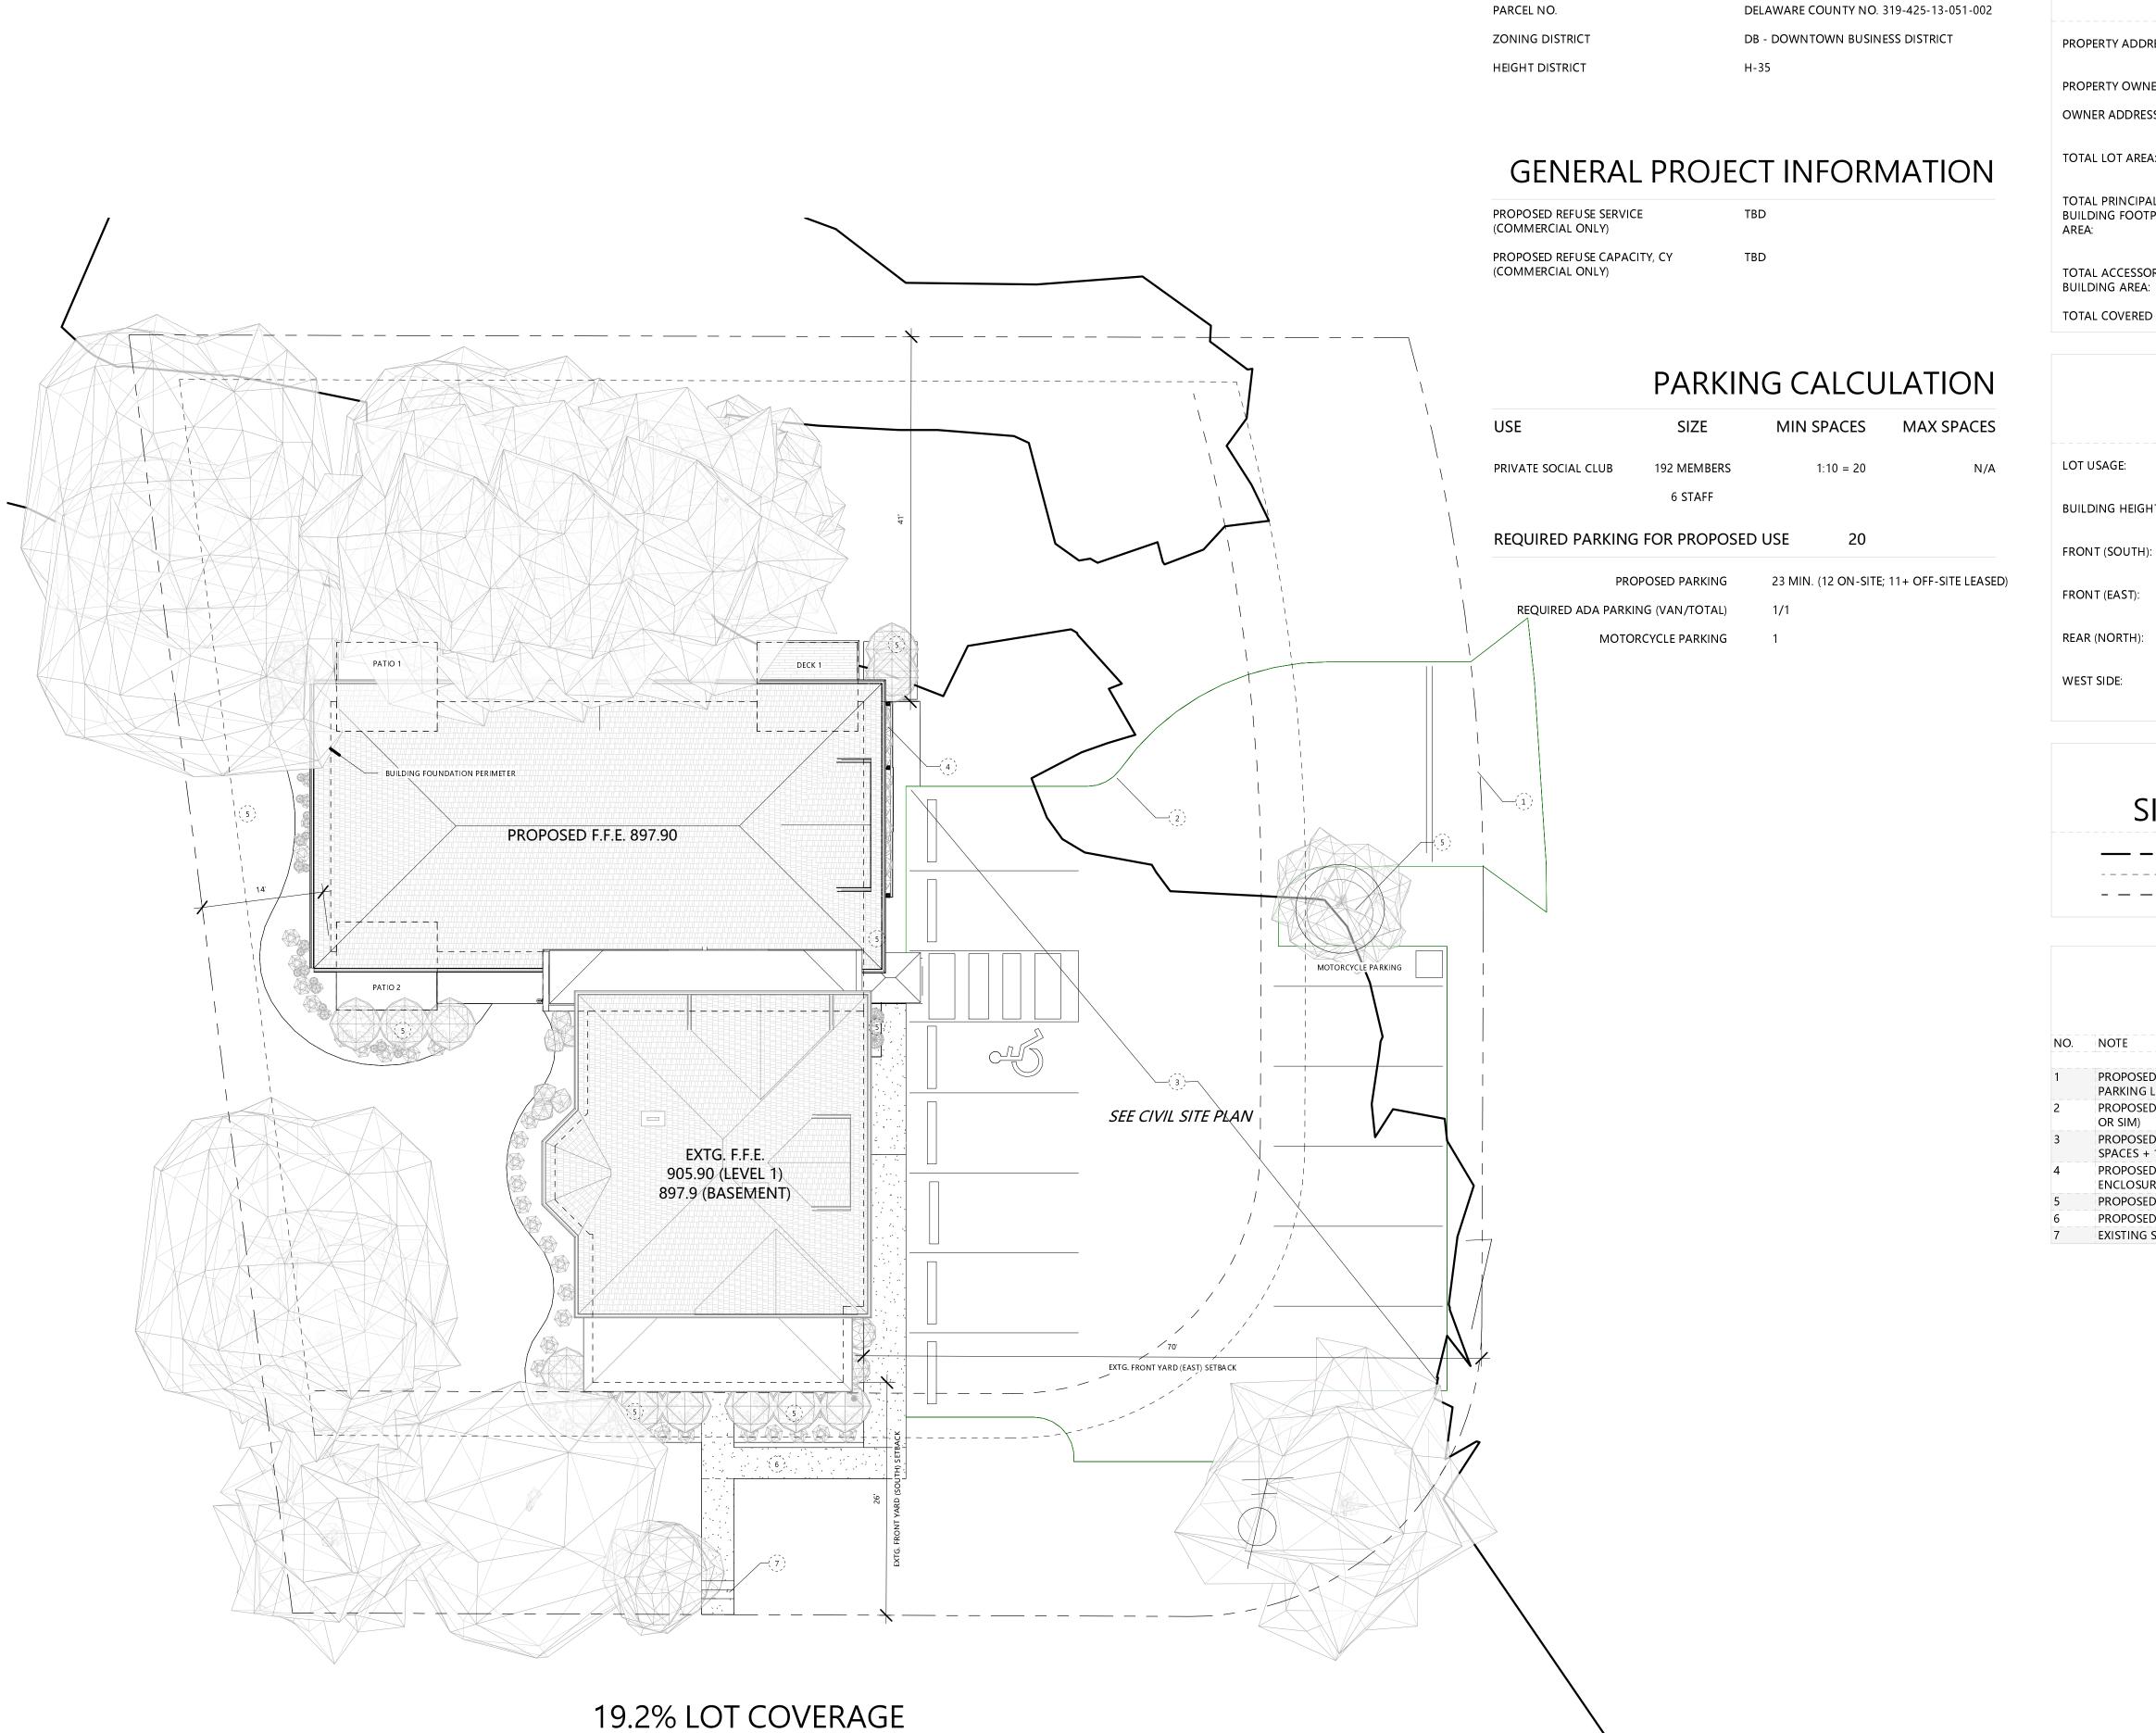ARCHITECTURAL SITE PLAN

## SITE DATA

 $^{/}$  not for construction  $^{\circ}$ 

**PRELIMINARY** 

contained is not necessarily coordinated or correct
This drawing is for review purposes only.

PROPERTY ADDRESS: 80 E OLENTANGY POWELL, OH 43065

GENERAL ZONING INFORMATION

GOODNIGHT INVESTMENTS PROPERTY OWNER: OWNER ADDRESS: 4200 MACDUFF WAY DUBLIN, OH 43016

TOTAL LOT AREA: 20,201.79 SF / 0.46 ACRES

TOTAL PRINCIPAL 1,304.3 SF EXISTING BUILDING BUILDING FOOTPRINT 1,817.3 SF NEW ADDITION 120.0 SF NEW DECK 257.5 SF NEW PATIO

3,449.1 SF TOTAL TOTAL ACCESSORY BUILDING AREA:

TOTAL COVERED AREA: 3,449.1 SF OR 17.3%

# SITE SCHEDULE

20% MAX. ALLOWABLE 17.3% PROPOSED

35.00' MAX. ALLOWABLE BUILDING HEIGHT: 19.00' PROPOSED

> 20' MIN - 25' MAX ALLOWABLE 26' EXISTING

20' MIN - 25' MAX ALLOWABLE 70' EXISTING

REAR (NORTH): 5.00' MIN. ALLOWABLE 41' PROPOSED

WEST SIDE: 5.00' MIN. ALLOWABLE 14' PROPOSED

# SITE PLAN LEGEND

MINIMUM SETBACK LINE — — — — MAXIMUM SETBACK LINE

### SITE PLAN NOTES

PROPOSED CURB CUT AND DRIVE ACCESS TO NEW PARKING LOT

PROPOSED SEGMENTAL RETAINING WALL (VERSA-LOK OR SIM)

PROPOSED OFF STREET PARKING (12 VEHICULAR SPACES + 1 MOTORCYCLE SPACE). SEE CIVIL PLAN. PROPOSED REFUSE, RECYCLING AND MISC. STORAGE

PROPOSED LANDSCAPING, SEE LANDSCAPE PLAN L1.00 PROPOSED NEW PPEDESTRIAN WALK

EXISTING STEPS TO REMAIN

# DATE REVISION

www.SJMstudiollc.com

PROJECT TITLE


80 E **OLENTANGY** POWELL, OHIO 43065


PROJECT NO. SJM\_2010 ISSUE FINAL P&Z APPLICATION **ISSUE DATE** SHEET TITLE


ARCHITECTURAL SITE PLAN

SHEET NO.


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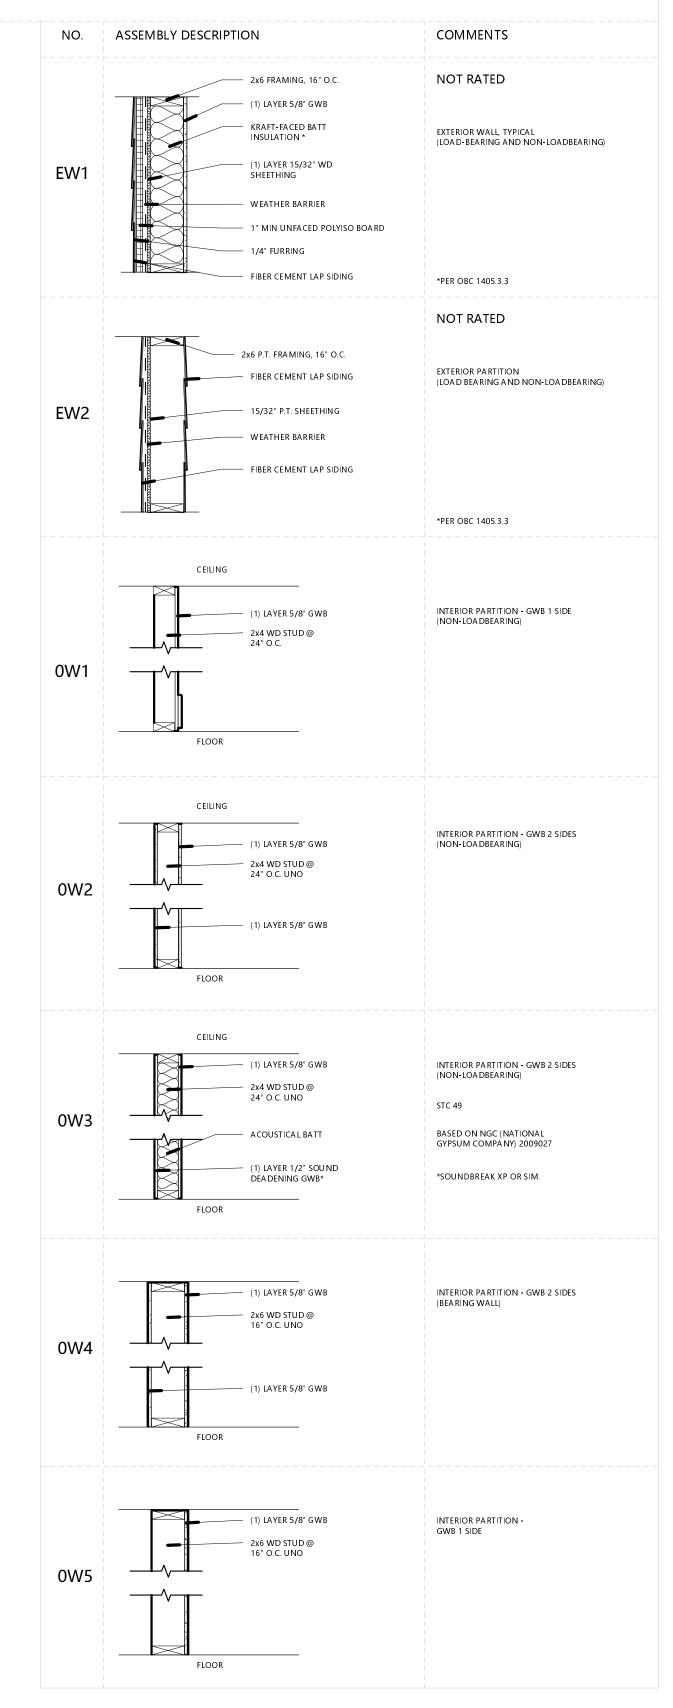


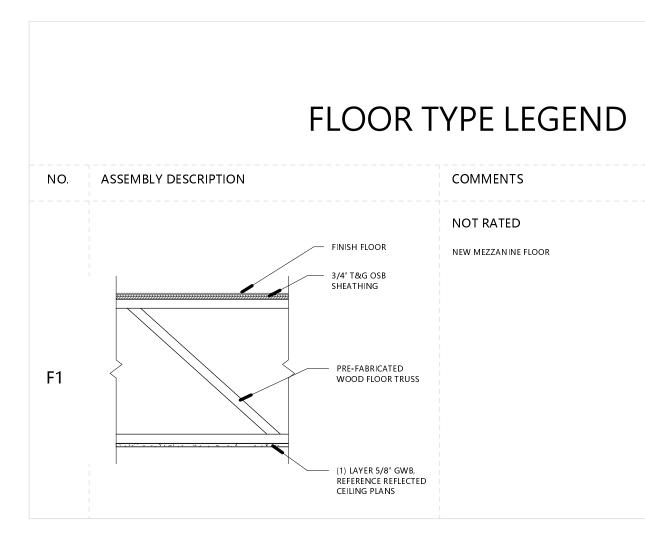

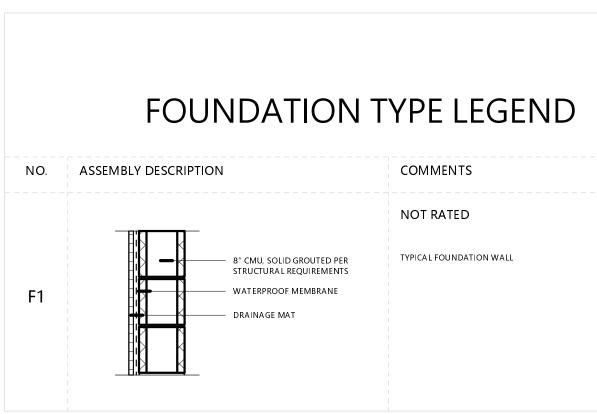
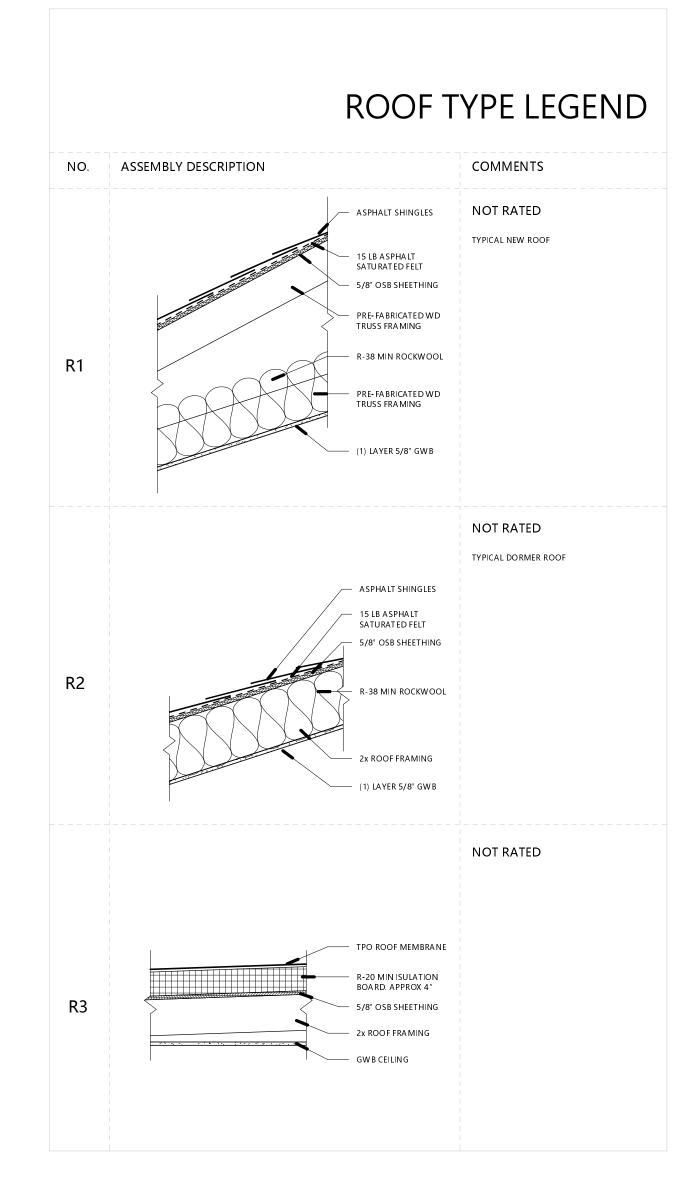
# WALL TYPE LEGEND



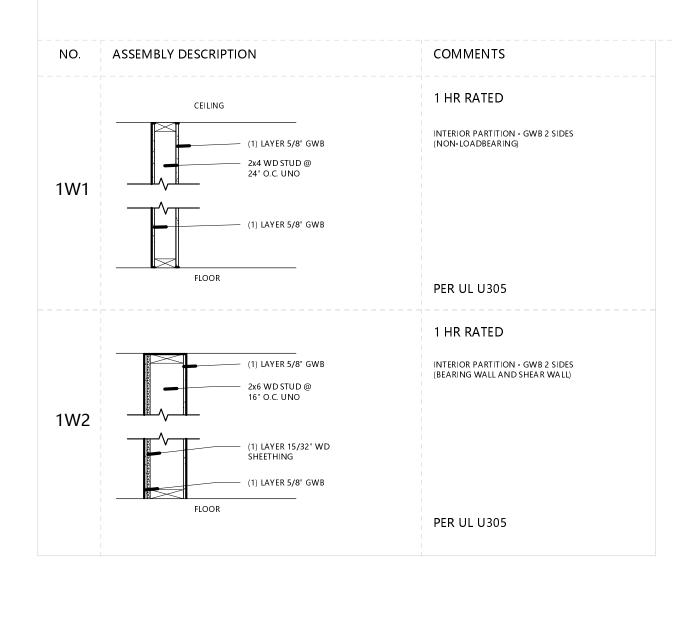

REFERENCE WALL SECTIONS FOR EXTERIOR WALL DETAILS & ENLARGED FLOOR PLANS FOR ACOUSTIC BATT INSULATION.

\*\*GWB APPLIED VERTICALLY OR HORIZONTALLY WITH 6d COOLER OR WALLBOARD NAILS @
7" O.C. W/ END JOINTS ON NAILING MEMBERS. STAGGER JOINTS EA. SIDE.

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PRELIMINARY

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# DATE REVISION

PROJECT TITLE

**80 E OLENTANGY**POWELL, OHIO 43065

PROJECT NO. SJM\_2010


ISSUE FINAL P&Z APPLICATION

ISSUE DATE 04.21.2021

FLOOR, CEILING, & WALL ASSEMBLIES

SHEET NO.

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- 2. SEE G1.02 G1.03 FOR EXTENTS AND TECHNICAL DETAILS OF FIRE-RATED BARRIERS, FIRE-RATED PARTITIONS AND SHAFT WALLS.
- SEE G1.04 FOR UL ASSEMBLIES.
   SEE G1.10 FOR TYPICAL ACCESSIBLE CLEARANCES AND DETAILS.
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- INTERIOR DIMENSIONS ARE TO FACE OF STUD UNO.
  VERIFY ALL DIMENSIONS PRIOR TO BEGINNING WORK
  AND NOTIFY ARCHITECT FOR RESOLUTION OF ANY
  DISCREPANCIES.
- EXTEND FIRE BARRIERS TO UNDERSIDE OF DECK ABOVE UNO.
- 9. PROVIDE SOUND BATT INSULATION AT ALL TOILET ROOMS AND MECHANICAL ROOMS.
- 10. PROVIDE 5/8" CEMENT BACKER BOARD AT ALL TILE WALL LOCATIONS W/ BLOCKING BEHIND ALL CEMENT BACKER BOARD SEAMS.
- . PROVIDE 5/8" MOISTURE RESISTANT GWB AT ALL WET WALL LOCATIONS.
- 2. COMPLY WITH MANUFACTURER INSTRUCTIONS FOR INSTALLATION OF BUILDING MATERIALS AND FF&E.

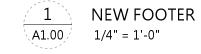  3. LOCATION AND SIZE OF PENETRATIONS/MEMBRANE
- PENETRATIONS OF FIRE-RATED ASSEMBLIES ARE
  APPROXIMATE. GC TO FIELD VERIFY SIZE AND
  LOCATION.

  14 CONSULT OWNER TO VERIFY PROJECT SALVAGE
- 14. CONSULT OWNER TO VERIFY PROJECT SALVAGE REQUIREMENTS OF ITEMS NOT IDENTIFIED FOR REUSE HERE PRIOR TO REMOVAL START.
- 15. PROTECT EXISTING ORIGINAL ARCHITECTURE THROUGHOUT INCLUDING WINDOWS, DOORS, MISC. GLASS, CASEWORK, MILLWORK, STAIRS, RAILINGS, HARDWARE AND (TO THE GREATEST EXTENT POSSIBLE) PLASTER.
  - COMMERCIAL SPACE SCOPE:

    A. GC TO PROVIDE "WARM GRAY BOX 
    INCLUDING PLUMBING ROUGH-INS,
    ELECTRICAL SERVICE, TEMPORARY HEAT,
    LEVEL 4 FINISH ALL GWB SURFACES

### FLOOR PLAN NOTES

#### NO. NO

- EXTG. VENTILATION OPENINGS IN CRAWL SPACE
- FOUNDATION WALL, TYP. OF (3)
- REMOVE EXTG. STONE MASONRY AS REQ'D TO PROVIDE NEW SECURE, INSULATED CRAWL SPACE ACCESS PANEL. EXTG. SPLIT SYSTEM AHU TO REMAIN. RECONFIGURE
- EXTG. DUCTWORK AS REQ'D TO ACCOMODATE
  OVERHEAD CLEARANCE IN BASEMENT ROOM 1 AND 2
  PROVIDE NEW OPENING IN EXTG. LOAD BEARING
- MASONRY WALL
  PROVIDE NEW 4" CONC. SLAB THROUGHOUT BASEMENT
  PROVIDE NEW 8" DOUBLE WYTHE BRICK MASONRY
- WALL ON 16" WIDE X 8" DEEP REINFOCED CONC.
  FOOTER AS INDICATED
  MAINTAIN AS EMERGENCY EGRESS OPENING
- NEW 90 MINUTE FIRE-RATED DOOR IN EXTG. OPENING
  INFILL EXTG. WINDOW OPENING W/ MASONRY TO
  MATCH EXTG.
- 11 INFILL EXTG. DOOR OPENING W/ MASONRY TO MATCH EXTG.
- GLASS GUARDRAIL, 42"
- 65 GALLON REFUSE / RECYCLING TOTES AND/OR LAWNCARE AND MAINTENANCE STORAGE CONCEALED IN REFUSE ENCLOSURE
- 16 MAINTAIN AS EMERGENCY EGRESS OPENING

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# DATE REVISION

PROJECT TITLE

**80 E OLENTANGY**POWELL, OHIO 43065


PROJECT NO. SJM\_2010
ISSUE FINAL P&Z APPLICATION

ISSUE DATE 04.21.2021
SHEET TITLE

FOUNDATION PLAN

SHEET NO.

41.00

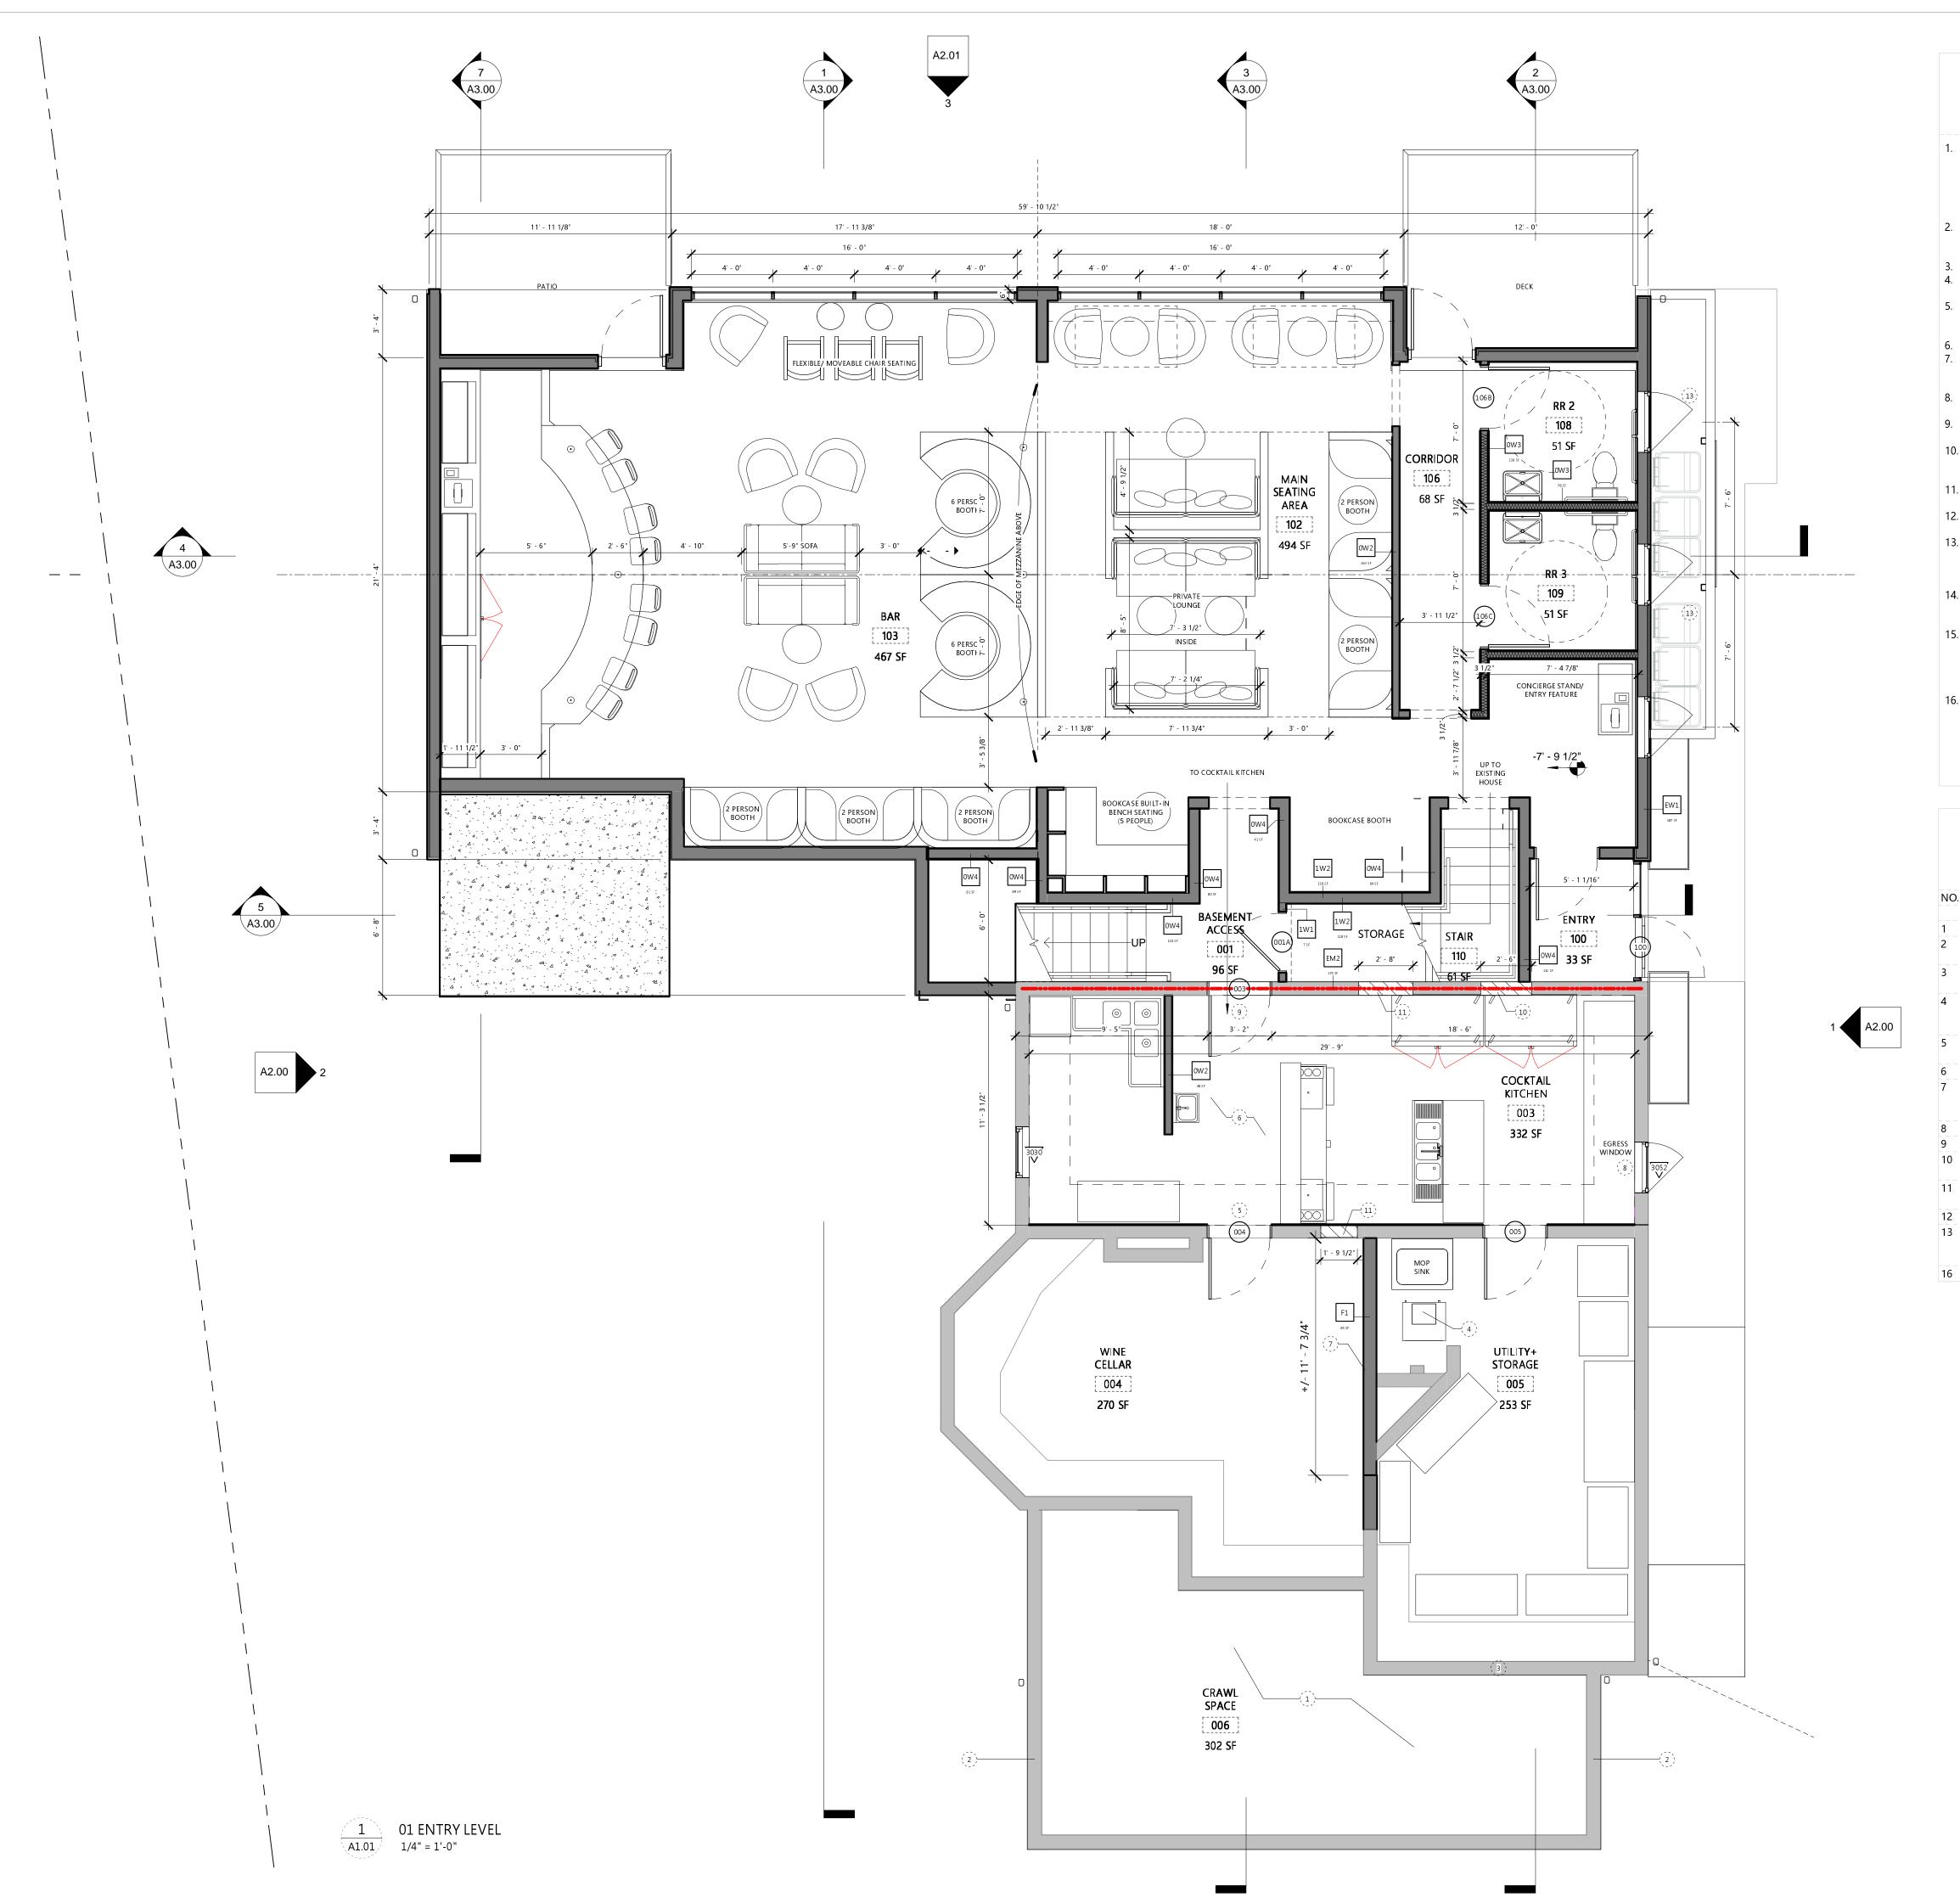



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- ROOMS AND MECHANICAL ROOMS.

  0. PROVIDE 5/8" CEMENT BACKER BOARD AT ALL TILE
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- PROVIDE 5/8" MOISTURE RESISTANT GWB AT ALL WET WALL LOCATIONS.
- 2. COMPLY WITH MANUFACTURER INSTRUCTIONS FOR INSTALLATION OF BUILDING MATERIALS AND FF&E.
- 13. LOCATION AND SIZE OF PENETRATIONS/MEMBRANE PENETRATIONS OF FIRE-RATED ASSEMBLIES ARE APPROXIMATE. GC TO FIELD VERIFY SIZE AND LOCATION.
- 4. CONSULT OWNER TO VERIFY PROJECT SALVAGE REQUIREMENTS OF ITEMS NOT IDENTIFIED FOR REUSE HERE PRIOR TO REMOVAL START.
- 15. PROTECT EXISTING ORIGINAL ARCHITECTURE THROUGHOUT INCLUDING WINDOWS, DOORS, MISC. GLASS, CASEWORK, MILLWORK, STAIRS, RAILINGS, HARDWARE AND (TO THE GREATEST EXTENT POSSIBLE) PLASTER.
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  LEVEL 4 FINISH ALL GWB SURFACES

### FLOOR PLAN NOTES

NO. NO

EXTG. VENTILATION OPENINGS IN CRAWL SPACE

FOUNDATION WALL, TYP. OF (3)
REMOVE EXTG. STONE MASONRY AS REQ'D TO PROVIDE NEW SECURE, INSULATED CRAWL SPACE ACCESS PANEL.
EXTG. SPLIT SYSTEM AHU TO REMAIN. RECONFIGURE EXTG. DUCTWORK AS REQ'D TO ACCOMODATE OVERHEAD CLEARANCE IN BASEMENT ROOM 1 AND 2
PROVIDE NEW OPENING IN EXTG. LOAD BEARING

MASONRY WALL
PROVIDE NEW 4" CONC. SLAB THROUGHOUT BASEMENT
PROVIDE NEW 8" DOUBLE WYTHE BRICK MASONRY
WALL ON 16" WIDE X 8" DEEP REINFOCED CONC.

MALL ON 16" WIDE X 8" DEEP REINFOCED CONC.
FOOTER AS INDICATED

MAINTAIN AS EMERGENCY EGRESS OPENING

NEW 90 MINUTE FIRE-RATED DOOR IN EXTG. OPENING

INFILL EXTG. WINDOW OPENING W/ MASONRY TO MATCH EXTG.
INFILL EXTG. DOOR OPENING W/ MASONRY TO MATCH

EXTG. GLASS GUARDRAIL, 42"

65 GALLON REFUSE / RECYCLING TOTES AND/OR LAWNCARE AND MAINTENANCE STORAGE CONCEALED

IN REFUSE ENCLOSURE
MAINTAIN AS EMERGENCY EGRESS OPENING

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PRELIMINARY

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# DATE REVISION

PROJECT TITLE

**80 E OLENTANGY**POWELL, OHIO 43065

PROJECT NO. SJM\_2010

ISSUE FINAL P&Z APPLICATION

ISSUE DATE 04.21.2021

EXTG. BASEMENT
+ NEW LEVEL 1
PLAN

SHEET NO.

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A1.02 1/4" = 1'-0"

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  8. EXTEND FIRE BARRIERS TO UNDERSIDE OF DECK ABOVE UNO.
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- 10. PROVIDE 5/8" CEMENT BACKER BOARD AT ALL TILE WALL LOCATIONS W/ BLOCKING BEHIND ALL CEMENT BACKER BOARD SEAMS.
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- FOUNDATION WALL, TYP. OF (3)
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PROJECT TITLE

**80 E OLENTANGY**POWELL, OHIO 43065

PROJECT NO. SJM\_2010

ISSUE FINAL P&Z APPLICATION

ISSUE DATE 04.21.2021

EXTG. LEVEL 1
PLAN

SHEET NO.

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  15. PROTECT EXISTING ORIGINAL ARCHITECTURE
  TUROUGUST INCLUDING WINDOWS DOORS MISC
- THROUGHOUT INCLUDING WINDOWS, DOORS, MISC.
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**80 E OLENTANGY**POWELL, OHIO 43065

PROJECT NO. SJM\_2010


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ISSUE DATE 04.21.2021

NEW
MEZZANINE
PLAN

SHEET NO.

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**80 E OLENTANGY**POWELL, OHIO 43065

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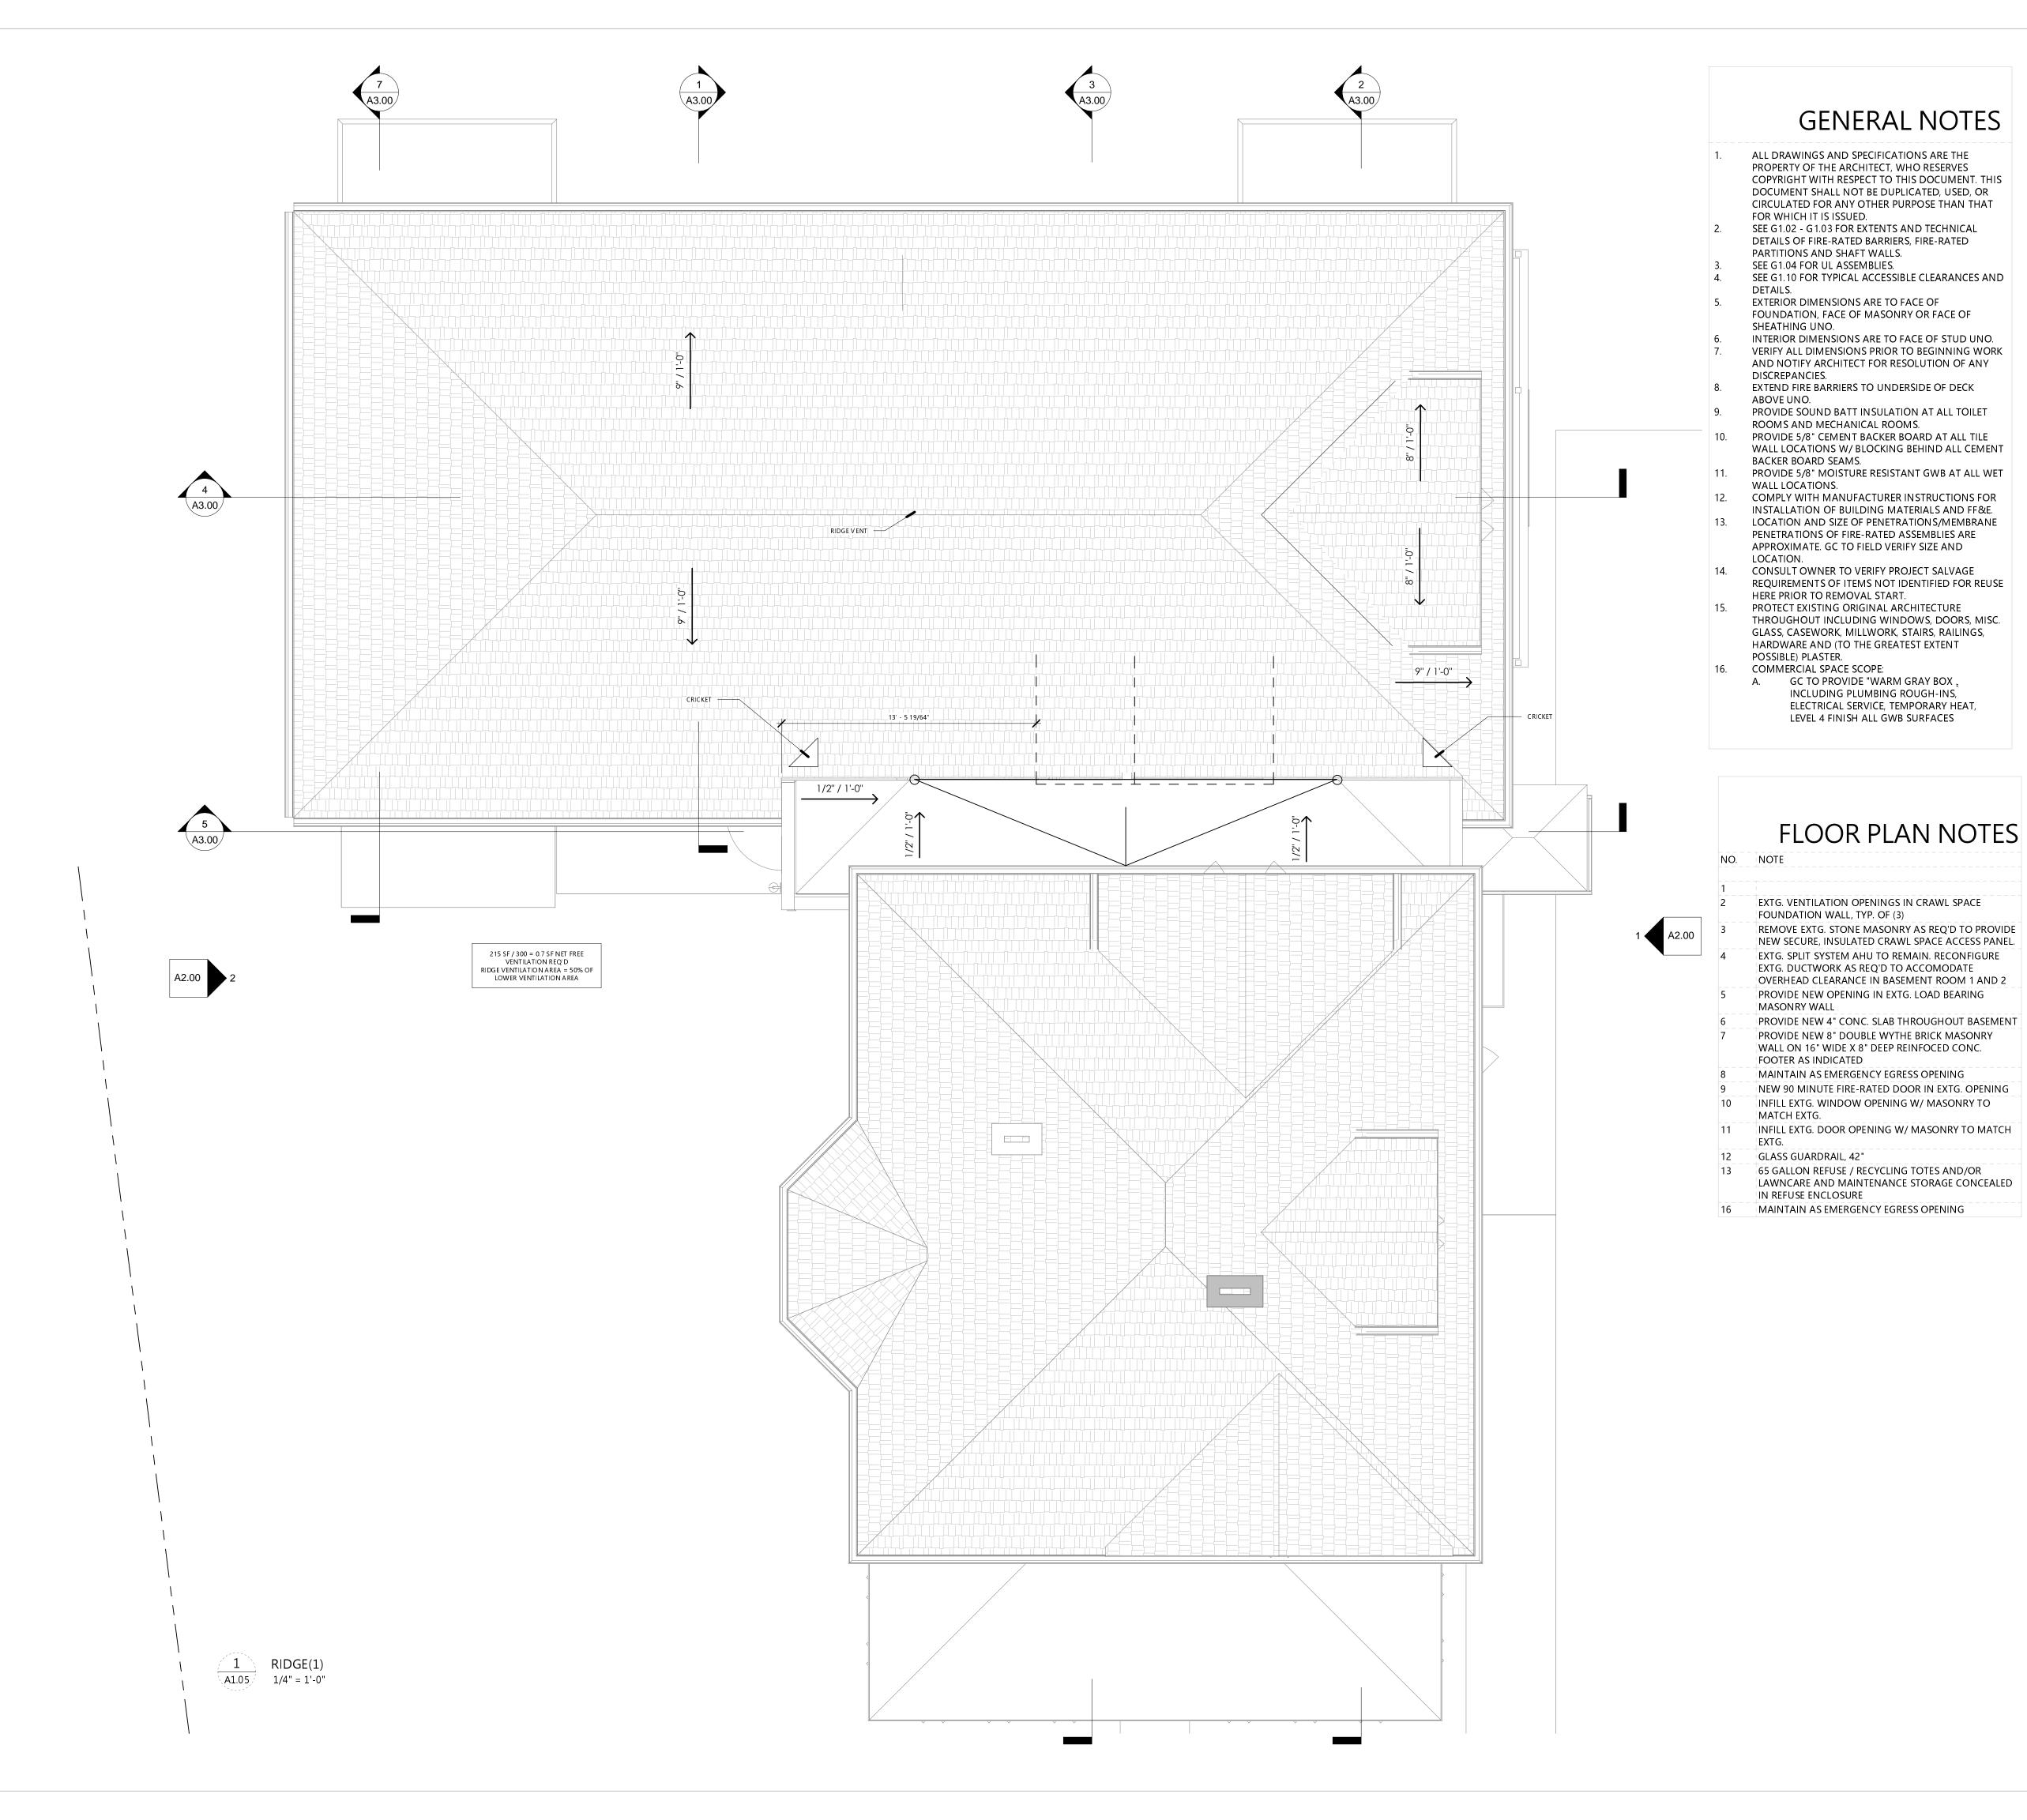
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SHEET TITLE

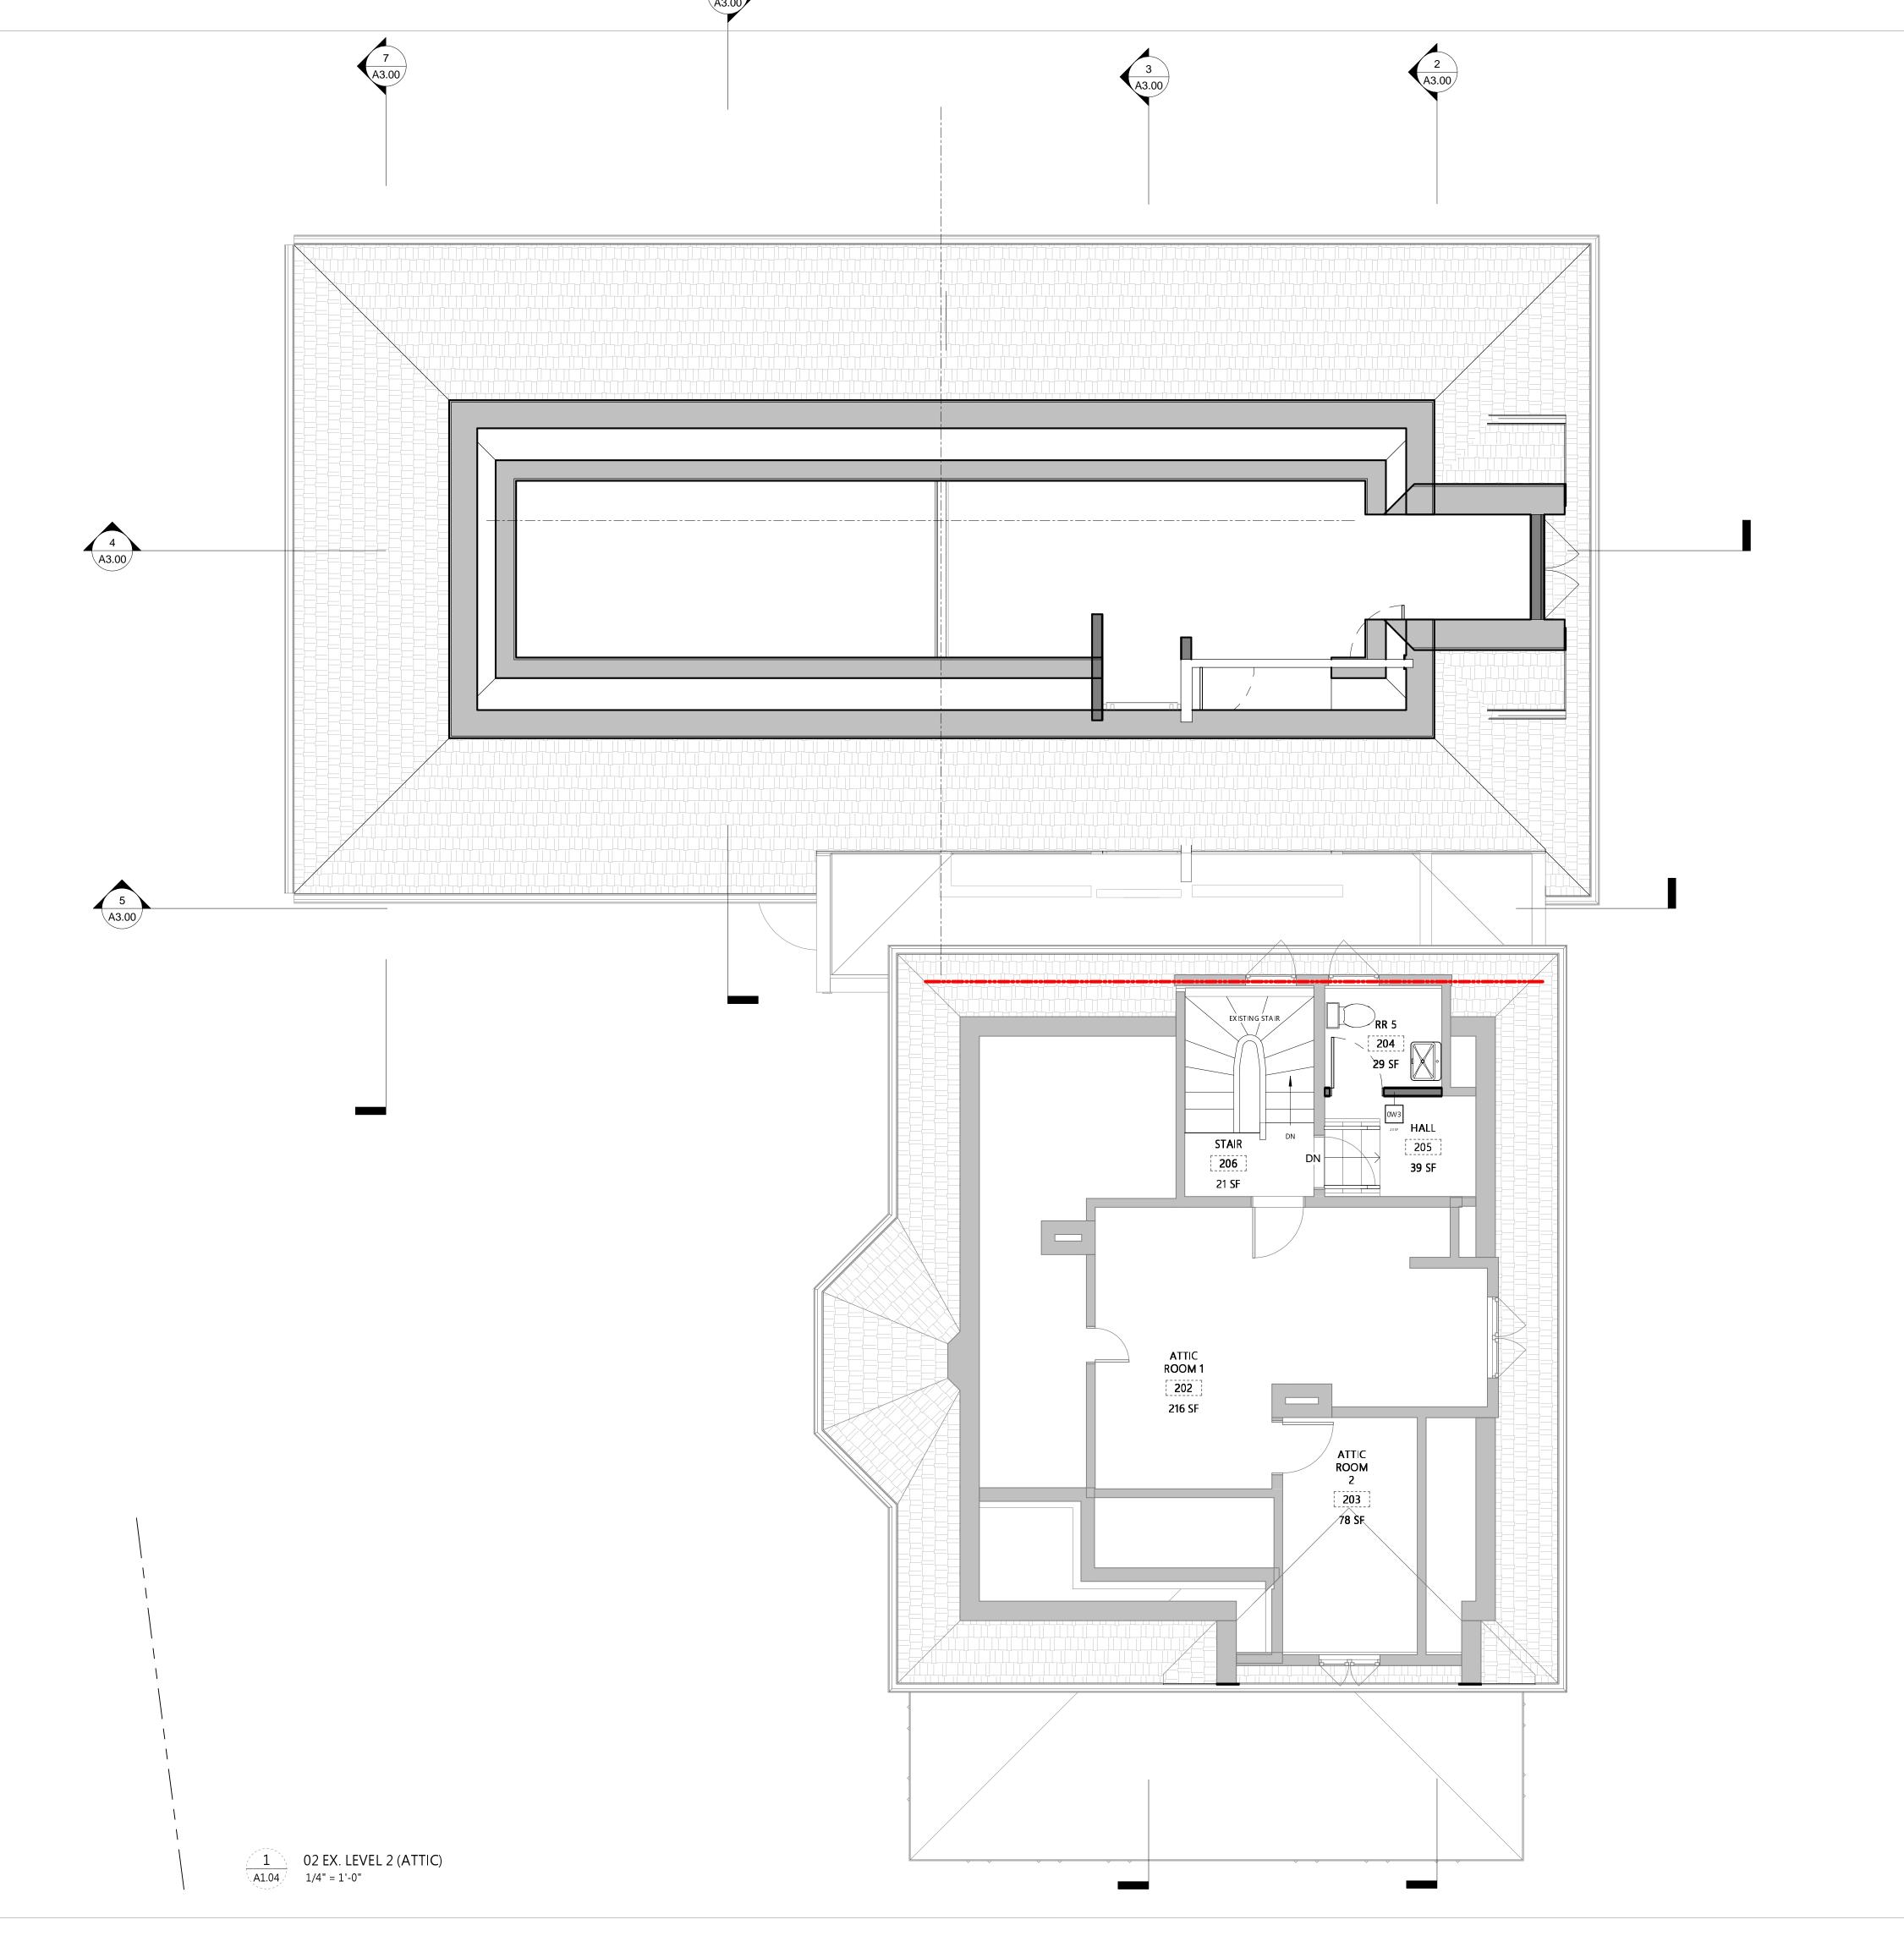EXTG. ATTIC

SHEET NO.

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Studio Columbus 1254 Eastwood Avenue, Columbus 1254 Eastwood Ea

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**80 E OLENTANGY**POWELL, OHIO 43065

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ROOF PLAN

A1 OF

**1.U** 5



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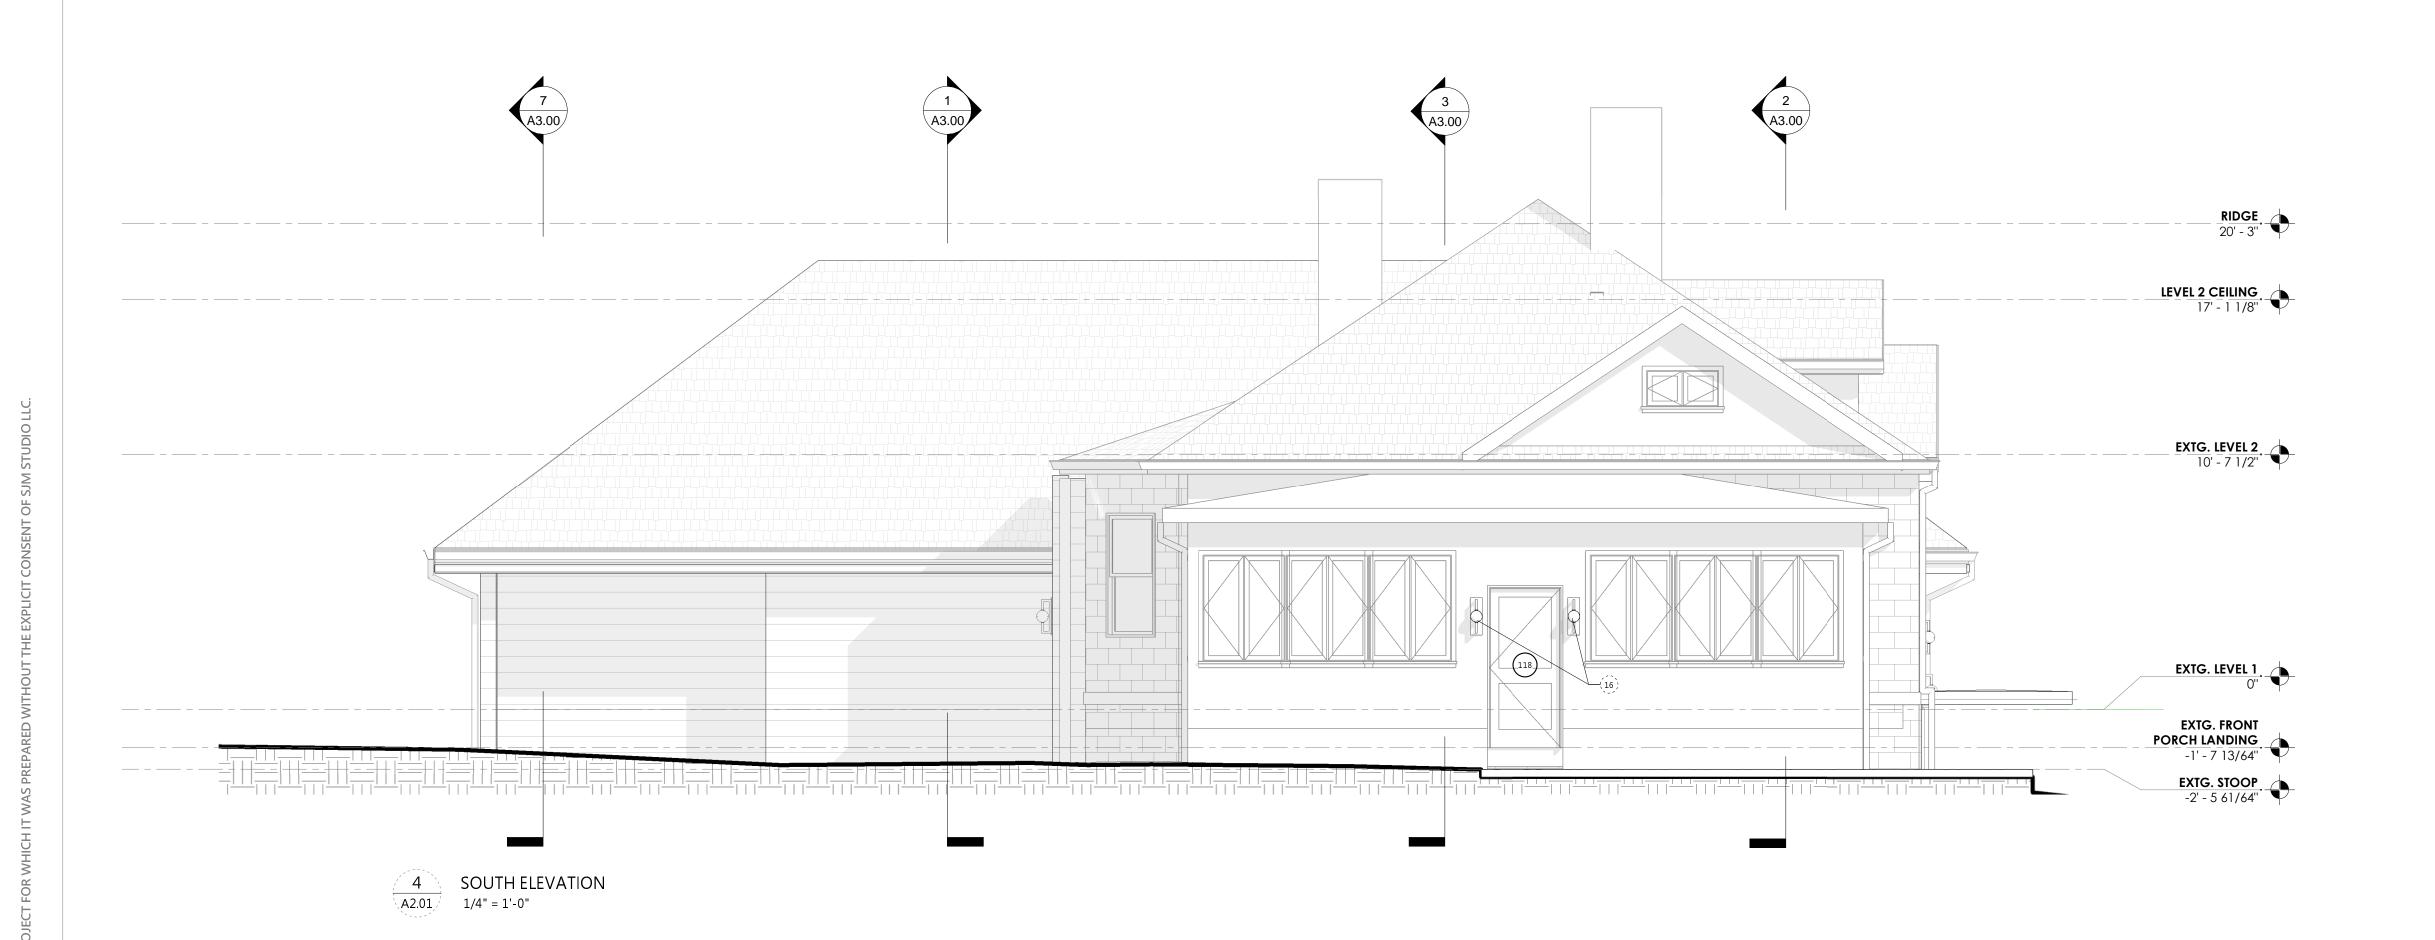
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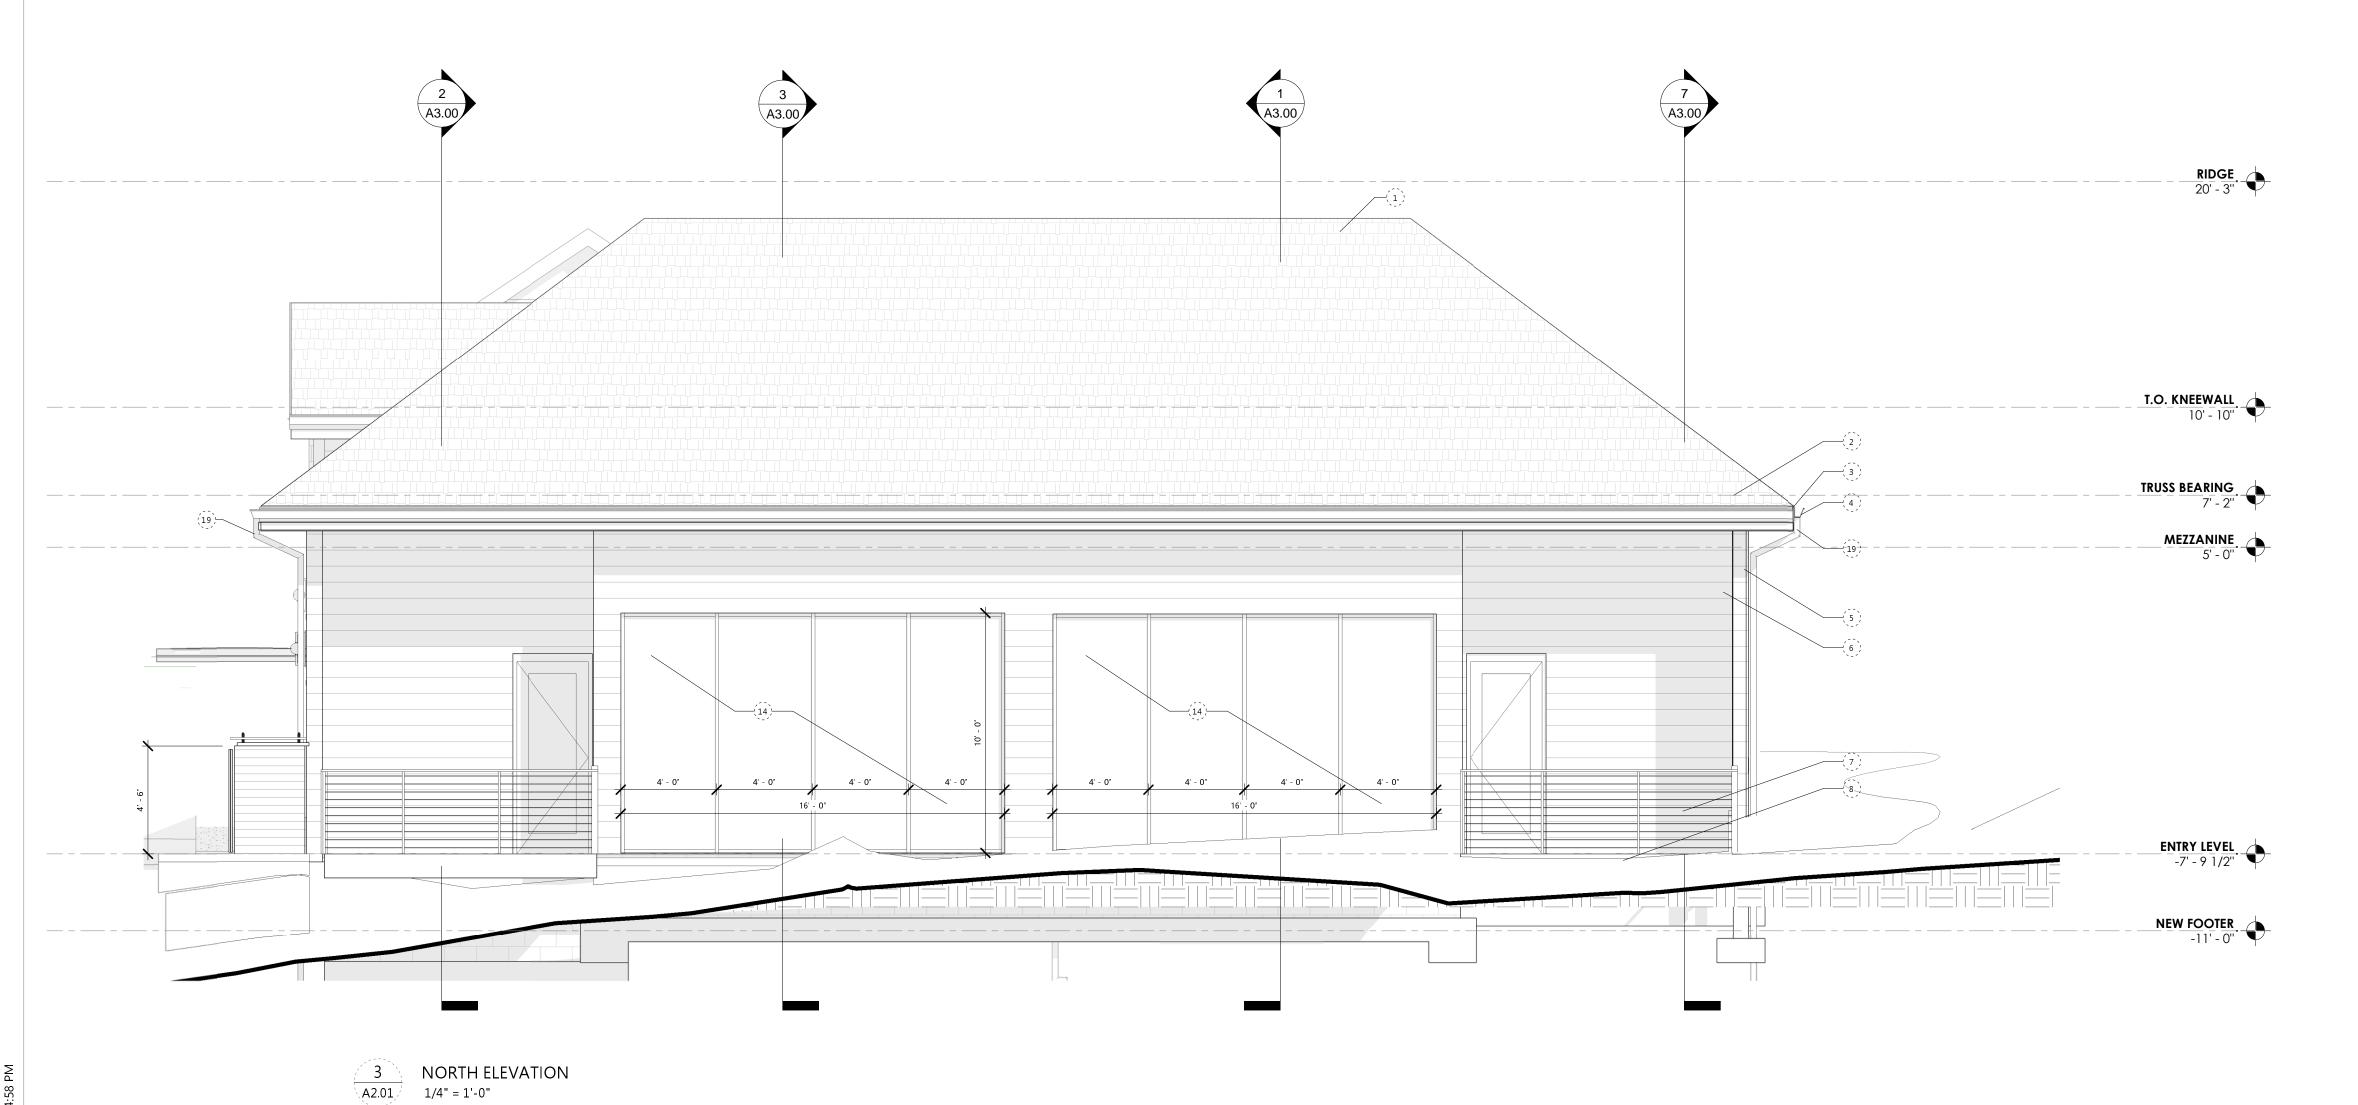
ISSUE FINAL P&Z APPLICATION

ISSUE DATE 04.21.2021

BUILDING ELEVATIONS

A2.00





# **ELEVATION NOTES**

NO. N

CONTINUOUS RIDGE VENT
DIMENSIONAL ASPHALT SHINGLE ROOF
FIBER CEMENT FASCIA
5" GUTTER
FIBER CEMENT TRIM
FIBER CEMENT CLAPBOARD SIDING 8"
CABLE RAIL
COMPOSITE DECKING AND SKIRT BOARD AT DECK PERIMETER
FIBER CEMENT CLAPBOARD SIDING 8"
DARK BRONZE ANODIZED PARAPET CAP

11 GARDEN ACCESS DOOR
12 REUSE ORIGINAL INTERIOR PORCH WINDOW IN EXTG. OPENING.
13 FIBER CEMEN REFUSE ENCLOSURE W/ GREEN ROOF AND BYPASS

SLIDING GATE OPENINGS

14 DARK BRONZE ANODIZED STOREFRONT

15 8" DEEP EXTRUDED SOLID METAL AWNING (ARCHITECTURAL LOUVERS H8CV OR SIM)

LOUVERS H8CV OR SIM)

16 FEATURE WALL SCONCE

ORIGINAL SINGLE PANE WOOD WINDOW TO REMAIN, TYP. @
 HOUSE U.N.O.
 NEW WINDOW IN EXTG. OPENING

19 NEW CHARCOAL GRAY GUTTER

PRELIMINARY

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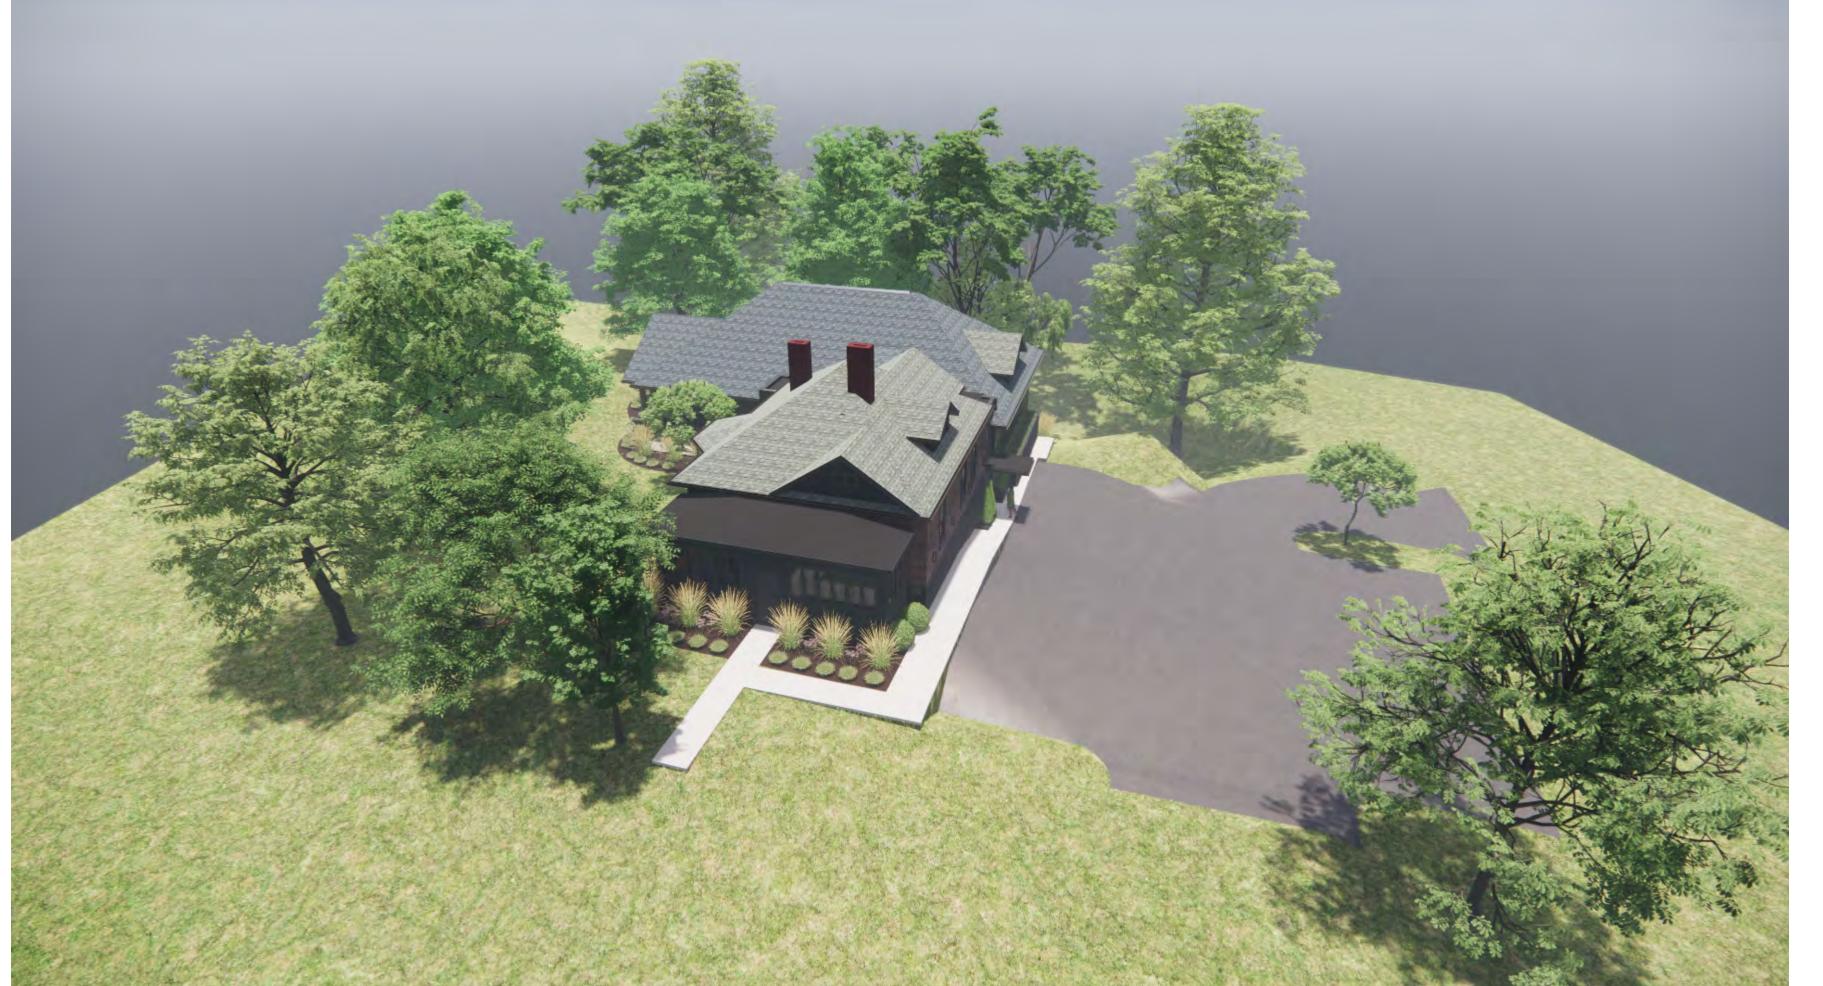
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A2.01









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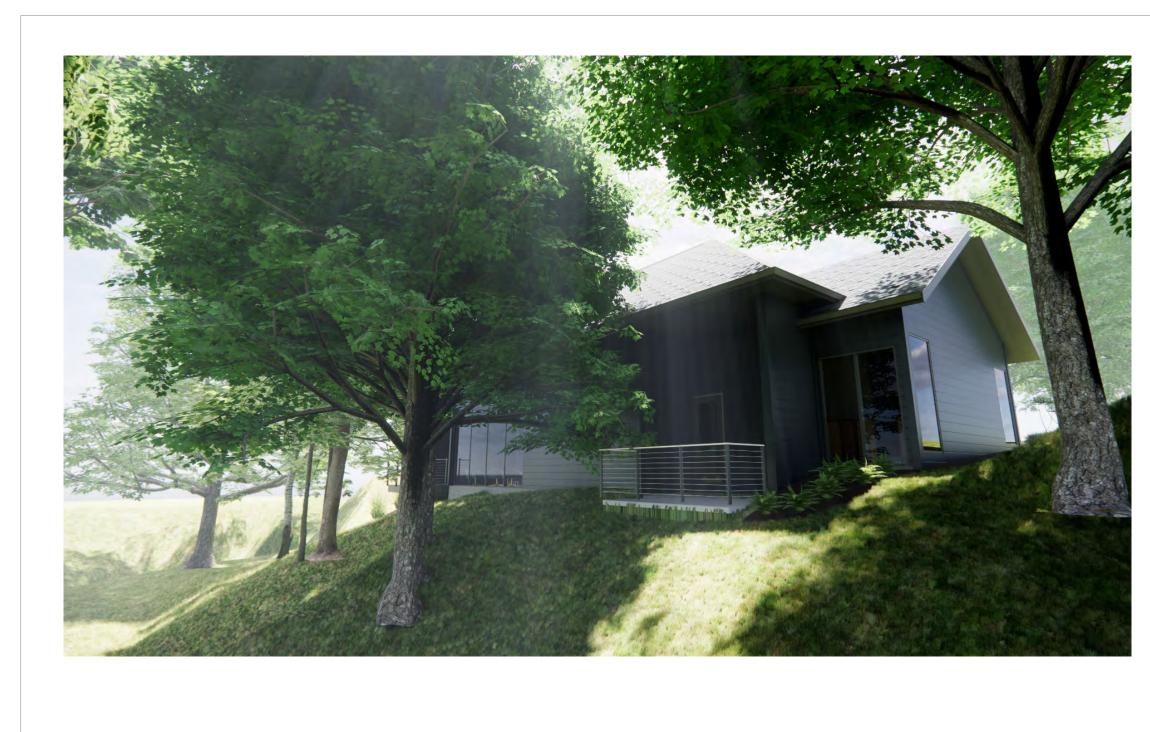
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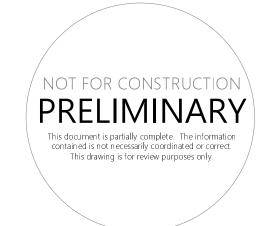
RENDERINGS

**A8.00** 









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RENDERINGS

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SHERWIN WILLIAMS

SHERWIN WILLIAMS

MOUNT ETNA

DIMENSIONAL ROOF SHINGLE

DARK NIGHT

# SHEET NO.

#### MATERIAL PALETTE EXTERIOR LIGHTING




FEATURE WALL SCONCE



MAIN ENTRANCE CHANDELIER




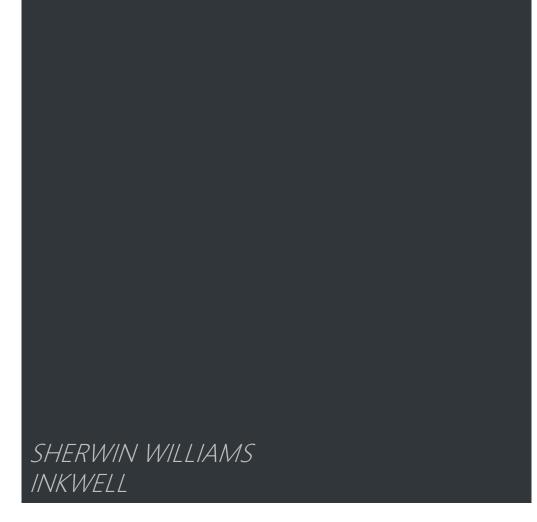








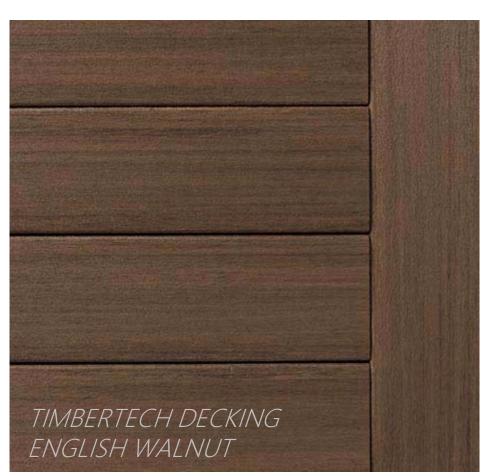






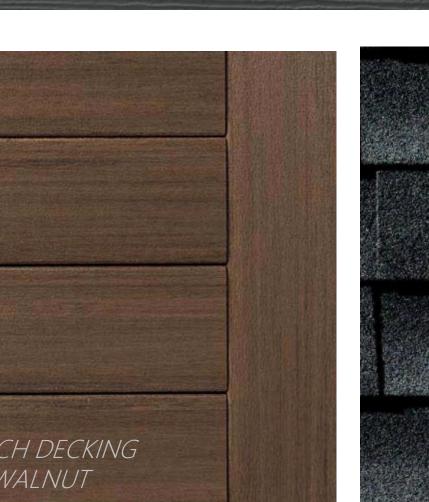

#### Setbacks

Most buildings in Powell are set back approximately 20 to 40 feet from the road with modest front lawns. The exceptions are the commercial buildings at the corner of Olentangy and Liberty Streets, which are built right up to their property lines at the sidewalks. Rear yards are generally long and narrow. Residential buildings on adjacent lots throughout the City are set approximately 20 feet apart from each other at their sides. New construction should follow the setback lines appropriate to its location and purpose.

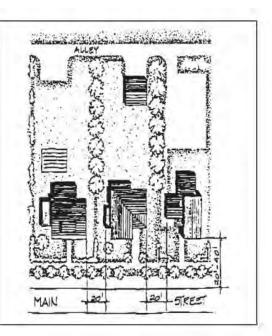


One of the charms of rural areas is the complete darkness of nightfall away from the 24 hour light of the city. However, proper lighting fixtures can increase the safety of Powell, and may become more necessary as development continues. Exterior lighting in the Historic District should be incandescent, and low in wattage. Entrance lights and individual free standing path lights are acceptable. Lighting fixtures should be simple Victorian or turn of the century in design, with round or egg-shaped globes on metal posts with minimal detailing. Colonial style "coach lights" are not appropriate in the Historic District. These types belong to an earlier historical period, and generally belong on coaches.

### Site Considerations


Free standing, pole mounted lamps may more detailed posts, All pole mounted lights should be individual, <u>Clusters of lights</u> are not acceptable in the Historic District.

Contemporary lights which incorporate simple, round or oval globes and modest posts or brackets may be appropriate in the Historic District. Frosted globes should be used in all lights in the Historic District, as they will provide softer light than clear

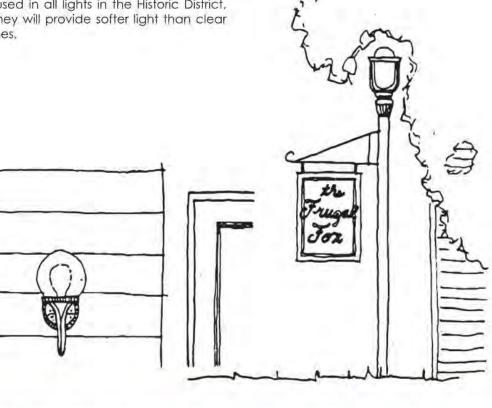

EXISTING LIGHT POST

be used to light paths or drives. These lights should not be taller than the height of the first story of adjacent buildings. Metal posts should be painted in dark, muted colors such as black, brown, or dark green. The more elaborate the shape of the globe, the simpler the detailing of the post should be. Simple globes can be mounted on

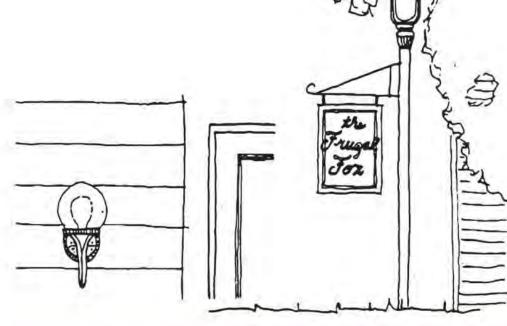

Site Considerations

1 SITE LIGHTING 1" = 10'-0"



TRAFFIC LIGHT POST



LIGHT POST



FEATURE WALL SCONCE A, F



SEE CIVIL SITE PLAN

PATH LIGHTING



EXISTING TRAFFIC SIGNAL LIGHT POST

FEATURE CHANDELIER IN VESTIBULE, D

# SITE LIGHTING

- A FEATURE WALL SCONCE
- B PATH LIGHTING
- C RECESSED EXTERIOR CAN LIGHT IN AWNING
- D FEATURE HANGING CHANDELIER
- RECESS EXTERIOR CAN LIGHTS IN DECK OVERHANGS
- F FEATURE WALL SCONCE

/ not for construction  $^{\circ}$ **PRELIMINARY** This document is partially complete. The information contained is not necessarily coordinated or correct.

This drawing is for review purposes only.

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# DATE REVISION

PROJECT TITLE

80 E **OLENTANGY** POWELL, OHIO 43065

PROJECT NO. SJM\_2010 ISSUE FINAL P&Z APPLICATION ISSUE DATE 04.21.2021

SHEET TITLE SITE LIGHTING

SHEET NO.

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# DATE REVISION

PROJECT NO. SJM\_2010 ISSUE FINAL P&Z APPLICATION 04.09.2021 ISSUE DATE SHEET TITLE

> **EXISTING IMAGES**

SHEET NO.





















Final Development Plan Application Details

Prepared by Applicant: Gretchen Bonasera, member Good Night Investments, LLC Location: 80 E Olentangy St (intersection of Olentangy and Grace Drive)

Zoning: Downtown Business District

Gretchen Bonasera is proposing to renovate and expand the current building, converting the existing home to a private social club featuring rare bourbons, fine wines, and chef inspired cocktails with just enough small plates of food served to imbibe responsibly. We anticipate our club to be used as a place to gather for business or social, and to be a great place to come before or after dinner plans at one of the great local restaurants Powell has to offer.

The purpose of this document is to address comments from previous meetings and/or staff reports from the City of Powell Planning Staff, the Historic Downtown Advisory Commission and Liberty Township Fire Dept...

#### • Site Considerations:

**Staff Comment:** The access drive is proposed in the least obtrusive location, as it is as far from the Grace Dr/E Olentangy St intersection as possible while maintaining the flood plain from Bartholomew Run. However, staff is concerned that the 24' wide access drive is wider than necessary and requests the applicant work with Staff as well as the Liberty Township Fire Department to decrease the size of the drive, if possible.

<u>Our Design:</u> Following conversation(s) with the City Engineer, Chrus Huber, the current site plan represents a "pork chop" installed within the proposed driveway entrance per his recommendation. The "pork chop" will prohibit left turn in and out of the site. The Fire Department has requested access accommodations, thus the proposed curb would be a mountable style. Additionally, signage indicating "No Left Turn" will need to be provided. As a result of these changes, the driveway has been widened beyond the 22' desired width to accommodate turning maneuverability while still maintaining the smallest drive width possible due to site constraints.

**HDAC Comment:** Brad Coomes asked about where the white fence would be removed. **Our Design:** We will leave as much of the white fence as possible.

<u>Liberty Township Fire Department Comment:</u> Can the proposed concrete island at the drive entrance be removed or constructed with a mountable or soft curb to provide easier access for our ladder truck in the event of an emergency.

<u>Our Design:</u> We would propose a mountable curb solution if the "pork chop" curb is required by the City Engineer and planning staff.

• Parking (PAG, pg. 10)

Staff Comment: Parking in the rear yard is not an option, as this property is a corner lot with a

stream running through the rear. The number of parking spaces proposed is reasonable, as the Zoning Code calls for one parking space per 10 members, and the applicant has expressed that private parking agreements will be created to cover any additional spaces that may be needed. Staff supports the consideration for pervious pavement on this site, which would alleviate stormwater runoff, even though pervious technologies are not called out in the PAG.

<u>Our Design:</u> The parking plan was taken almost directly from the previously approved project for this site. The current design is asphalt, but we are looking into if pervious pavers would fit in the budget.

We have 12 vehicular parking spaces and 1 motorcycle space planned for in our lot and have tentative agreements with both the Historical society across the street and The Powell Center regarding leases for additional parking spaces during business hours to meet the requirement for one space available per ten members of the private social club. It is too early to lock in these leases until we have approval from the city to proceed with the project.

**HDAC Comment:** Concern with getting in and out of Grace drive.

<u>Our Design:</u> We are following the same parking lot design as was previously approved and have worked with the City Engineer to come up with the current plan. The new drive entrance is located as far north on the site as is technically feasible and will allow room for (3) cars to be waiting at the light without blocking the drive.

#### • Sidewalks (PAG, pg. 11)

"Some type of contemporary, all weather path must be provided to allow for increased pedestrian traffic along Olentangy Street and at the Center of the City. Sidewalks should be provided along Olentangy Street from Martin Perry house on the east to the railroad tracks on the west."

<u>Staff Comment:</u> Sidewalks exist on this property along the Olentangy St frontage, and connect to the Grace Drive intersection.

**HDAC Comment:** Tom Coffey does not want the front steps removed.

**Our Design:** Our plans are to keep the front steps intact.

#### • Lighting (PAG, pg. 13)

**Staff Comment:** Additional exterior lighting will help to create a safer environment for customers and employees. The freestanding path lighting meets the architectural guidelines, but the wall sconces are more modern than the guidelines suggest.

<u>Our Design:</u> As represented in the photometric study, and based on the lighting specifications provided for the two existing light posts, parking lot lighting is sufficient and ideal with only the addition of the architectural wall sconces.

The opaque white globes have been chosen to represent the Art Nouveau era consistent with the time period and are in keeping with the Architectural Guidelines, "Contemporary lights which incorporate simple, round or oval globes and modest posts or brackets may be appropriate in the Historic District. Frosted globes should be used in all lights in the Historic District..".

#### • Signage and Graphics (PAG, pg. 15)

**Proposed Signage:** The applicant is proposing no signage.

• Building Materials: Siding (PAG, pg. 27)

**Proposed siding:** 8" fiber cement clapboard siding is proposed for the new addition. The glazed block wall on the existing home will remain.

<u>Staff Comment:</u> Fiber cement board is not addressed in the building materials portion of the PAG. Natural materials are preferred per the PAG.

<u>Our Design:</u> The fiber cement board is a much superior product compared to natural materials and did not yet exist as a viable option when the PAG was last updated. The width of the siding of the new building was intentionally chosen to match the width of the existing glazed block of the historic building to continue those lines.

**HDAC Comments:** Tom Coffey requested that we do our best to save the brick of the foundation of the back porch.

<u>Our Design:</u> The back porch foundation is sliding to the North which has compromised the porch as a whole. Thankfully the porch was added on a couple years after the original house was built, and we are confident it can be removed without damaging the original brick of the house. The glazed brick on the North wall of the house will be maintained and will be visible inside of the structure.

**HDAC Comments:** Tom Coffey wanted to make note that he liked the look of the trash enclosure.

Asphalt Singles (PAG, pg. 34)

**<u>Proposed roofing:</u>** Dark gray/black dimensional roof shingle.

**Staff Comment:** From the submission, it is not clear whether the proposed dimensional roof shingles on the new addition will match the existing home. Page 3 of 5

<u>Our design:</u> The existing shingles on the house do not yet need replaced. In the near future, when we replace them, they will be replaced to match the same gray shingles on the addition. The new gray color of the shingles will go well with the historic glazed block that we are featuring in the design.

• Massing: Roofs (PAG, pg. 42)

<u>Proposed Roof:</u> Gable roof with dormers. Please see the roof plan included in the submitted materials.

**Staff Comment:** The gabled roof is appropriate for the Historic District, however, as the Architectural Advisor notes below, the roof plan is complex. Staff requests the Commission provide comments on whether the roof forms should be simplified.

<u>Architectural Advisors Comments:</u> The interaction of the "atrium/connector" could be improved where the hip roof cuts into the glazing. The connector could be recessed and the solid "crown" increased so that the bottom lines up with the soffit of the new structure. The roof plan looks very complex, there are some concerns with how the valleys and roof penetrations are flashed and treated.

<u>HDAC commented</u> on working with the architectural advisor to simplify the roof lines of the connector between the two buildings.

Our design: We coordinated directly with the architectural advisor to address these comments

and they have been incorporated into the current plan: specifically to lower the height of the upper glass window to align with the bottom of the new soffit. Additionally, design and framing details have been revised to eliminate the west wing and gable and the south dormer, thus simplifying the roof.

• Additions (PAG, pg. 44).

"Contemporary design is encouraged as long as it is in harmony with the character of the Historic District. This will continue the tradition of growth and change in Powell, without completely altering the essential character of the City."

"The addition should be smaller and shorter than the main portion of the building. The roof line of an addition should not appear as a continuation of the main form or roof, nor should it mimic, or "complete" existing forms or roof lines."

**Staff Comment:** The proposed addition has a larger footprint than the existing home, however, the ridge of the existing roof and new addition are similar in height, about 20'- 3".

<u>Architectural Advisor Comments:</u> The differentiation between the existing and new structure is appreciated.

Our Design: No comment.

#### Architectural Elements:

• Windows (PAG, pg. 47)

<u>Proposed Windows:</u> A variety of windows are proposed, please refer to the elevation drawings. <u>Staff Comment:</u> Staff requests additional detail for the windows, as they appear to lack consistency with the architectural guidelines, or match the window proportions or style of the existing home.

<u>Additional HDAC comment:</u> Tom Coffey wanted us to continue the grid lines of the front windows to the rest of the house.

<u>Our Design:</u> All of the existing historic windows in the home will stay intact; the only house window that was compromised mid-century was the center window on the east side of the home that was removed and bricked up. It will be restored with one of the original windows from the interior of the home (the interior window is the exact same material, style and size as the other original exterior windows). The existing window replacements currently located on the front of the front porch are simulated divided lite pattern of 4 tall x 3 wide in one fixed panel, as opposed to the original pattern existing on the east and west side of the front porch of 4 tall x 2 wide x 2 casement panels. All of these windows will also be restored and remain in their current condition.

The windows in the addition do not mimic the double hung sash style of the residential structure due to various criteria including the interior floor plan and floor to floor height. However, their style does tie into the square window panes of the casement windows in the dormers of the house.

**HDAC Comment:** Brad Croomes asked if the windows on the transition piece of the addition would be tinted. Tom Coffey also asserted that the windows should not be tinted. **Our Design:** The glazing in the addition will be clear float glass, Vitro Solarban 60 Low-E or similar.

• Doors (PAG, pg. 57)

**Proposed Doors:** Please refer to the elevation drawings.

**<u>Staff Comment:</u>** The applicant has not provided sufficient information for Staff to determine whether the proposed doors meet the Historic District guidelines.

<u>Our Design:</u> The front door to the home will restored and remain in place. The existing white storm door will be removed and, ideally, replaced to protect the 6 panel solid wood door. The new storm door will be narrow frame charcoal gray or black finish with clear glass. The design intent for the east entry door leading to the addition is an architecturally significant reclaimed historic wood door with ¾ glass. As such, final details and/or cut sheets are not currently available.

<u>HDAC Comment:</u> Brad Croomes and Tom Coffey should concern that the side door itself not be aluminum storefront glazing.

Our Design: The door will not be a storefront door.

• Gutters and Downspouts (PAG, pg. 68)

"Aluminum downspouts may be used for replacement or new construction. In general, downspouts should be painted to match the base wall color of the building." Proposed Gutters and Downspouts: 5" gutter, downspouts are not detailed on the drawing set.

**Staff Comment:** The applicant has not provided sufficient information to determine where the gutters and downspouts are located. The color and material of the gutters and downspouts are not included in the submission. The gutters and downspouts should be located as unobtrusively as possible, and should match those of the existing home.

**HDAC comment:** Tom Coffey requested half round gutters.

<u>Our Design:</u> We will follow the staff comment citing PAG p.68. As to placement, the downspouts have been added to building elevations for reference.

• Painting and Colors (PAG, pg. 70)

**Staff Comment:** Color samples are included in the submission; however, more clarification is needed where each color is applied.

**HDAC Comments:** Erin Wesson commenting on liking the plan, especially the paint colors. **Our Design:** Proposed colors are dark colors intended to really let the historic glazed block be showcased (the glazed block will not be painted). Colors include: Sherwin Williams Dark Night, Sherwin Williams Mount Etna, and Sherwin Williams Inkwell. We plan to use the darkest color presented to anchor the foundation of the existing building and cover the lower quality utilitarian foundation block that has sustained damage over the years. This will help feature the beautiful glazed block that is the main floor of the existing building. The slightly lighter dark gray will cover the bulk of the addition with the darker gray anchoring the trash enclosure. The slightly green/bluish gray will accent the door and other features. Additional subtle gold accents will be incorporated to the front of the house in the groves of the square pillars of the front porch to draw attention to that beautiful design feature.

Station 321 Administrative Offices 7761 Liberty Road Powell, Ohio 43065 (740) 938-2021 (740) 938-2031 Fax

# Liberty Township

#### Fire Department

Thomas J. O'Brien, EFO/CFO/MBA/MIFireE Fire Chief Station 322 Fire Prevention Bureau 10150 Sawmill Parkway Powell, Ohio 43065 (740) 938-2022 (740) 938-2032 Fax

04/23/2021

Ms. Gretchen Bonasera 4200 Macduff Way Dublin Ohio, 43016

Regarding: Serviceability request for The Venery: 80 E. Olentangy St. located in Powell / Liberty Township, Delaware County

Ms. Bonasera,

There is adequate water supply and The Liberty Township Fire Department can provide fire service to the following parcel in Powell / Liberty Township, Delaware County Ohio; this parcel is within 1.6 miles of the Liberty Township Fire station that is located at 10150 Sawmill Parkway Powell, Ohio 43065.

Delaware County Parcel # 319-425-13-051-002


If you should have any questions please contact me.

In the interest of public safety, of

Thomas J. O'Brien, EFO/CFO/MBA/MIFir Fire Chief

Liberty Township Fire Department #21-117

Cc: Lt. Tom Saunders

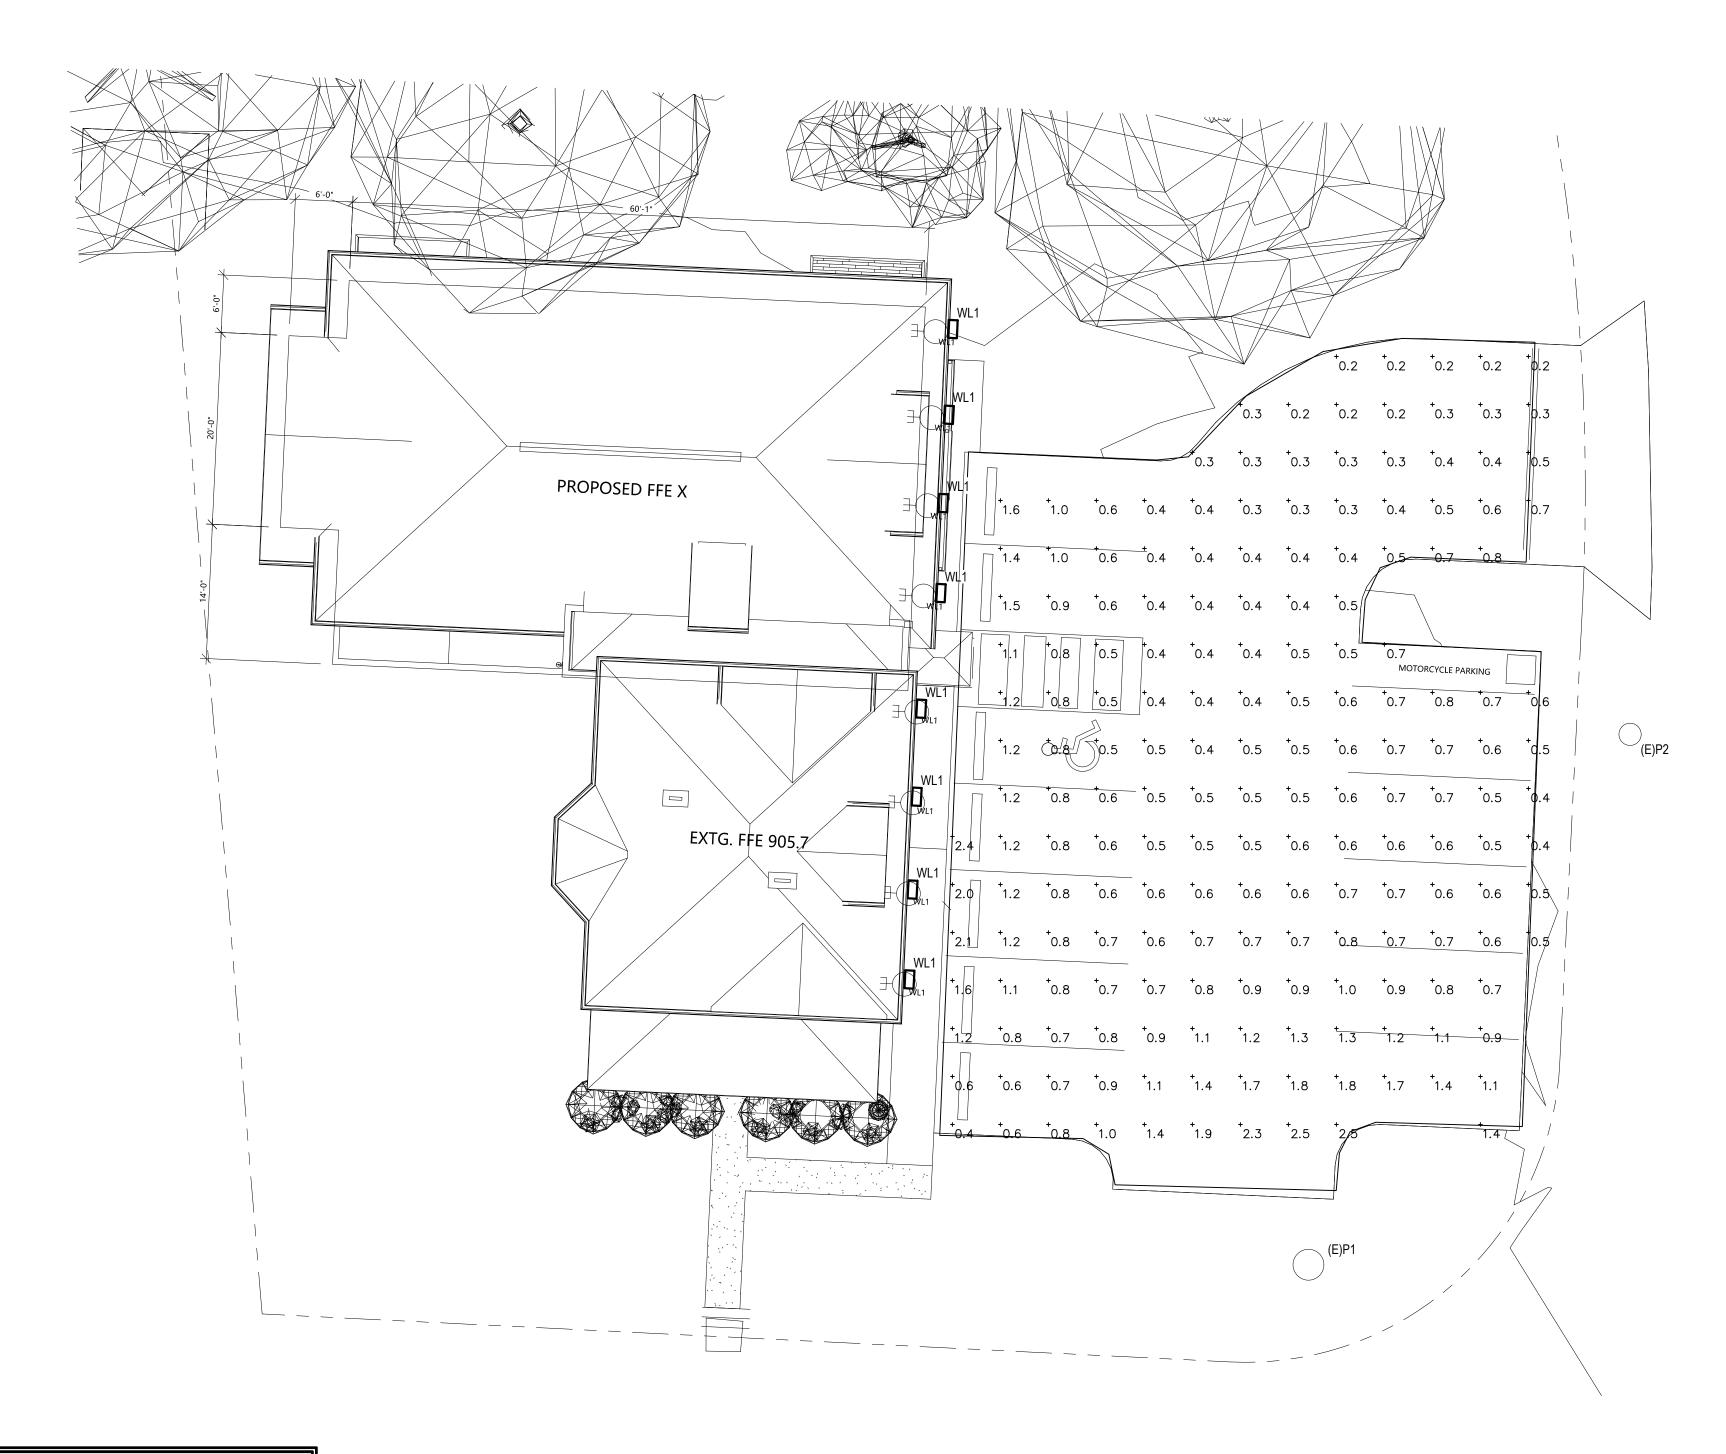

Statistics						
Description	Symbol	Avg	Max	Min	Max/Min	Avg/Min
PARKING LOT	+	0.8 fc	2.5 fc	0.2 fc	12.5:1	4.0:1

	LIGHTING FIXTURE SCHEDULE						
MARK	DESCRIPTION	VOLT	LAMP	MOUNT	MANUFACTURER		
(E) P1	POLE MOUNTED OUTDOOR PENDANT WITH LED BULB (OWNED BY CITY OF POWELL)	EXIST.	EXIST. 60W LED BULB, 7600 LUM (APPROX.)	MOUNTED TO EXISTING POLE 16' (APPROX.)	EXISTING TO REMAIN		
(E) P2	POST TOP LANTERN WITH LED BULB (OWNED BY CITY OF POWELL)	EXIST.	EXIST. 60W LED BULB, 7600 LUM (APPROX.)	MOUNTED TO EXISTING POLE 14' (APPROX.)	EXISTING TO REMAIN		
WL1	EXTERIOR WALL PACK	120	60 W INC. 800 LUM (APPROX.) 4000 K	WALL MOUNT @8'-0" A.F.F.	SHADES OF LIGHT #OL20023		



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<u></u>				mbus, Ohio 43231	

80 E. OLENTANGY STREE POWELL, OHIO 43065 SITE PHOTOMETRIC PLAN

PROJECT NO. TBD CHECKED BY: VWE AS NOTED 04-09-2021

Sheet No.

Stores

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CHANDELIERS LIGHTS FANS LIGHTS SHA	RUGS INSPIRATION
------------------------------------	------------------

Home / OUTDOOR LIGHTS / All Outdoor Lights / Veritas Outdoor Wall Light - Sall



















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#### Description

Adorn your outdoors with a piece from our Veritas Collection. Offered in a range of sizes, these mid-century fixtures are structured with textured black hardware and center globe shade. Stylish and functional, these glowing components will make your home stand-out on the block.

- Actual Size: 18.75"Hx6"Wx8"D
- Backplate/Canopy Size: 18.75"Hx5"W Rectangular
- Bulb Base: US Candelabra-E12
- Bulb Included: No
- Color: Black / Opal Glass

- Indoor-Outdoor: Yes
- **Limited Warranty:** 1 Year
- Material: Aluminum, Glass
- Max Bulb Wattage: 60
- **Number of Lights: 1**
- Safety Rating: Wet

California Residents See PROP 65 WARNINGS 🔻



**4 0** / 5 • **1** reviews

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VERITAS OUTDOOR WALL LIGHT -**MEDIUM** 

\$218.00

**VERITAS OUTDOOR** WALL LIGHT -LARGE \$338.00

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Δ	OUR STORT

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