

HISTORIC DOWNTOWN ADVISORY COMMISSION (HDAC) CERTIFICATE OF APPROPRIATENESS APPLICATION

ALL ITEMS ON THIS APPLICATION MUST BE COMPLETED.

Per Fee Ordinance 2019-49

Applicant:			
Address/City/State/Zip:			
Email Address:			
		Fax No:	
Property Owner:			
Address/City/State/Zip:			
Phone No:	Cell Phone No:	Fax No:	
Architect/Designer for Applicant:			
Address/City/State/Zip:			
		Fax No:	
Property Address:			
Lot Number/Subdivision:			
Proposed type of Environmental Chan	ge:		

Checklist:

- Attach 5 copies of plot plan as well as any other drawings or written material that will help the Administration and Commission understand the nature of the proposal.
- □ 1 digital copy (CD, USB, Email) of the complete application packet.
- □ Attach a list of contiguous property owners as well as directly across the street from and within 250 feet of property
- □ Attach the required fee \$150.00 per unit (New Residential Construction)
- □ Attach the required fee \$50.00 (Residential Additions/Remodeling)
- □ Attach the required fee \$250.00 per unit (New Commercial Construction)
- □ Attach the required fee \$100.00 (Commercial Additions/Remodeling)
- □ Attach the required fee \$50.00 (Commercial Signs)
- □ Attach the required fee \$100.00 (Demolition Review)

 \Box Post a public notice sign at least (10) days prior to a public hearing or public meeting, pursuant to ordinance 1107.035

Public notice sign details found here.

(See Over)

I agree to grant the City Staff, the Commission, Board or Council considering this application access to the property that is the subject of this application for the purposes of reviewing this application and posting public notice for this application.

ature of Applicant: Satah Market	Date:
Office Use	Office Use
	Type/Date:
	Prepared by:
	Reviewed by:
Received	PAYOR:
	RECIEPT #

City of Powell · 47 Hall Street · Powell, Ohio 43065 · (614) 885-5380 · (614) 885-5339 fax · www.cityofpowell.us

ABREVIATIONS

@ = AT AB = ANCHOR BOLT A/C = AIR CONDITIONING ADJ = ADJACENT AFF = ABOVE FINISHED FLOOR AFS = ABOVE FINISHED SLAB ALS = ACRYLIC LATEX SEALANT ALUM = ALUMINUM ANOD = ANODIZED ARA = AREA OF RESCUE ASSISTANCE AP = ACCESS PANEL APPROX = APPROXIMATELY ARCH = ARCHITECTAS = ACOUSTICAL SEALANT B/ = BOTTOM OF B/B = BACK TO BACK BD = BOARDBFG = BELOW FINISHED GRADE BLDG = BUILDING BLK = BLOCK (BLOCKING) BM = BEAM BMT = BUTYL MASTIC TAPE SEALANT BRK = BRICKBRS = BUTYL RUBBER SEALANT BRZ = BRONZEBSMT = BASEMENT BTW = BETWEENBYD = BEYONDC/C = CENTER TO CENTER CIP = CAST-IN-PLACE CEM = CEMENTCER = CERAMICCFL = COUNTERFLASH (ING) CJ = CONTROL JOINT CL = CENTER LINE CLG = CEILINGCLO = CLOSETCLR = CLEAR OPENING CMU = CONCRETE MASONRY UNIT CO = CLEAN OUT COL = COLUMNCONC = CONCRETE CONST = CONSTRUCTION CONTR - CONTRACTOR CONT = CONTINUOUS COOR = COORDINATE CORR = CORRIDOR CPT = CARPETCT = CERAMIC TILECTSK = COUNTERSINK CTR = CENTERCU = CUBICDB = DIRECT BURIAL DBL = DOUBLE DD = DECK DRAIN DIA = DIAMETER DIFF = DIFFUSER DIM = DIMENSION DIR = DIRECTION DN = DOWN DR = DOOR DS = DOWN SPOUT DTL = DETAIL DW = DRY WALL DWG(S) = DRAWING(S)EA = EACHEB = EXPANSION BOLT EC = EXPOSED CONSTRUCTION EF = EXHAUST FAN EJ = EXPANSION JOINT EL = ELEVATOR ELEC = ELECTRICELEV = ELEVATION EOS = EDGE OF SLAB EQ = EQUAL EQUIP = EQUIPMENTEXIST G = EXISTING EXT = EXTERIOR F = FEMALEFA = FIRE ALARM FB = FACE BRICKF/C = FAN COILFD = FLOOR DRAIN FE = FIRE EXTINGUISHER FEC = FIRE EXTINGUISHER CABINET FF = FINISHED FLOOR FIN = FINISH (ED)FIXT = FIXTURE

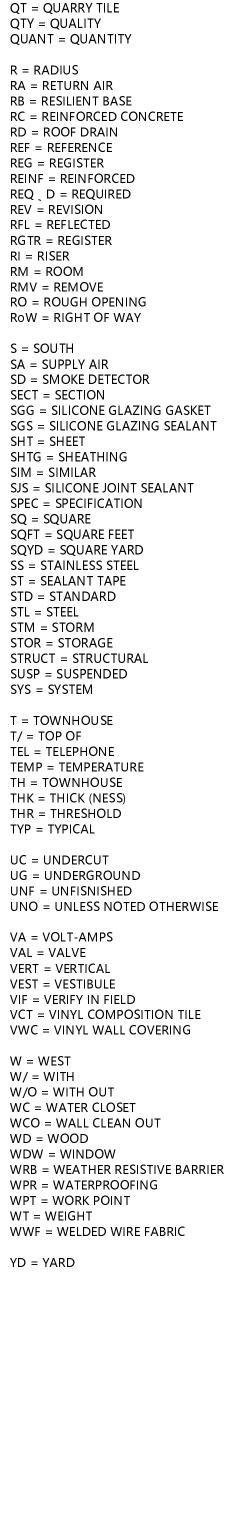
J = JOIST JAN = JANITOR JB = JUNCTION BOX JT = JOINT KIT = KITCHENKP = KICK PLATEL = LENGTHLAV = LAVATORY LB = POUND LBL = LABELLH = LEFT HAND LIN = LINEAR LNFT = LINEAR FEET LP = LOW POINT LVR = LOUVER M = MALEMACH = MACHINE MAR = MARBLE MAS = MASONRY MATL = MATERIAL MAX = MAXIMUM MEZZ = MEZZANINE MGR = MANAGER MH = MAN HOLE MIN = MINIMUMMIR = MIRROR MP = METAL PANEL MTD = MOUNTED MTG = MEETING MTL = METAL N = NORTH NAT = NATURAL NO = NUMBER NOM = NOMINAL FACP = FIRE ALARM CONTROL PANEL O.R.C. = OHIO RESIDENTIAL CODE OA = OVERALLOC = ON CENTER O/O = OUT TO OUTOPNG = OPENING OPP = OPPOSITE OZ = OUNCE PARTN = PARTITION FOC = FACE OF CONCRETE PERF = PERFORATED FSD = FIRE SEPARATION DISTANCE PH = PHASEFRT = FIRE RETARDANT TREATED PL = PLATEPR = PAIRP.T. = PRESSURE TREATED PT = PAINTPTD = PAINTED

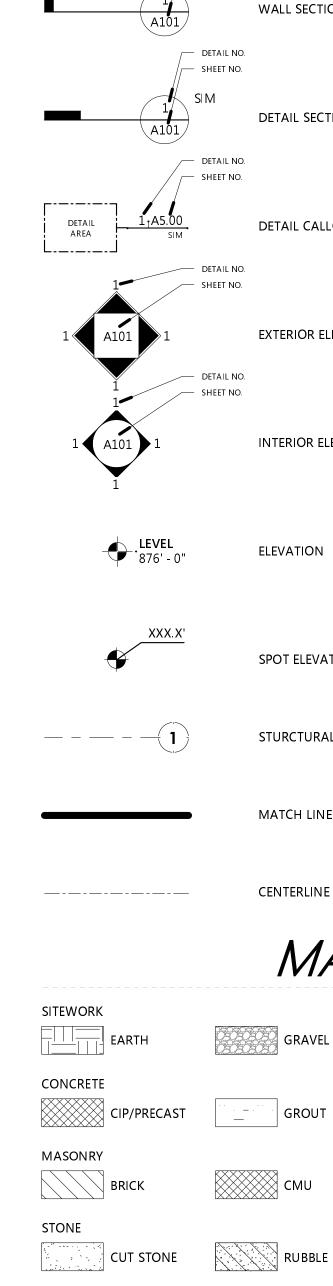
G = GAS

GA = GAUGE

GALV = GALVANIZED

GC = GENERAL CONTRACTOR GEN L = GENERAL GL = GLASS GR = GRANITEGRND = GROUNDGST = GLAZED STRUCTURAL TILE GWB = GYPSUM WALL BOARD HB = HOSE BIBB BDW = HARDWARE HDWD = HARDWOOD HM = HOLLOW METAL HORIZ = HORIZONTAL HR = HOUR HS = HIGH STRENGTH HT = HEIGHTHVAC = HEATING, VENTILATION, A/C ID = INSIDE DIAMETER IG = INSIDE GLAZED IN = INCH INFO = INFORMATION INSUL = INSULATION INT = INTERIOR JC = JANITORS CLOSET LAM = LAMINATE (D) LLH = LONG LEG HORIZONTAL LLV = LONG LEG VERTICAL LT(G) = LIGHTING(ING)LVPL = LEVELING PLATE MAINT = MAINTENANCE MDF = MEDIUM DENSITY FIBER MDO = MEDIUM DENSITY OVERLAY MECH = MECHANICAL MEMB = MEMBRANE MFD = MANUFACTURED MFR = MANUFACTURER MGT = MANAGEMENT MISC = MISCELLANEOUS MO = MASONRY OPENING NIC = NOT IN CONTRACT NTS = NOT TO SCALE OD = OUTSIDE DIAMETER OH = OPPOSITE HAND PC = PERPENDICULAR PCP = PRECAST CONCRETE PLATE PFN = PREFINISH (ED)P/L = PROPERTY LINEPLAM = PLASTIC LAMINATE PLY WD = PLY WOOD PREFAB = PREFABRICATED PSF = POUNDS PER SQUARE FOOT PSI = POUNDS PER SQUARE INCH





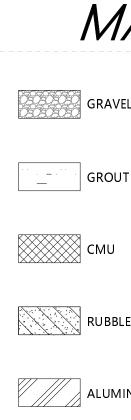
– DETAIL NO.

- SHEET NO.

- DETAIL NO

SHEET NO

SIM



FINISH PLYWOOD (LARGE SCALE)

STEEL

METAL

WOOD

FINISHES PLASTIC

GLASS GLASS

BATT/ LOOSE

INSULATION

RIGID

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FLR = FLOOR

FT = FEET

FTG = FOOTING

FV = FIELD VERIFY

FLUOR = FLUORESCENT

FND = FOUNDATION

FOF = FACE OF FINISH

FOS = FACE OF STUD

SYMBOLS LEGEND

HDAC DRAWING INDEX

			G0.00	COVER SHEET
BUILDING SECTION	AREA NAME 100 SF	AREA TAG	G0.01	SITE PLAN (ARCHITECTURAL)
			G1.03	FLOOR, CEILING & WALL ASSEMBLIES
	ROOM NAME		A1.00	FOUNDATION PLAN
WALL SECTION	101	ROOM TAG	A1.01	EXISTING BASEMENT + NEW LEVEL 1 PLAN
	150 SF		A1.02	EXISTING LEVEL 1 PLAN
DETAIL SECTION	(î) Note	CODED NOTE	A1.03	NEW MEZZANINE PLAN
			A1.04	EXISTING ATTIC
			A1.05	ROOF PLAN
DETAIL CALLOUT	?	KEYNOTE	A2.00	BUILDING ELEVATIONS
			A2.01	BUILDING ELEVATIONS
	\wedge		A8.00	RENDERINGS
EXTERIOR ELEVATION		REVISION TAG	A8.01	RENDERINGS
			A8.02	MATERIAL PALETTE
INTERIOR ELEVATION	W22	WALL TAG	A8.03	SITE LIGHTING
	Alba		A8.04	EXISTING IMAGES
			CIVIL	CIVIL SITE PLAN
ELEVATION		WINDOW TAG		

SPOT ELEVATION (101)STURCTURAL GRID LINE

<(AC1)>

DOOR TAG FLOOR/ROOF TAG

ACCESSORY TAG

CENTERLINE

MATERIALS LEGEND

GRAVEL	GEOLOGICAL ROCK		PROJECT SUMMARY
GROUT	+ + + + + + + + + + + + + + + + + + +	PARCEL SUMMARY:	DELAWARE COUNTY PARCEL NO. 31942513051002 0.46 ACRES
厥 сми	FIREBRICK	PROJECT DESCRIPTION:	THE PROJECT CONSISTS OF A CHANGE OF OCCUPANCY WITH ALTERATIONS TO AN EXISTING
RUBBLE	SLATE		2,772 SF IIIB STRUCTURE LOCATED WITHIN THE VILLAGE OF POWELL, OHIO. A 2,821 SF ADDITION OF TYPE VB CONSTRUCTION WILL BE ADDED TO THE NORTH. THESE COMBINED SPACES WILL
ALUMINUM	BRASS		ACCOMMODATE AN A-2 ASSEMBLY OCCUPANCY WITH SUPPORTING OFFICE, RESTROOMS, STORAGE, UTILITY AND CIRCULATION AS REQUIRED FOR A
	BLOCKING		PRIVATE SOCIAL CLUB.
PLYWOOD (SMALL SCALE)	CORK		
GYPSUM PLASTER	CERAMIC TILE		
RIGID	SPRAY FOAM		



PROJECT DIRECTORY

Architect:

Civil Engineer:

Structural Engineer:

MEP Engineer:

General Contractor:

OHIO FIRE CODE 2017

Goodnight Investments Michael + Gretchen Bonasera thefoodsmith@foodsmith.com Owner Phone No.

SJM studio, LLC Sarah Mackert sjm@sjmstudiollc.com (937) 215-0845

IBI Group **Eric Chenevey** eric.chenevey@ibigroup.com 614.679.3645

Ehlers Engineering, LLC Derek Ehlers, PE derek@ehlersengineering.com 614.330.2298

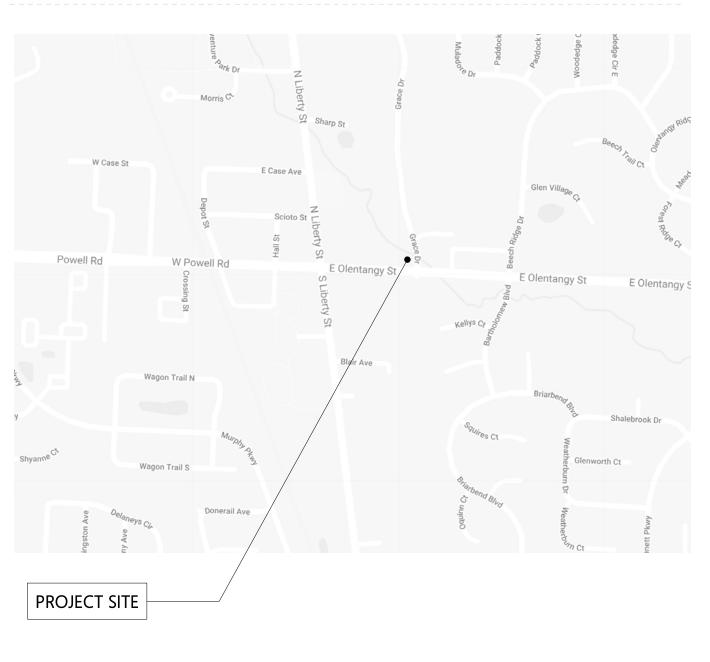
Allemang Engineering, LLC Donald K. Allemang, PE dalleman@columbus.rr.com 614.580.9006

Lincoln Construction Greg Schmitt gschmitt@lincolnconstruction.com 614.457.0180

APPLICABLE CODES

VILLAGE OF POWELL, PLANNING AND ZONING CODE 2017 OHIO BUILDING CODE (OBC0 + AMENDMENTS 2017 OHIO PLUMBING CODE (OPC) + AMENDMENTS 2017 OHIO MECHANICAL CODE (OMC) + AMENDMENTS 2017 NATIONAL ELECTRIC CODE (NEC) | NFPA 70 ICC A117.1-2009 ACCESSIBLE + USABLE BUILDINGS + FACILITIES 2012 INTERNATIONAL ENERGY CONSERVATION CODE + AMENDMENTS 2015 INTERNATIONAL FUEL GAS CODE ASHRAE 90.1 2010 NATIONAL FIRE ALARM + SIGNALING CODE (NFPA 72-10)

VICINITY MAP



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REVISION

PROJECT TITLE

ISSUE

ISSUE DATE

SHEET TITLE

SHEET NO.

THE VENERY

80 E OLENTANGY STREET POWELL, OHIO 43065 PROJECT NO. SJM_2010

COVER SHEET

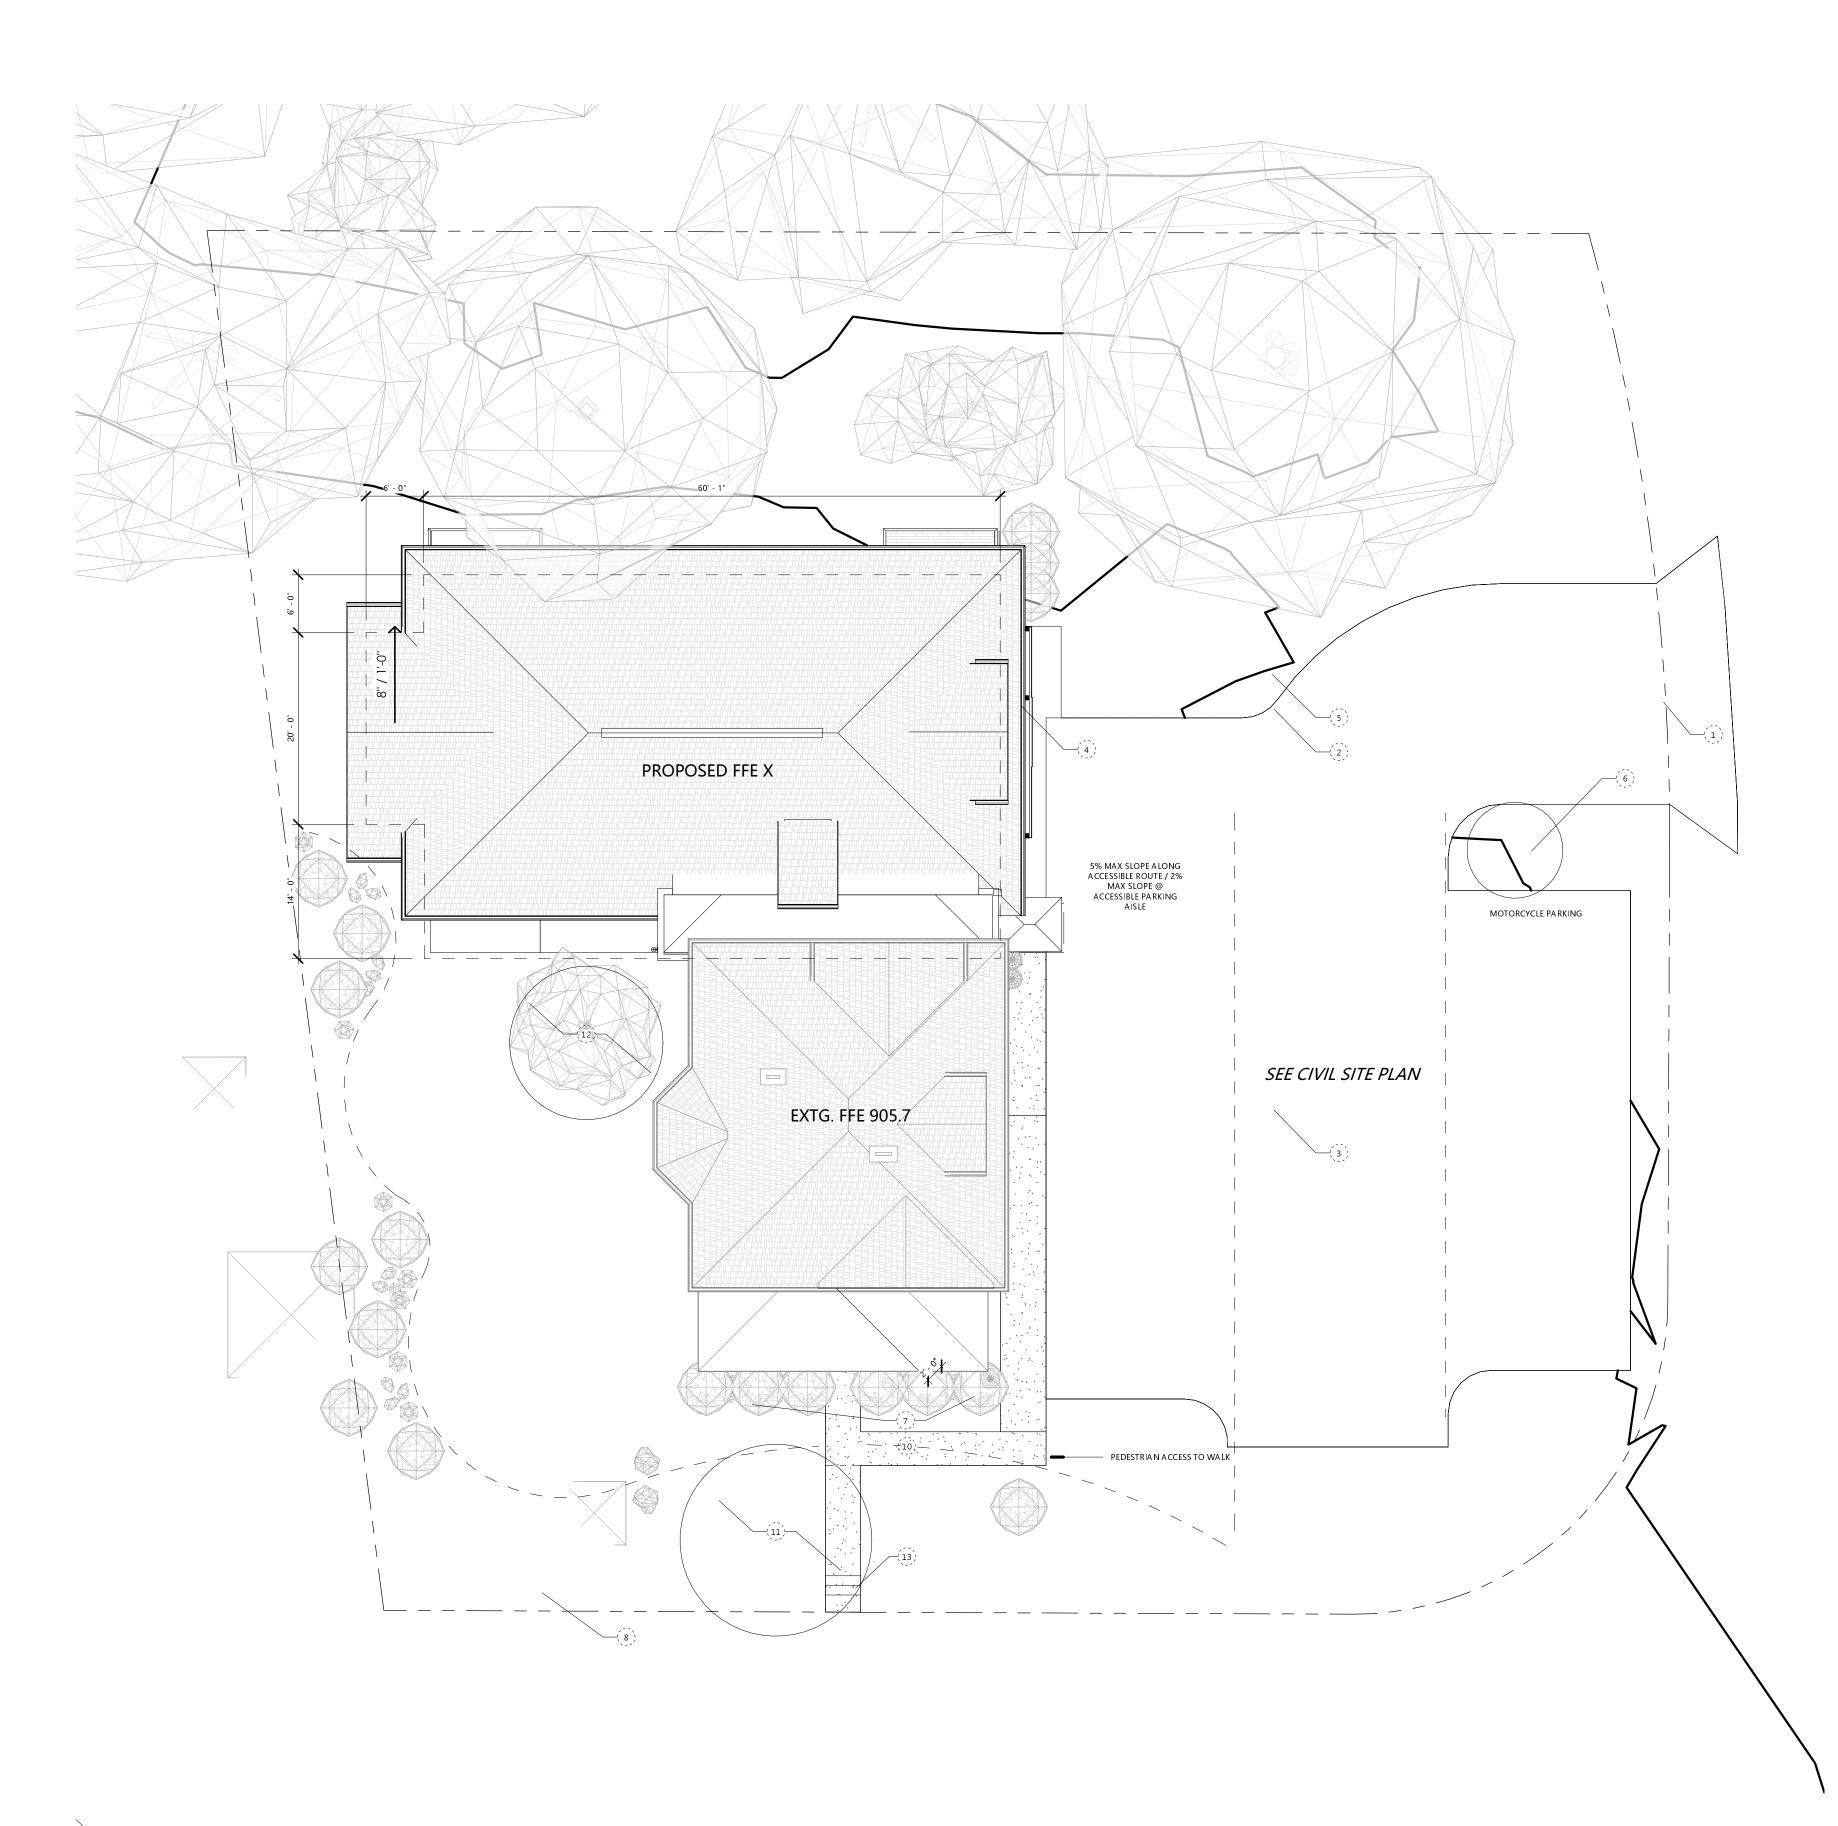
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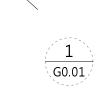
HDAC

03.29.2021











PARCEL NO. ZONING DISTRICT HEIGHT DISTRICT

0' 5' 10'

GENERAL ZONING INFORMATION

DELAWARE COUNTY NO. 319-425-13-051-002 DB - DOWNTOWN BUSINESS DISTRICT H-35

SITE DATA

PROPERTY ADDRESS: 80 E OLENTANGY POWELL, OH 43065

GOODNIGHT INVESTMENTS

4200 MACDUFF WAY DUBLIN, OH 43016

20,201.79 SF / 0.46 ACRES

1323 SF EXISTING BUILDING 2193 SF NEW ADDITION 319 SF NEW DECK (COVERED) 44 SF NEW DECK (UNCOVERED) 3,879 SF TOTAL

TOTAL ACCESSORY BUILDING AREA: 2,556 SF TOTAL COVERED AREA: 4,040 SF OR 20%

PROPERTY OWNER:

OWNER ADDRESS:

TOTAL LOT AREA:

TOTAL PRINCIPAL

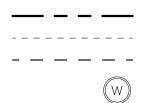
AREA:

BUILDING FOOTPRINT

SITE SCHEDULE

20% MAX. ALLOWABLE LOT USAGE: 20% PROPOSED BUILDING HEIGHT: 35.00' MAX. ALLOWABLE 25.00' PROPOSED FRONT (SOUTH): 20' MIN - 25' MAX ALLOWABLE 26' EXISTING FRONT (EAST): 20' MIN - 25' MAX ALLOWABLE 68.5' EXISTING REAR (NORTH): 5.00' MIN. ALLOWABLE 31' PROPOSED WEST SIDE: 5.00' MIN. ALLOWABLE 8.75' PROPOSED

SITE PLAN LEGEND



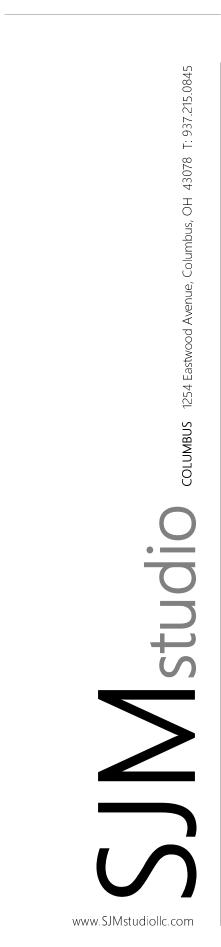
PROPERTY LINE MINIMUM SETBACK LINE – – – PROPOSED SETBACK LINE EXISTING WELL



NO. NOTE PROPOSED CURB CUT AND DRIVE ACCESS TO NEW

- PARKING LOT PROPOSED SEGMENTAL RETAINING WALL (VERSA-LOK
- OR SIM) PROPOSED PARKING (SEE CIVIL SITE PLAN)
- PROPOSED REFUSE, RECYCLING AND MISC. STORAGE
- ENCLOSURE PROPOSED ENTRANCE LANDSCAPING AREA 1. MAINTAIN EXISTING CONTRIBUTING TREES, SHRUBS
- AND NATIVE WOODLAND PLANTS PROPOSED ENTRANCE LANDSCAPING AREA 2. MAINTAIN EXISTING CONTRIBUTING TREES. NEW
- LANDSCAPING REQUIRED PROPOSED ENTRANCE LANDSCAPING AREA 3. MAINTAIN EXISTING CONTRIBUTING TREES, SHRUBS
- AND NATIVE WOODLAND PLANTS PROPOSED ENTRANCE LANDSCAPING AREA 4. MAINTAIN EXISTING CONTRIBUTING TREES, SHRUBS AND NATIVE WOODLAND PLANTS
- PROPOSED NEW PAVER WALK + STAIR 10 PROTECT AND MAINTAIN EXISTING GINKGO BILOBA 11
- TREE 12 PROPOSED SMALL ORNAMENTAL TREE (NATIVE OHIO FLOWERING DOGWOOD "CANUS FLORIDA" OR EASTERN
- REDBUD "CERCIS CANADENSIS" 13 EXISTING STEPS







PROJECT TITLE



80 E OLENTANGY STREET POWELL, OHIO 43065

PROJECT NO. SJM_2010 ISSUE HDAC **ISSUE DATE** 03.29.2021 SHEET TITLE

ARCHITECTURAL SITE PLAN



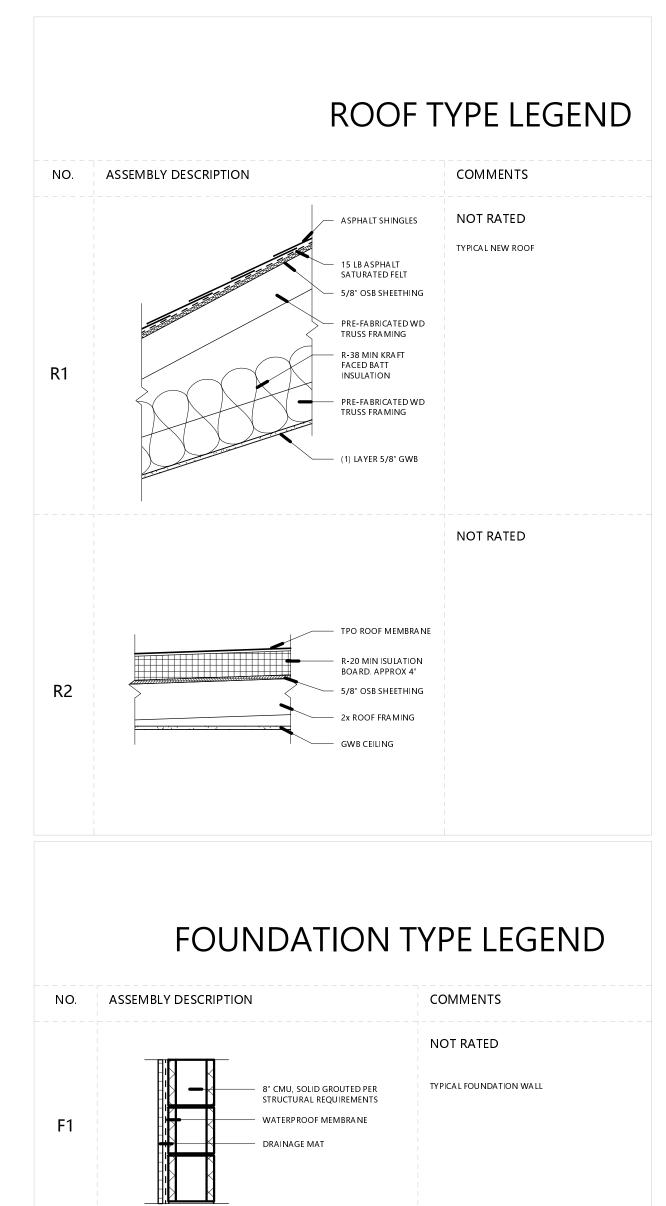
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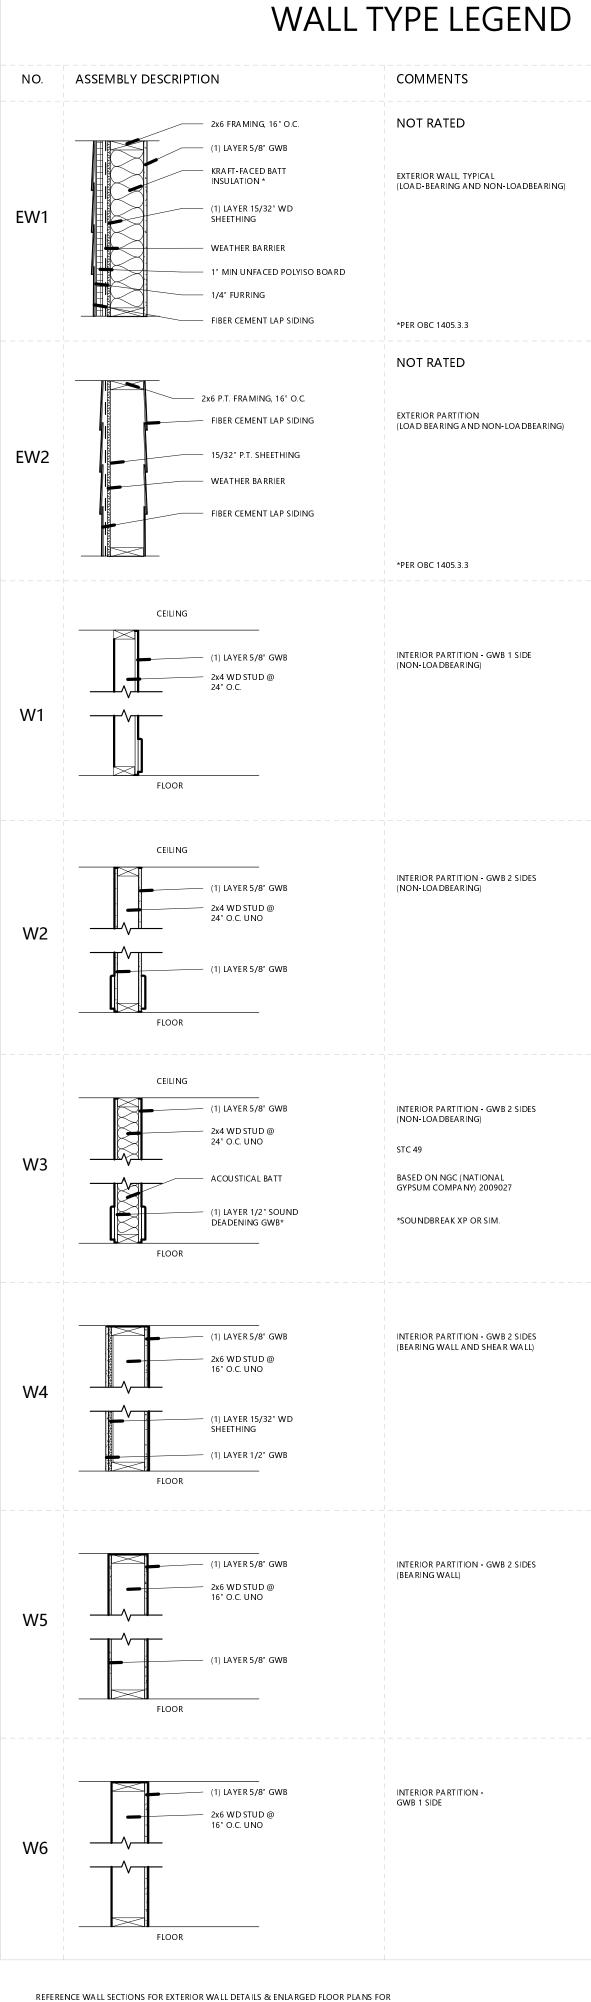
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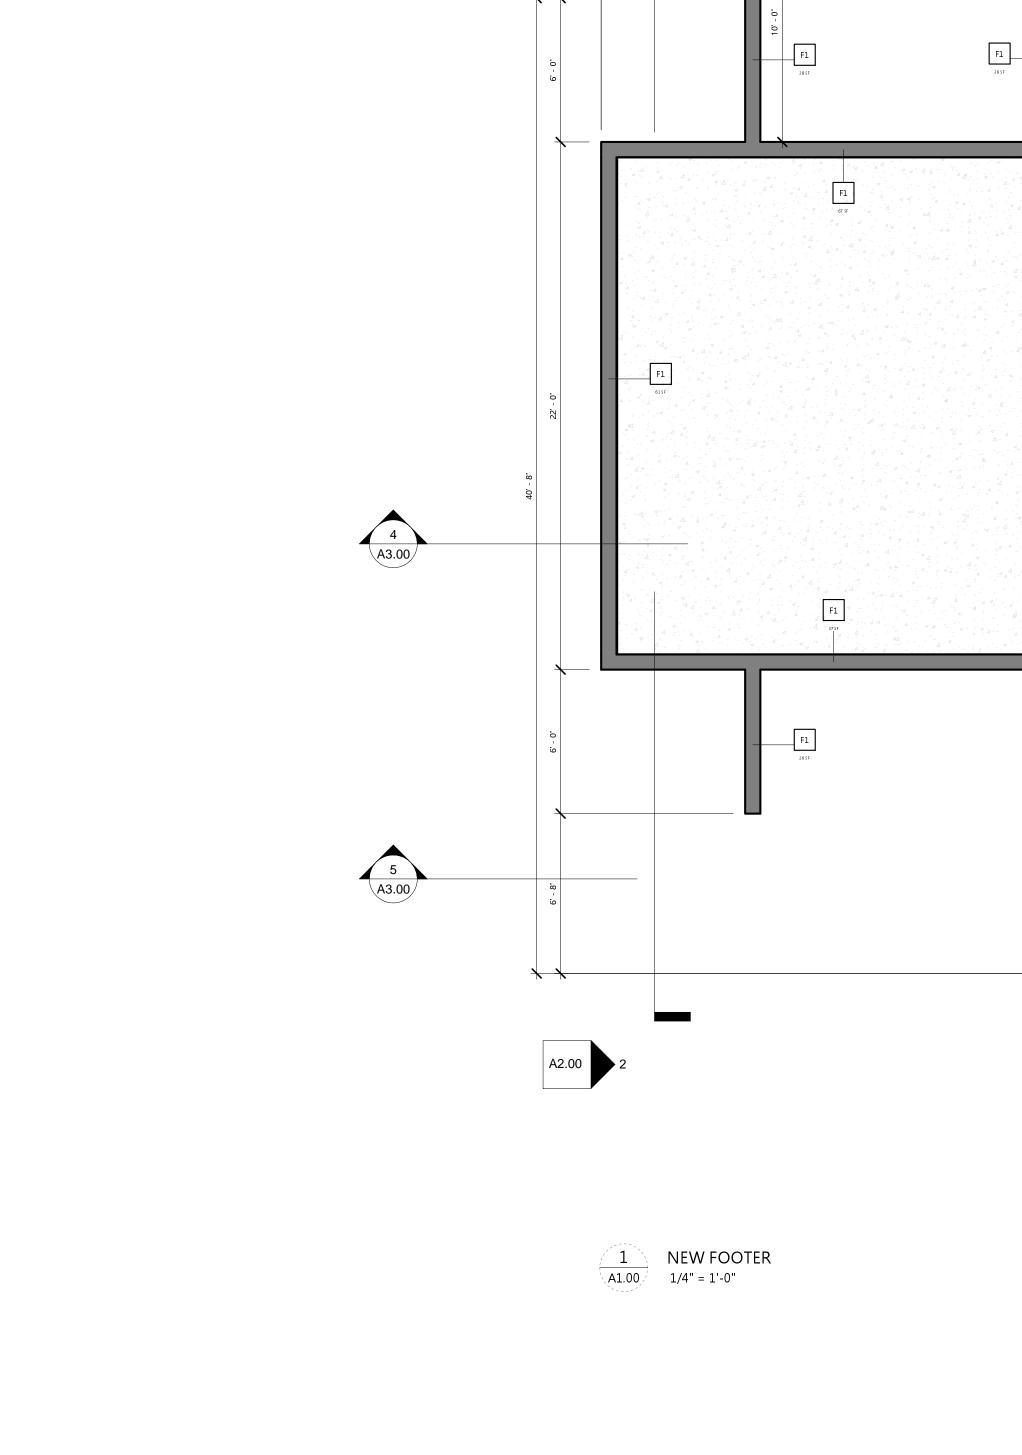
ACOUSTIC BATT INSULATION. **GWB APPLIED VERTICALLY OR HORIZONTALLY WITH 6d COOLER OR WALLBOARD NAILS @ 7" O.C. W/ END JOINTS ON NAILING MEMBERS. STAGGER JOINTS EA. SIDE.

www.SJMstudiollc.com # DATE REVISION PROJECT TITLE THE VENERY 80 E OLENTANGY STREET POWELL, OHIO 43065 SJM_2010 PROJECT NO. ISSUE HDAC **ISSUE DATE** 03.29.2021 SHEET TITLE FLOOR, CEILING, & WALL ASSEMBLIES SHEET NO. (7 © 2021 SJM studio LLC



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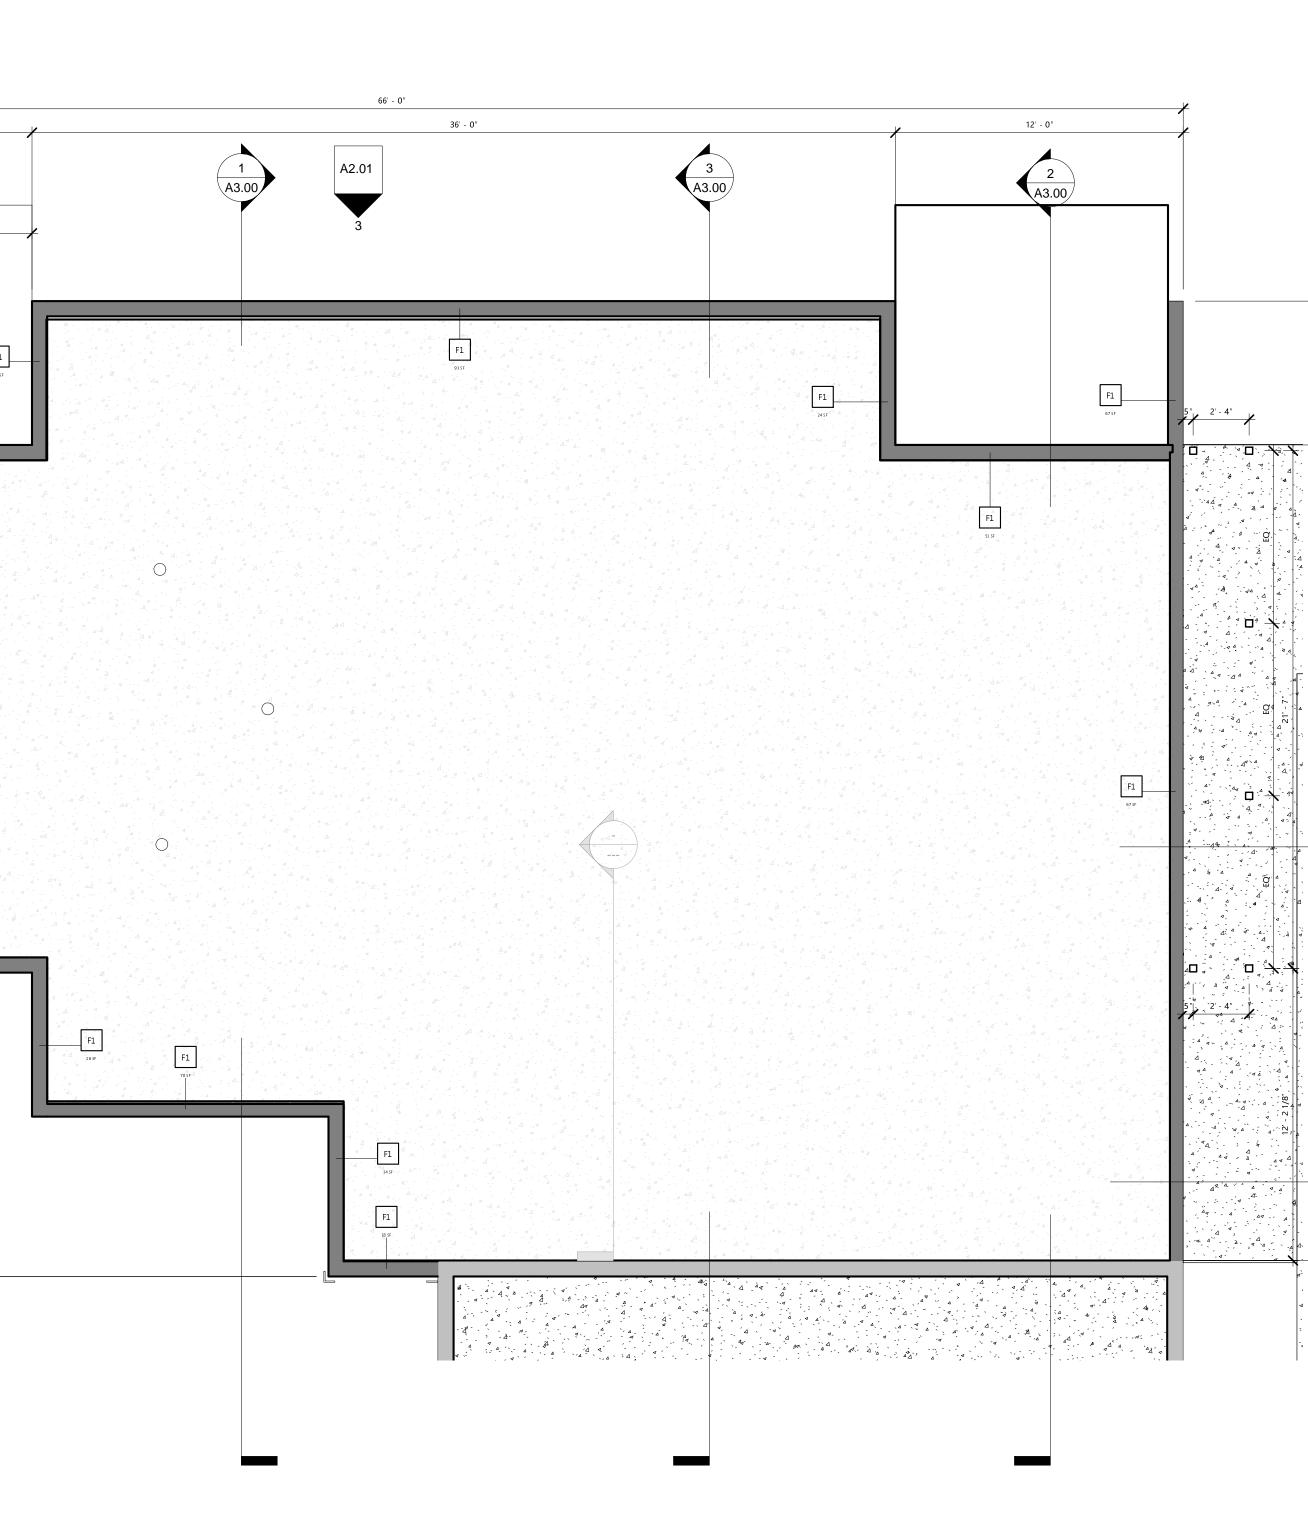
6' - 0"

7

A3.00

12' - 0"

11' - 4 3/8"





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- SEE G1.02 G1.03 FOR EXTENTS AND TECHNICAL 2. DETAILS OF FIRE-RATED BARRIERS, FIRE-RATED
- PARTITIONS AND SHAFT WALLS. SEE G1.04 FOR UL ASSEMBLIES.
- SEE G1.10 FOR TYPICAL ACCESSIBLE CLEARANCES AND 4. DETAILS. EXTERIOR DIMENSIONS ARE TO FACE OF 5.
- FOUNDATION, FACE OF MASONRY OR FACE OF SHEATHING UNO.
- INTERIOR DIMENSIONS ARE TO FACE OF STUD UNO. 6. VERIFY ALL DIMENSIONS PRIOR TO BEGINNING WORK 7.
- AND NOTIFY ARCHITECT FOR RESOLUTION OF ANY DISCREPANCIES. EXTEND FIRE BARRIERS TO UNDERSIDE OF DECK 8.
- ABOVE UNO. PROVIDE SOUND BATT IN SULATION AT ALL TOILET 9.
- ROOMS AND MECHANICAL ROOMS. 10. PROVIDE 5/8" CEMENT BACKER BOARD AT ALL TILE WALL LOCATIONS W/ BLOCKING BEHIND ALL CEMENT
- BACKER BOARD SEAMS. PROVIDE 5/8" MOISTURE RESISTANT GWB AT ALL WET 11.
- WALL LOCATIONS. COMPLY WITH MANUFACTURER INSTRUCTIONS FOR 12.
- INSTALLATION OF BUILDING MATERIALS AND FF&E. 13. LOCATION AND SIZE OF PENETRATIONS/MEMBRANE PENETRATIONS OF FIRE-RATED ASSEMBLIES ARE APPROXIMATE. GC TO FIELD VERIFY SIZE AND
- LOCATION. CONSULT OWNER TO VERIFY PROJECT SALVAGE 14. REQUIREMENTS OF ITEMS NOT IDENTIFIED FOR REUSE
- HERE PRIOR TO REMOVAL START. PROTECT EXISTING ORIGINAL ARCHITECTURE 15. THROUGHOUT INCLUDING WINDOWS, DOORS, MISC. GLASS, CASEWORK, MILLWORK, STAIRS, RAILINGS, HARDWARE AND (TO THE GREATEST EXTENT
- POSSIBLE) PLASTER. 16.
 - COMMERCIAL SPACE SCOPE: GC TO PROVIDE "WARM GRAY BOX $_{\star}$ Α. INCLUDING PLUMBING ROUGH-INS, ELECTRICAL SERVICE, TEMPORARY HEAT, LEVEL 4 FINISH ALL GWB SURFACES

FLOOR PLAN NOTES

NO. NOTE

- INACCESSIBLE EXTG. CRAWL SPACE CONDITIONS TO BE 1 VERIFIED IN FIELD.
- EXTG. VENTILATION OPENINGS IN CRAWL SPACE
- FOUNDATION WALL, TYP. OF (3) REMOVE EXTG. STONE MASONRY AS REQ'D TO PROVIDE 3 NEW SECURE, INSULATED CRAWL SPACE ACCESS PANEL.
- EXTG. SPLIT SYSTEM AHU TO REMAIN. RECONFIGURE 4 EXTG. DUCTWORK AS REQ'D TO ACCOMODATE OVERHEAD CLEARANCE IN BASEMENT ROOM 1 AND 2
- PROVIDE NEW OPENING IN EXTG. LOAD BEARING MASONRY WALL
- PROVIDE NEW 4" CONC. SLAB THROUGHOUT BASEMENT PROVIDE NEW 8" DOUBLE WYTHE BRICK MASONRY WALL ON 16" WIDE X 8" DEEP REINFOCED CONC. FOOTER AS INDICATED
- MAINTAIN AS EMERGENCY EGRESS OPENING NEW 90 MINUTE FIRE-RATED DOOR IN EXTG. OPENING
- INFILL EXTG. WINDOW OPENING W/ MASONRY TO 10 MATCH EXTG.
- INFILL EXTG. DOOR OPENING W/ MASONRY TO MATCH 11 EXTG.
- 12 GLASS GUARDRAIL, 42"
- 65 GALLON REFUSE / RECYCLING TOTES AND/OR 13 LAWNCARE AND MAINTENANCE STORAGE CONCEALED IN REFUSE ENCLOSURE MAINTAIN AS EMERGENCY EGRESS OPENING 16



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PRELIMINARY

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THE VENERY

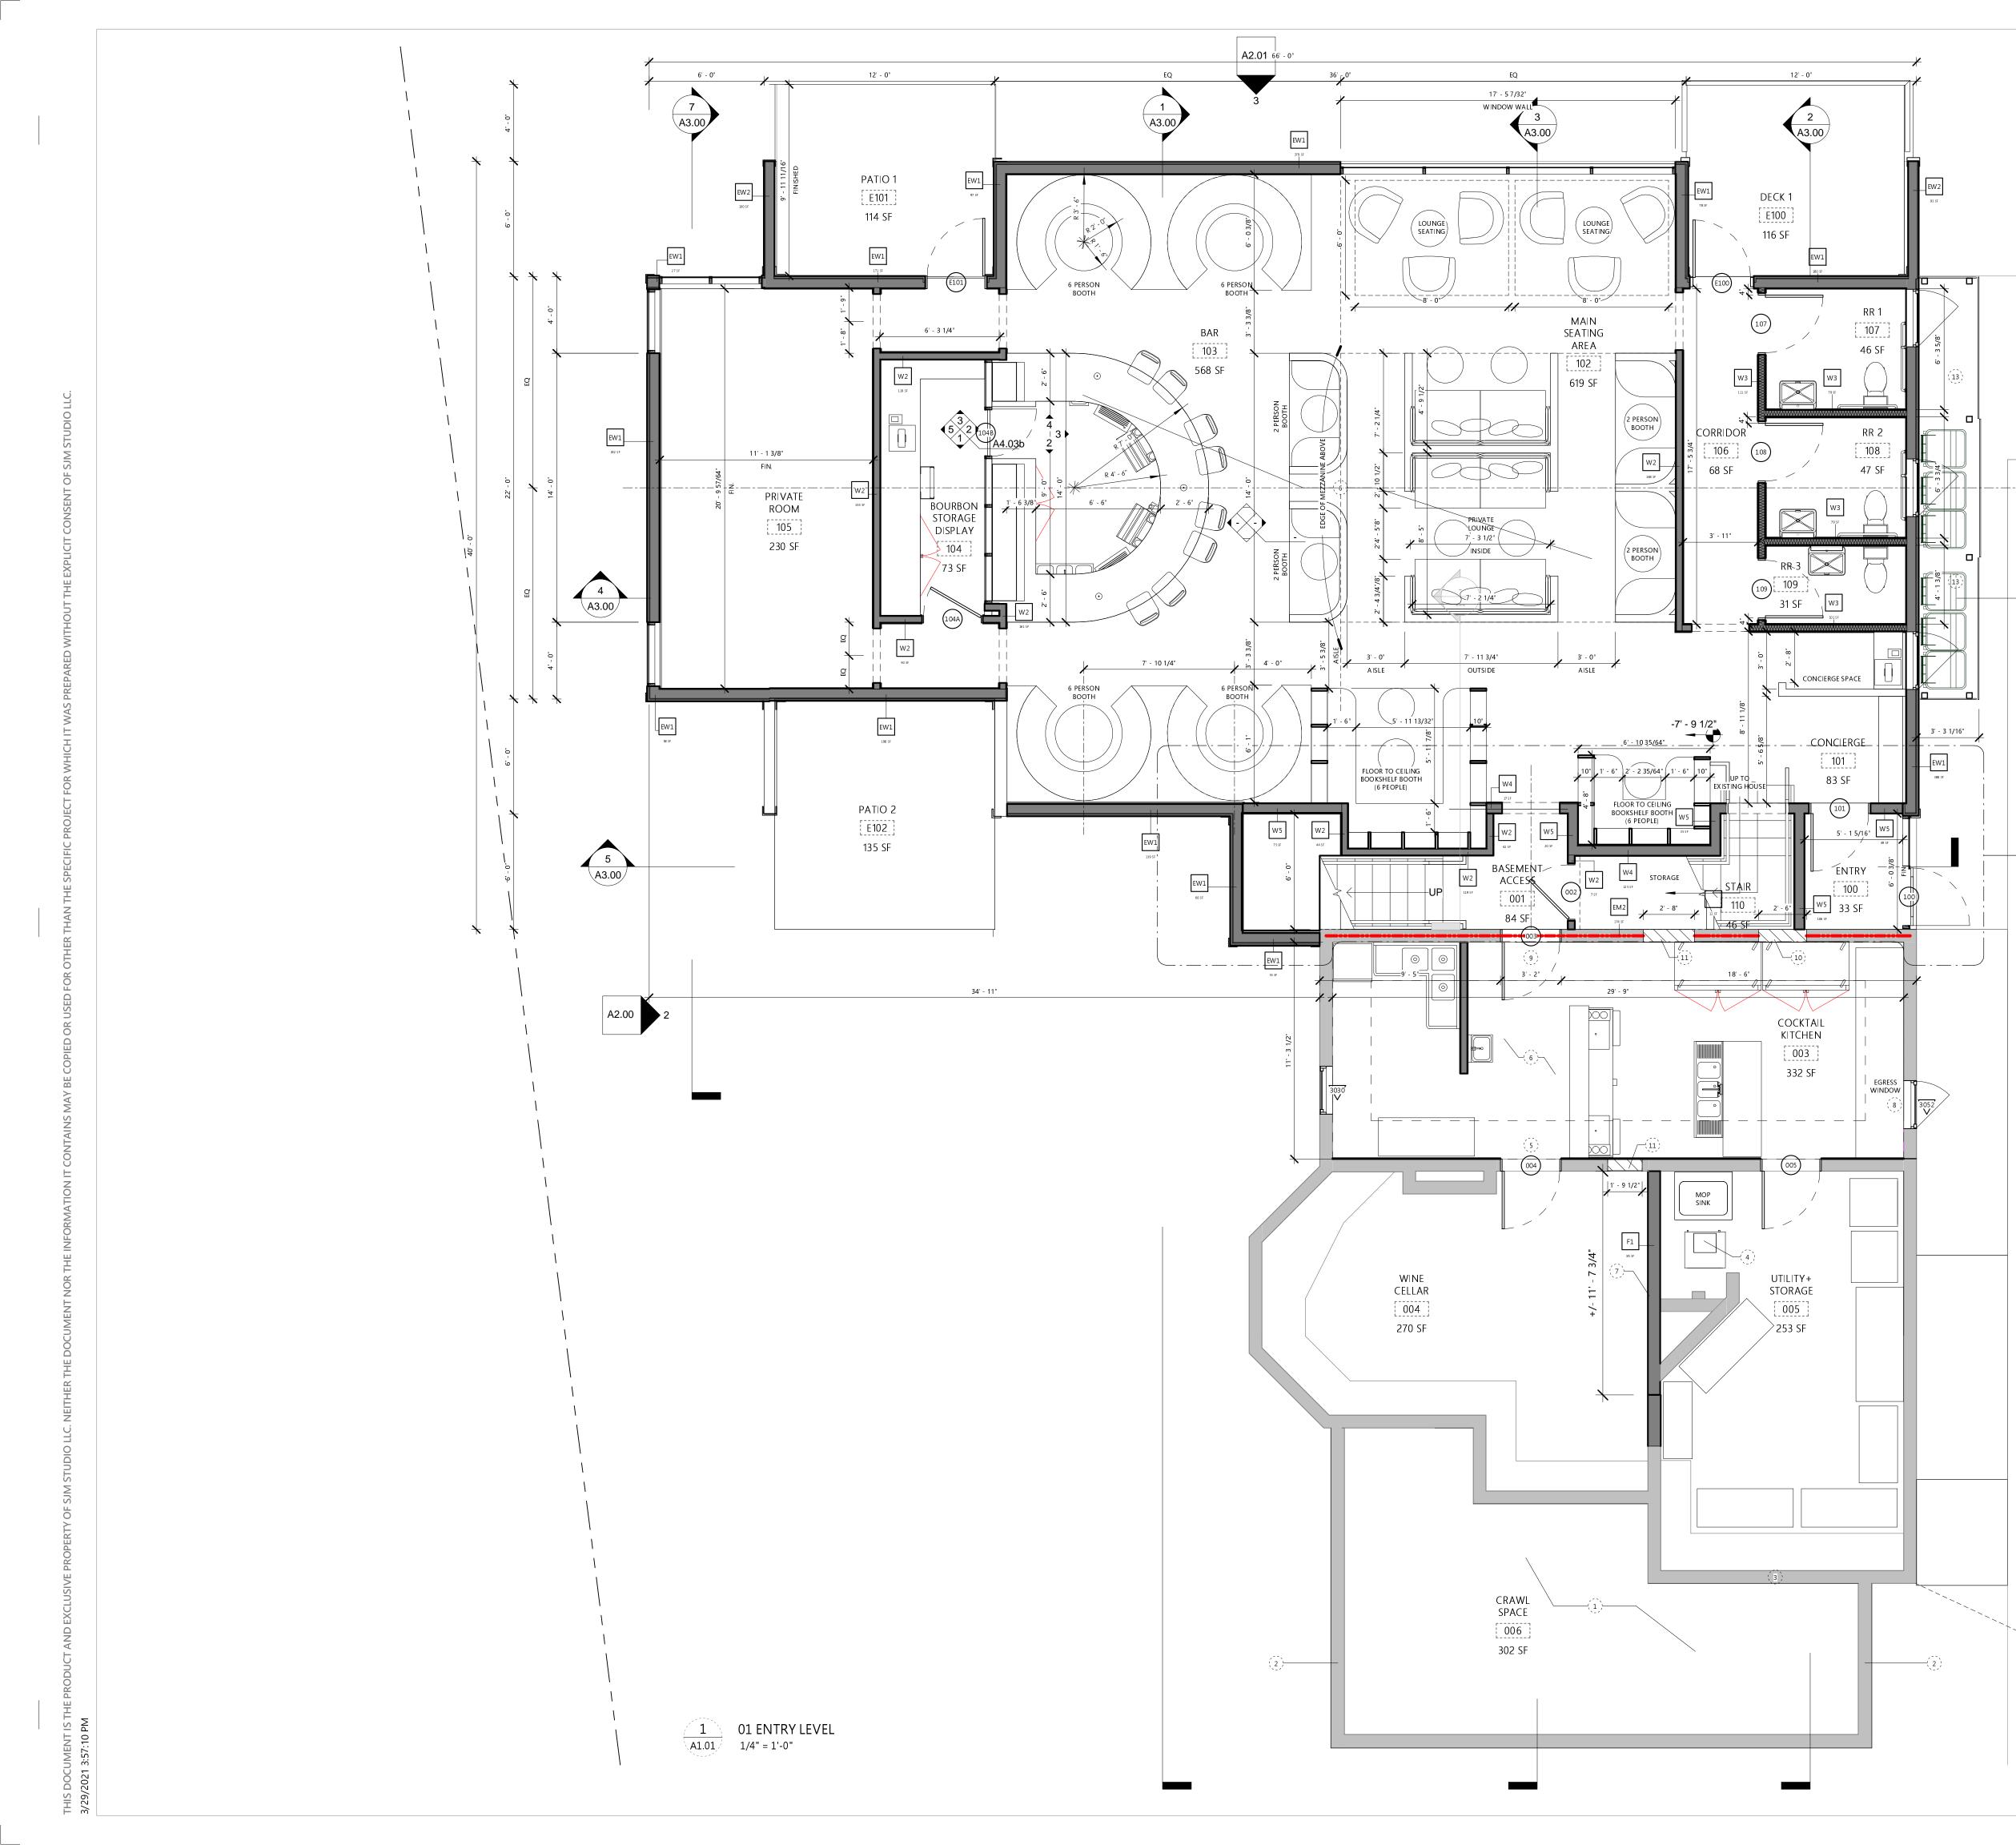
80 E OLENTANGY STREET POWELL, OHIO 43065

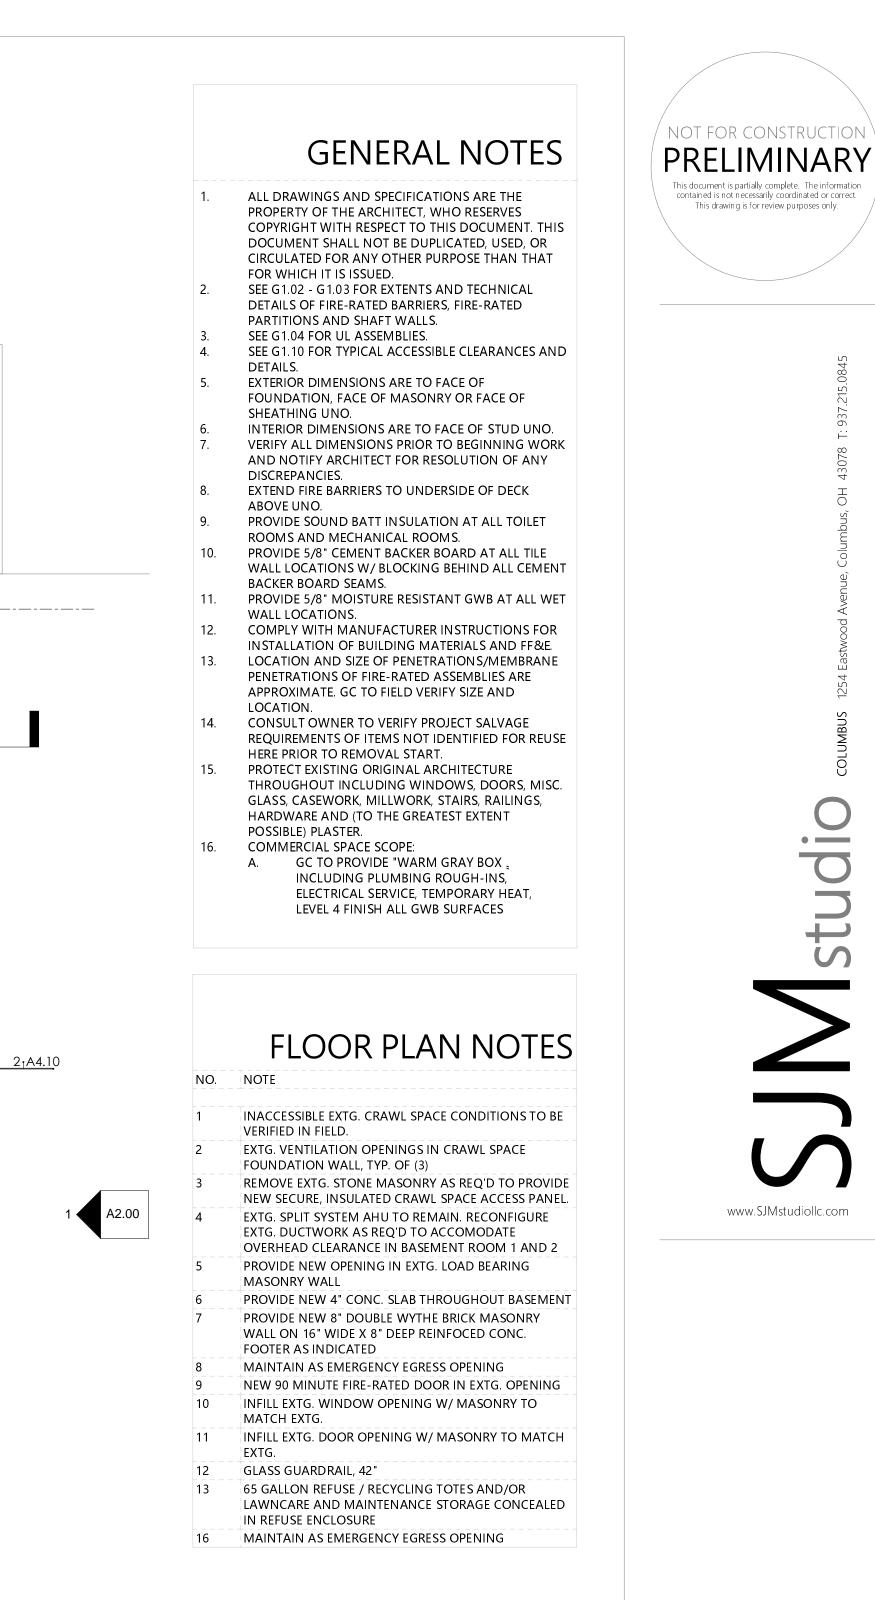
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FOUNDATION PLAN

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THE VENERY

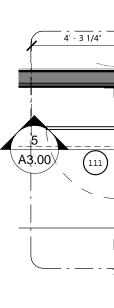
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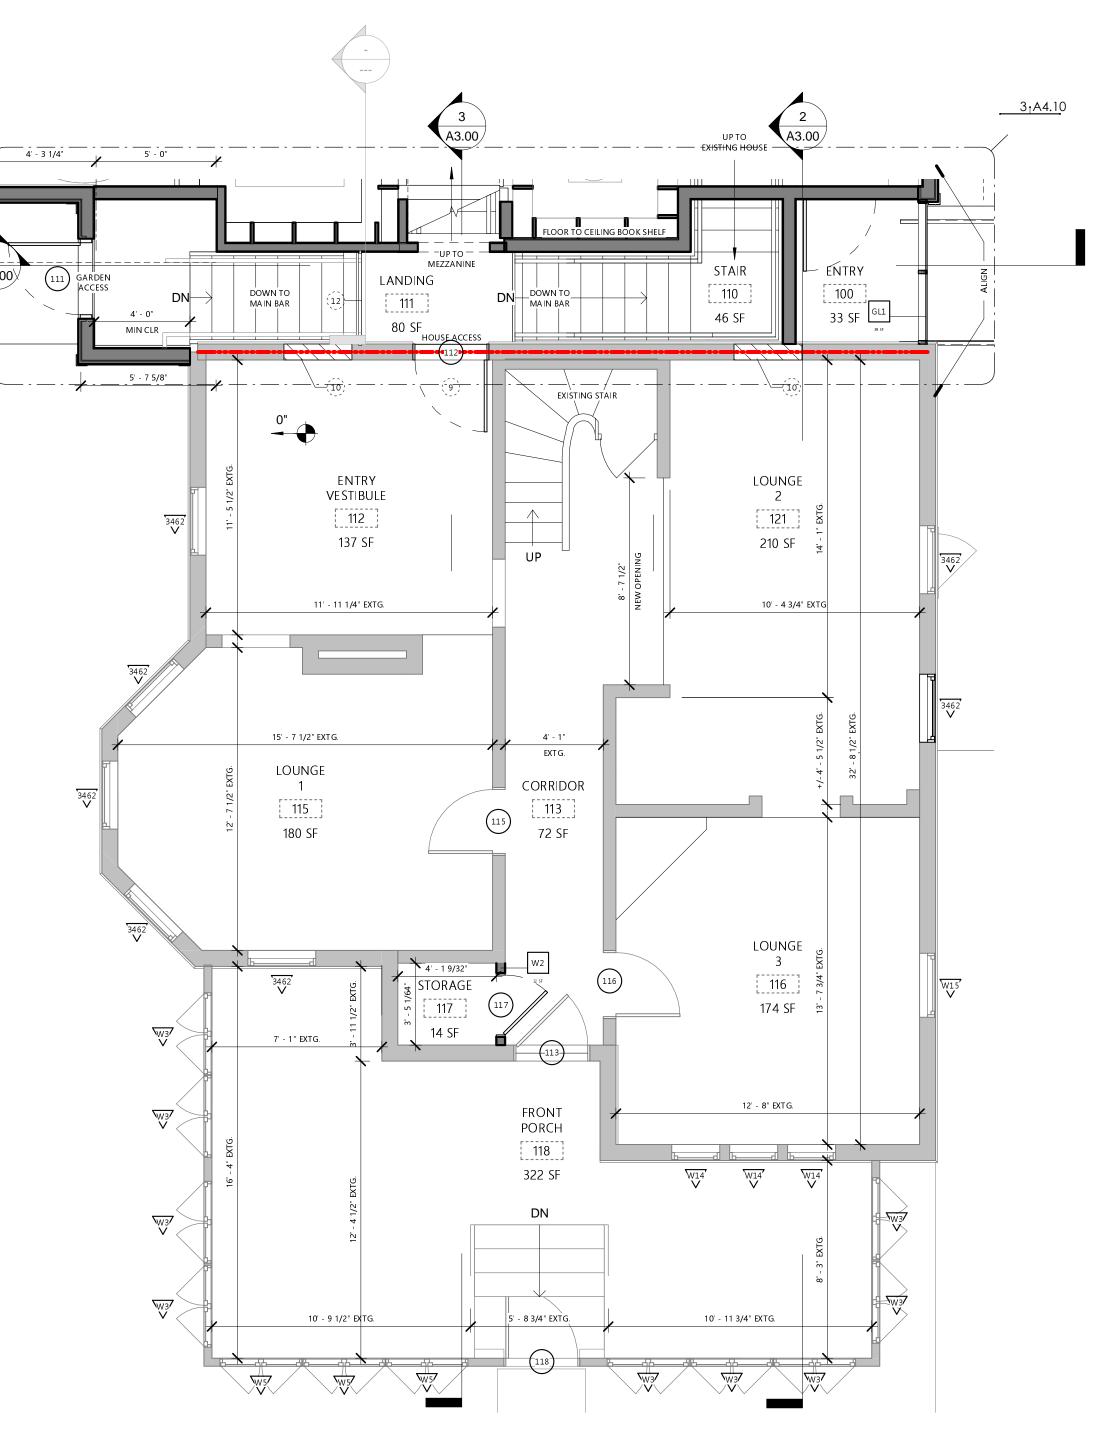
SJM_2010 PROJECT NO. ISSUE ISSUE DATE

HDAC 03.29.2021

EXTG. BASEMENT + NEW LEVEL 1 PLAN

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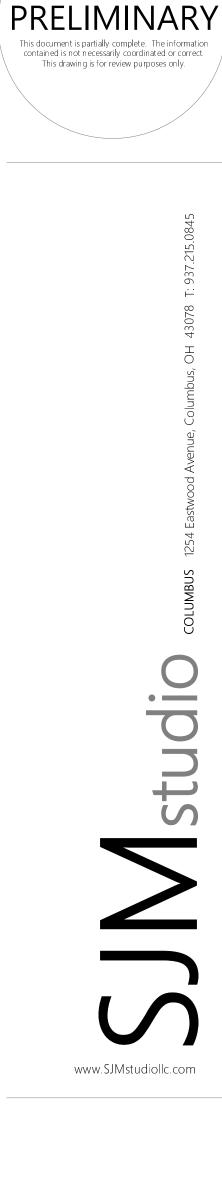




1 01 EX. LEVEL 1 A1.02 / 1/4" = 1'-0"

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HDAC

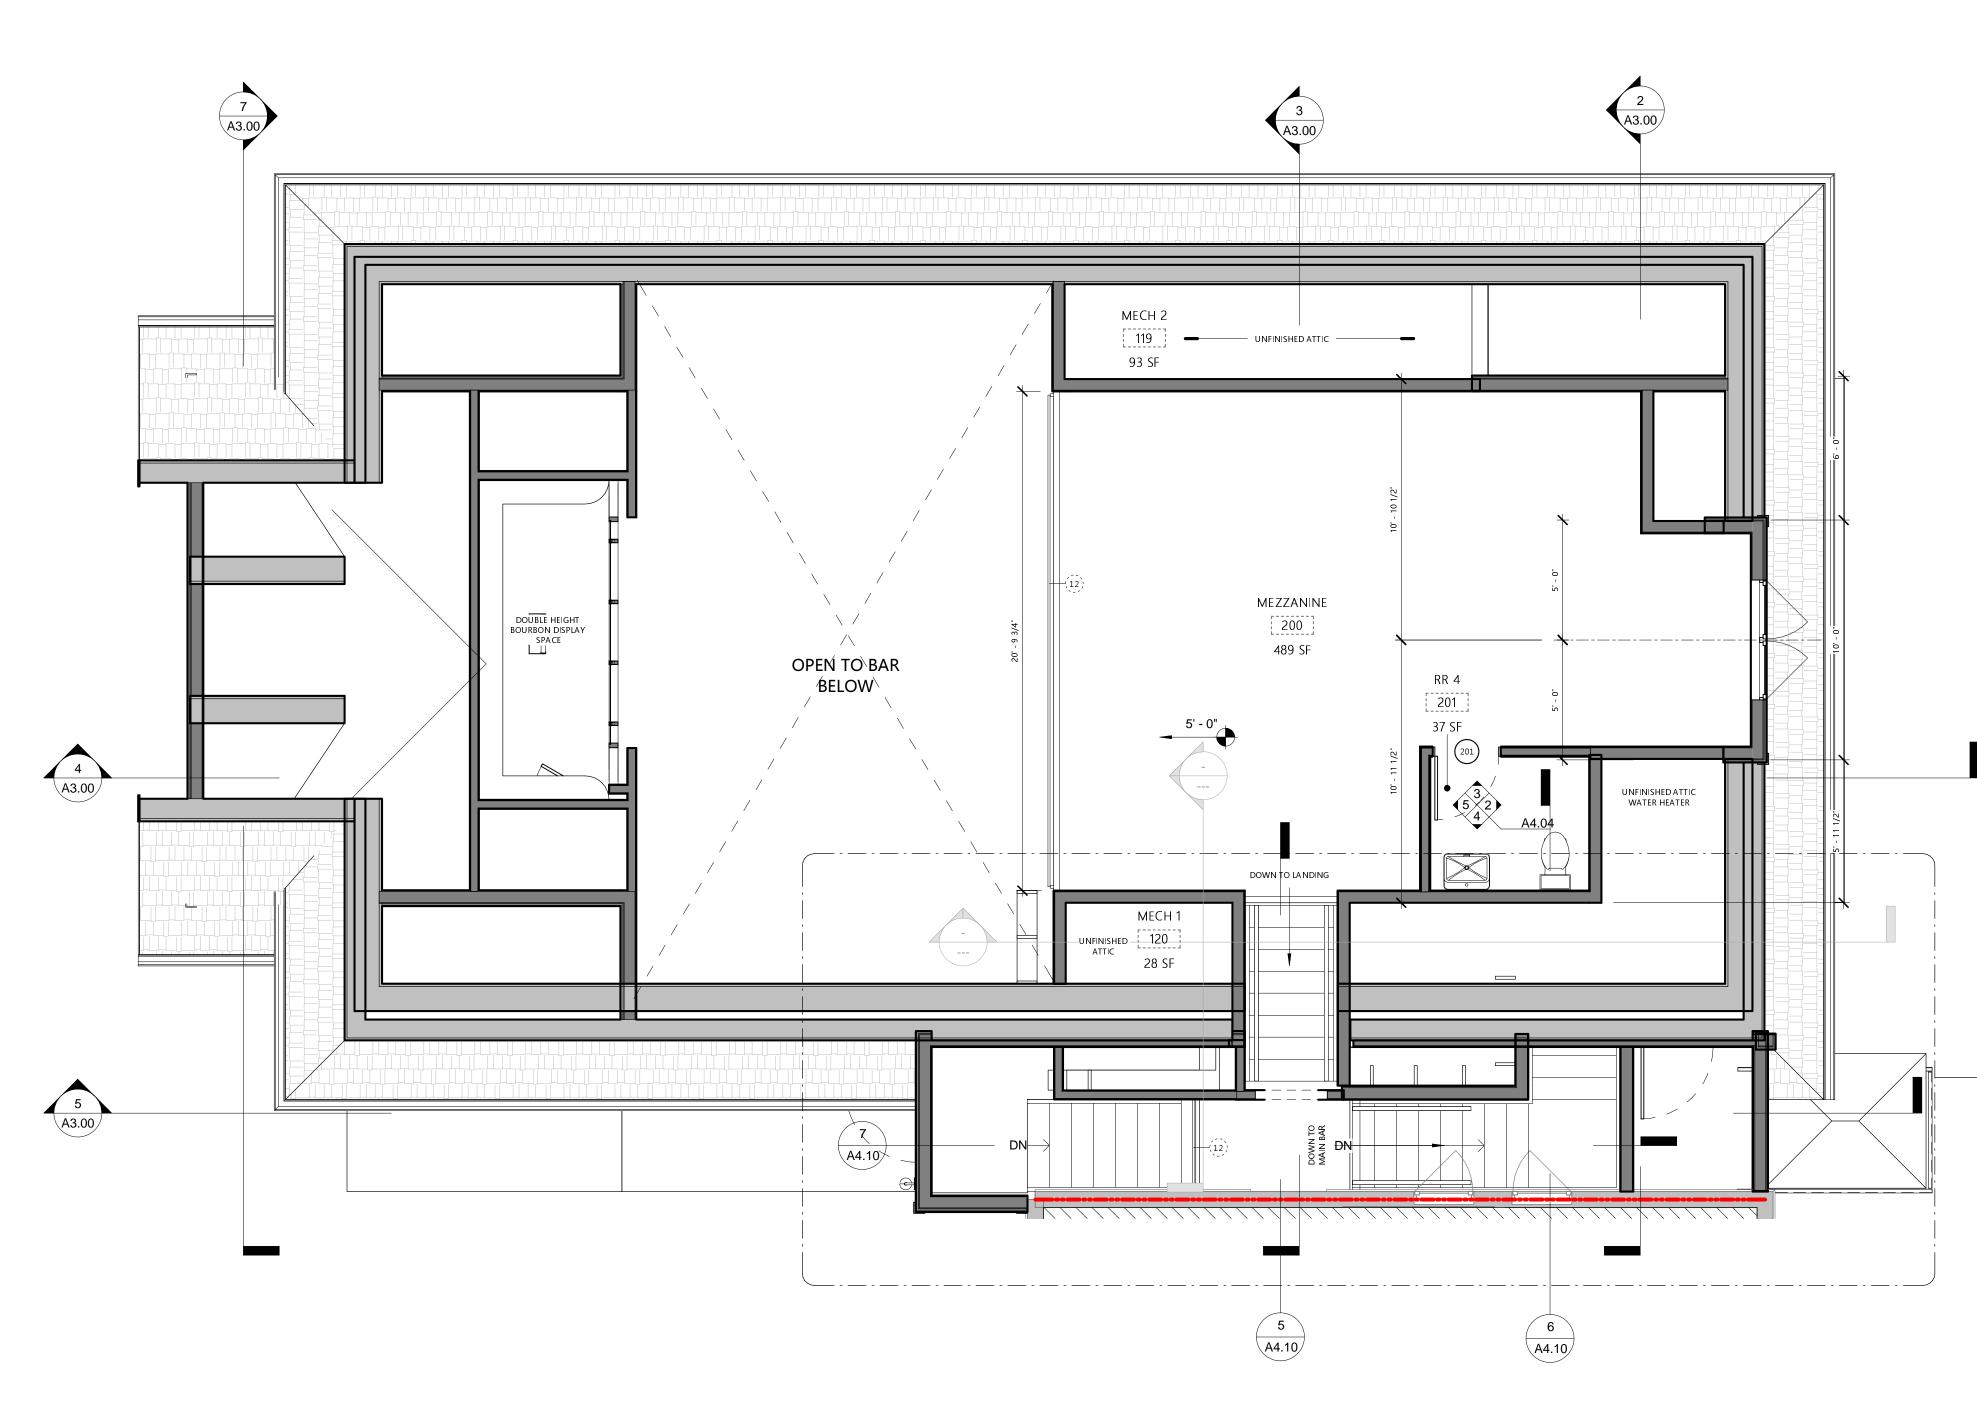
ISSUE **ISSUE DATE** 03.29.2021 SHEET TITLE

EXTG. LEVEL 1 PLAN

SHEET NO. A1.02 © 2021 SJM studio LLC







02 MEZZANINE A1.03 / 1/4" = 1'-0"

GENERAL NOTES

/ not for construction \setminus

PRELIMINARY

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DATE REVISION

PROJECT TITLE

PROJECT NO.

ISSUE DATE

SHEET TITLE

SHEET NO.

A.

ISSUE

THE VENERY

80 E OLENTANGY STREET POWELL, OHIO 43065

NEW

MEZZANINE

PLAN

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SJM_2010

03.29.2021

HDAC

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- FLOOR PLAN NOTES NO. NOTE

INCLUDING PLUMBING ROUGH-INS,

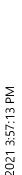
LEVEL 4 FINISH ALL GWB SURFACES

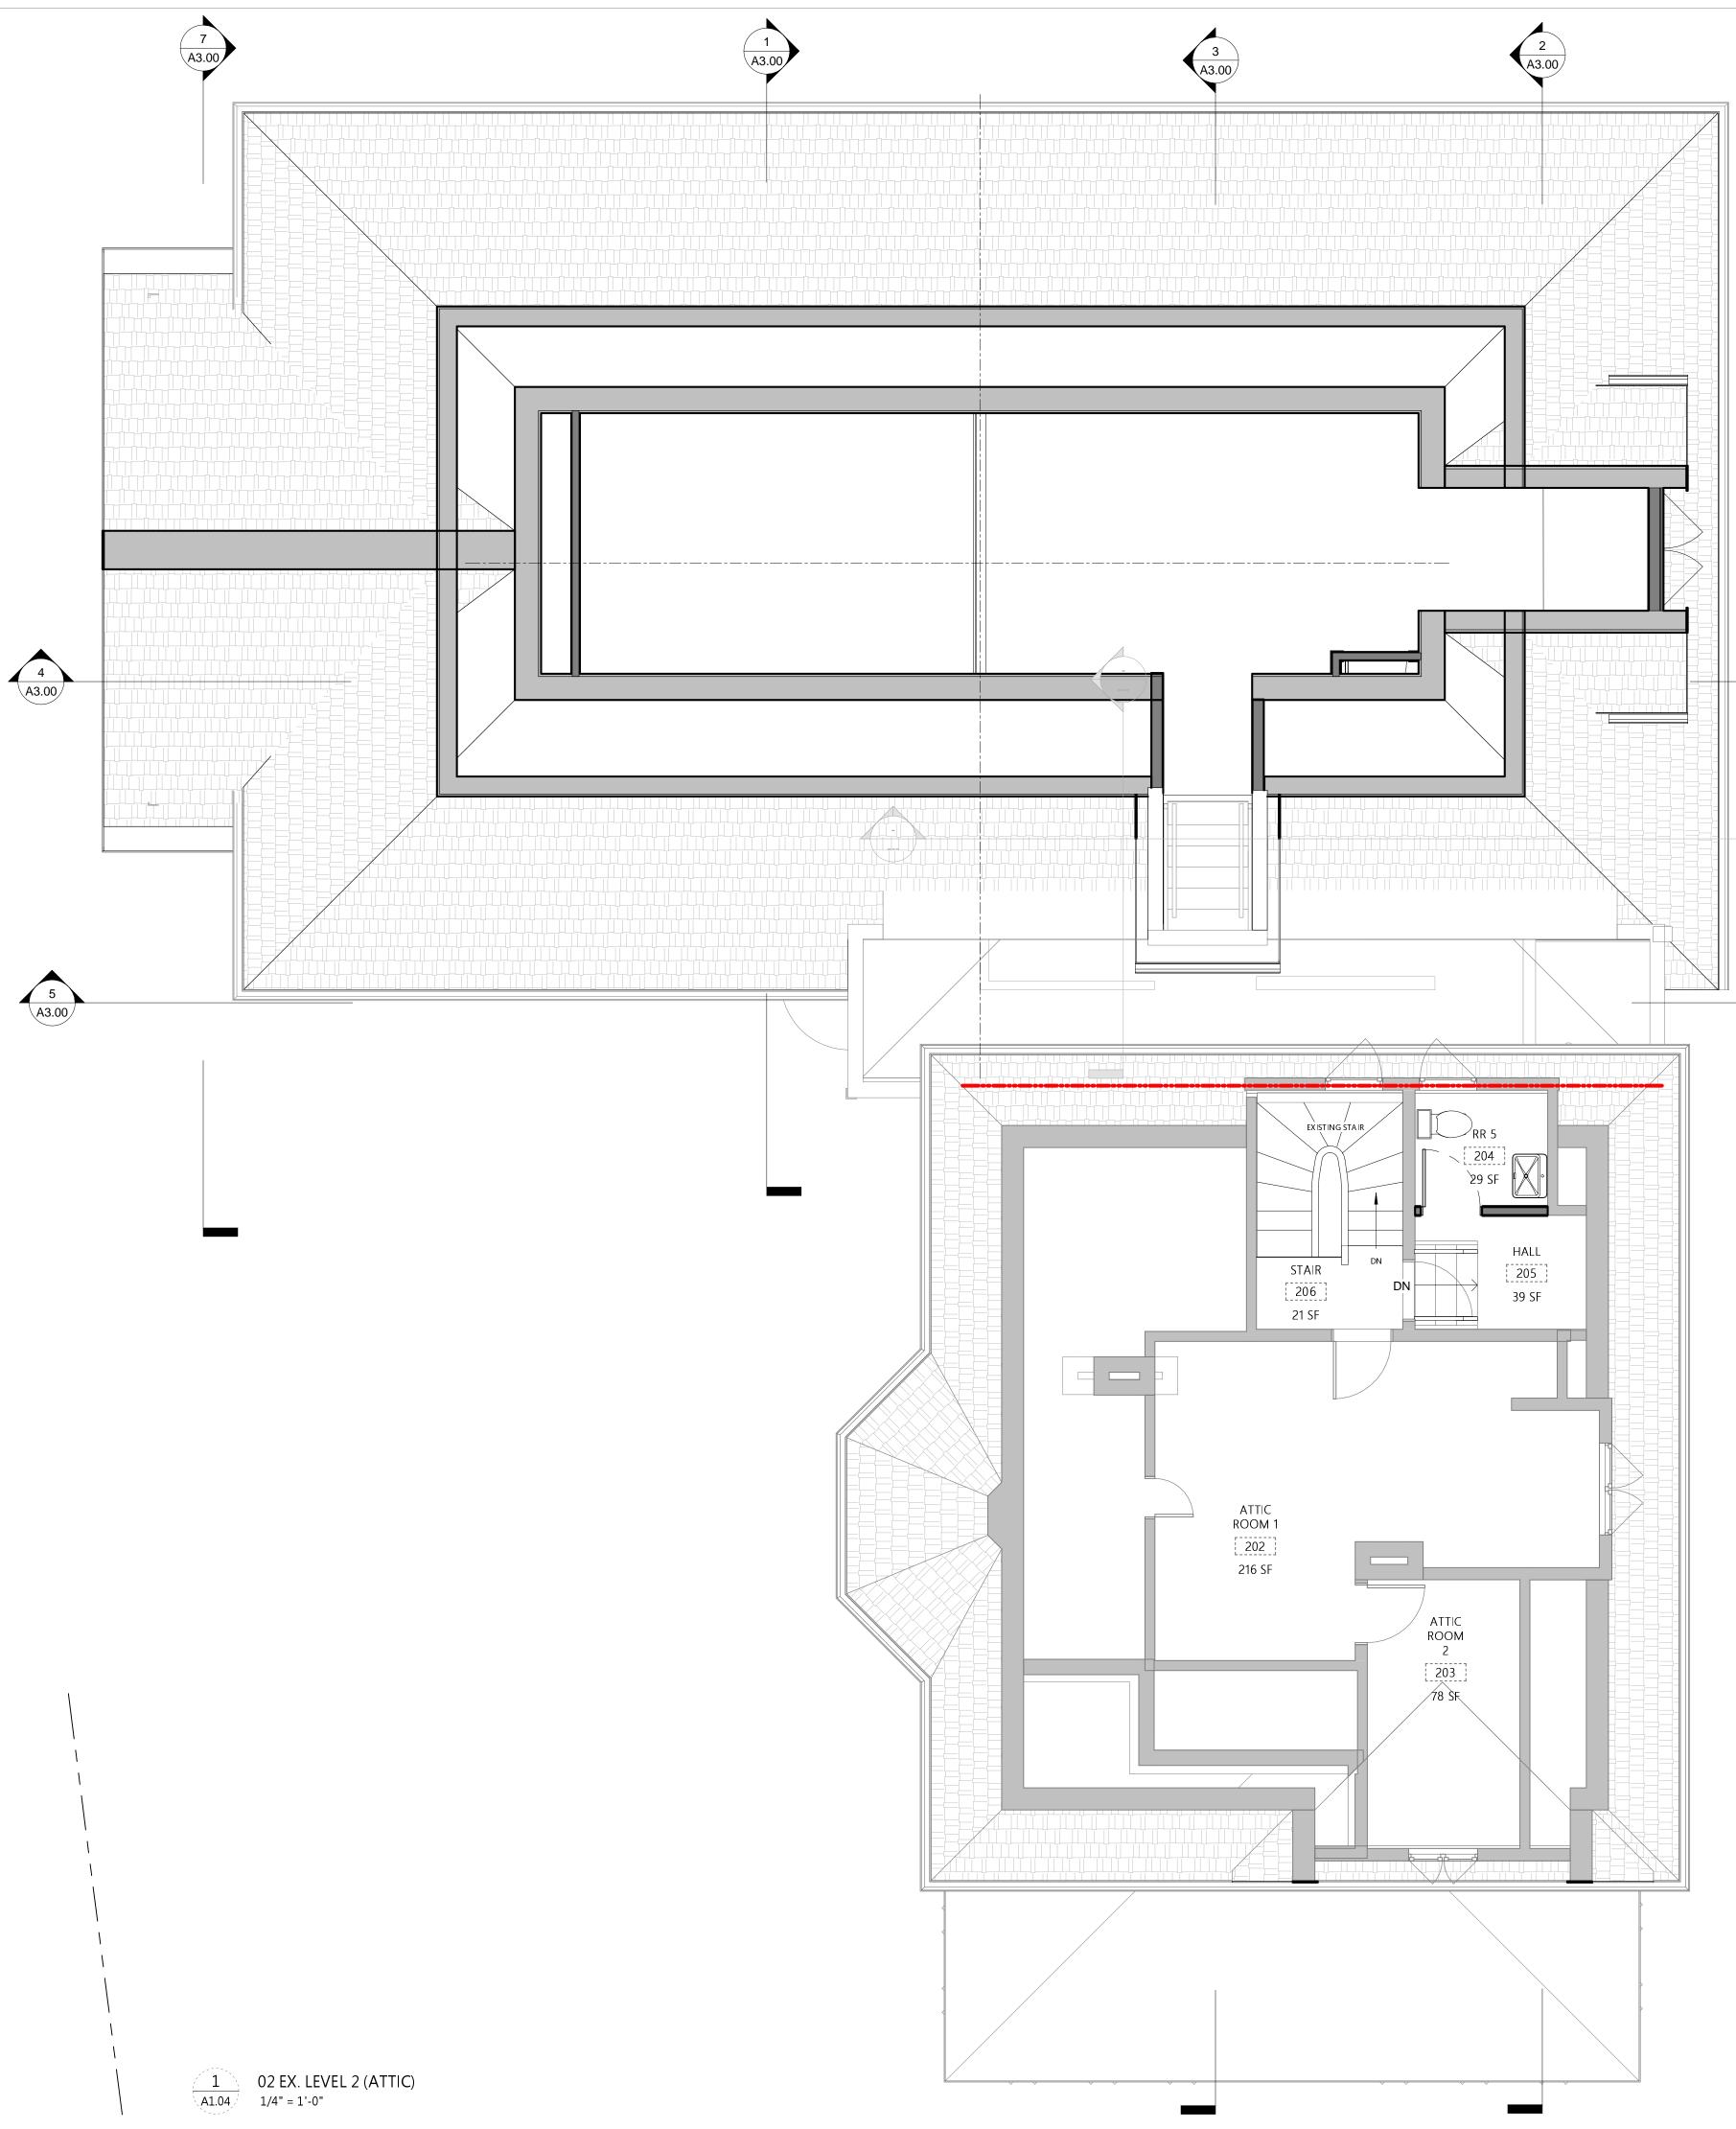
ELECTRICAL SERVICE, TEMPORARY HEAT,

- INACCESSIBLE EXTG. CRAWL SPACE CONDITIONS TO BE VERIFIED IN FIELD. EXTG. VENTILATION OPENINGS IN CRAWL SPACE 2 FOUNDATION WALL, TYP. OF (3) REMOVE EXTG. STONE MASONRY AS REQ'D TO PROVIDE NEW SECURE, INSULATED CRAWL SPACE ACCESS PANEL. EXTG. SPLIT SYSTEM AHU TO REMAIN. RECONFIGURE 4 EXTG. DUCTWORK AS REQ'D TO ACCOMODATE OVERHEAD CLEARANCE IN BASEMENT ROOM 1 AND 2 PROVIDE NEW OPENING IN EXTG. LOAD BEARING MASONRY WALL PROVIDE NEW 4" CONC. SLAB THROUGHOUT BASEMENT PROVIDE NEW 8" DOUBLE WYTHE BRICK MASONRY WALL ON 16" WIDE X 8" DEEP REINFOCED CONC. FOOTER AS INDICATED MAINTAIN AS EMERGENCY EGRESS OPENING 8 NEW 90 MINUTE FIRE-RATED DOOR IN EXTG. OPENING 9 INFILL EXTG. WINDOW OPENING W/ MASONRY TO 10 MATCH EXTG. 11 INFILL EXTG. DOOR OPENING W/ MASONRY TO MATCH EXTG. GLASS GUARDRAIL, 42" 12 13 65 GALLON REFUSE / RECYCLING TOTES AND/OR LAWNCARE AND MAINTENANCE STORAGE CONCEALED
- IN REFUSE ENCLOSURE MAINTAIN AS EMERGENCY EGRESS OPENING 16

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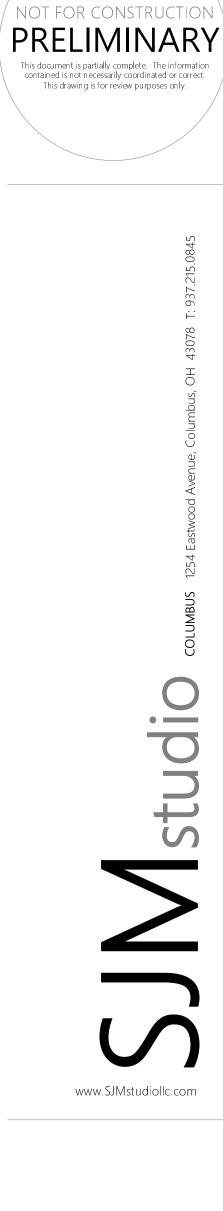
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- INTERIOR DIMENSIONS ARE TO FACE OF STUD UNO. 6. VERIFY ALL DIMENSIONS PRIOR TO BEGINNING WORK 7.
- AND NOTIFY ARCHITECT FOR RESOLUTION OF ANY DISCREPANCIES.
- EXTEND FIRE BARRIERS TO UNDERSIDE OF DECK 8. ABOVE UNO. PROVIDE SOUND BATT IN SULATION AT ALL TOILET 9.
- ROOMS AND MECHANICAL ROOMS. PROVIDE 5/8" CEMENT BACKER BOARD AT ALL TILE 10.
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- INSTALLATION OF BUILDING MATERIALS AND FF&E. 13. LOCATION AND SIZE OF PENETRATIONS/MEMBRANE PENETRATIONS OF FIRE-RATED ASSEMBLIES ARE APPROXIMATE. GC TO FIELD VERIFY SIZE AND
- LOCATION. CONSULT OWNER TO VERIFY PROJECT SALVAGE 14. REQUIREMENTS OF ITEMS NOT IDENTIFIED FOR REUSE
- HERE PRIOR TO REMOVAL START. PROTECT EXISTING ORIGINAL ARCHITECTURE 15. THROUGHOUT INCLUDING WINDOWS, DOORS, MISC. GLASS, CASEWORK, MILLWORK, STAIRS, RAILINGS,
- HARDWARE AND (TO THE GREATEST EXTENT POSSIBLE) PLASTER. COMMERCIAL SPACE SCOPE: 16.
 - GC TO PROVIDE "WARM GRAY BOX . Α. INCLUDING PLUMBING ROUGH-INS, ELECTRICAL SERVICE, TEMPORARY HEAT, LEVEL 4 FINISH ALL GWB SURFACES

FLOOR PLAN NOTES

NO. NOTE

- INACCESSIBLE EXTG. CRAWL SPACE CONDITIONS TO BE 1 VERIFIED IN FIELD.
- EXTG. VENTILATION OPENINGS IN CRAWL SPACE
- FOUNDATION WALL, TYP. OF (3) REMOVE EXTG. STONE MASONRY AS REQ'D TO PROVIDE 3 NEW SECURE, INSULATED CRAWL SPACE ACCESS PANEL.
- EXTG. SPLIT SYSTEM AHU TO REMAIN. RECONFIGURE 4 EXTG. DUCTWORK AS REQ'D TO ACCOMODATE OVERHEAD CLEARANCE IN BASEMENT ROOM 1 AND 2
- PROVIDE NEW OPENING IN EXTG. LOAD BEARING MASONRY WALL
- PROVIDE NEW 4" CONC. SLAB THROUGHOUT BASEMENT PROVIDE NEW 8" DOUBLE WYTHE BRICK MASONRY WALL ON 16" WIDE X 8" DEEP REINFOCED CONC.
- FOOTER AS INDICATED MAINTAIN AS EMERGENCY EGRESS OPENING NEW 90 MINUTE FIRE-RATED DOOR IN EXTG. OPENING
- INFILL EXTG. WINDOW OPENING W/ MASONRY TO 10 MATCH EXTG.
- INFILL EXTG. DOOR OPENING W/ MASONRY TO MATCH 11 EXTG.
- 12 GLASS GUARDRAIL, 42"
- 65 GALLON REFUSE / RECYCLING TOTES AND/OR 13 LAWNCARE AND MAINTENANCE STORAGE CONCEALED IN REFUSE ENCLOSURE MAINTAIN AS EMERGENCY EGRESS OPENING 16



DATE REVISION

PROJECT TITLE

SHEET TITLE

THE VENERY

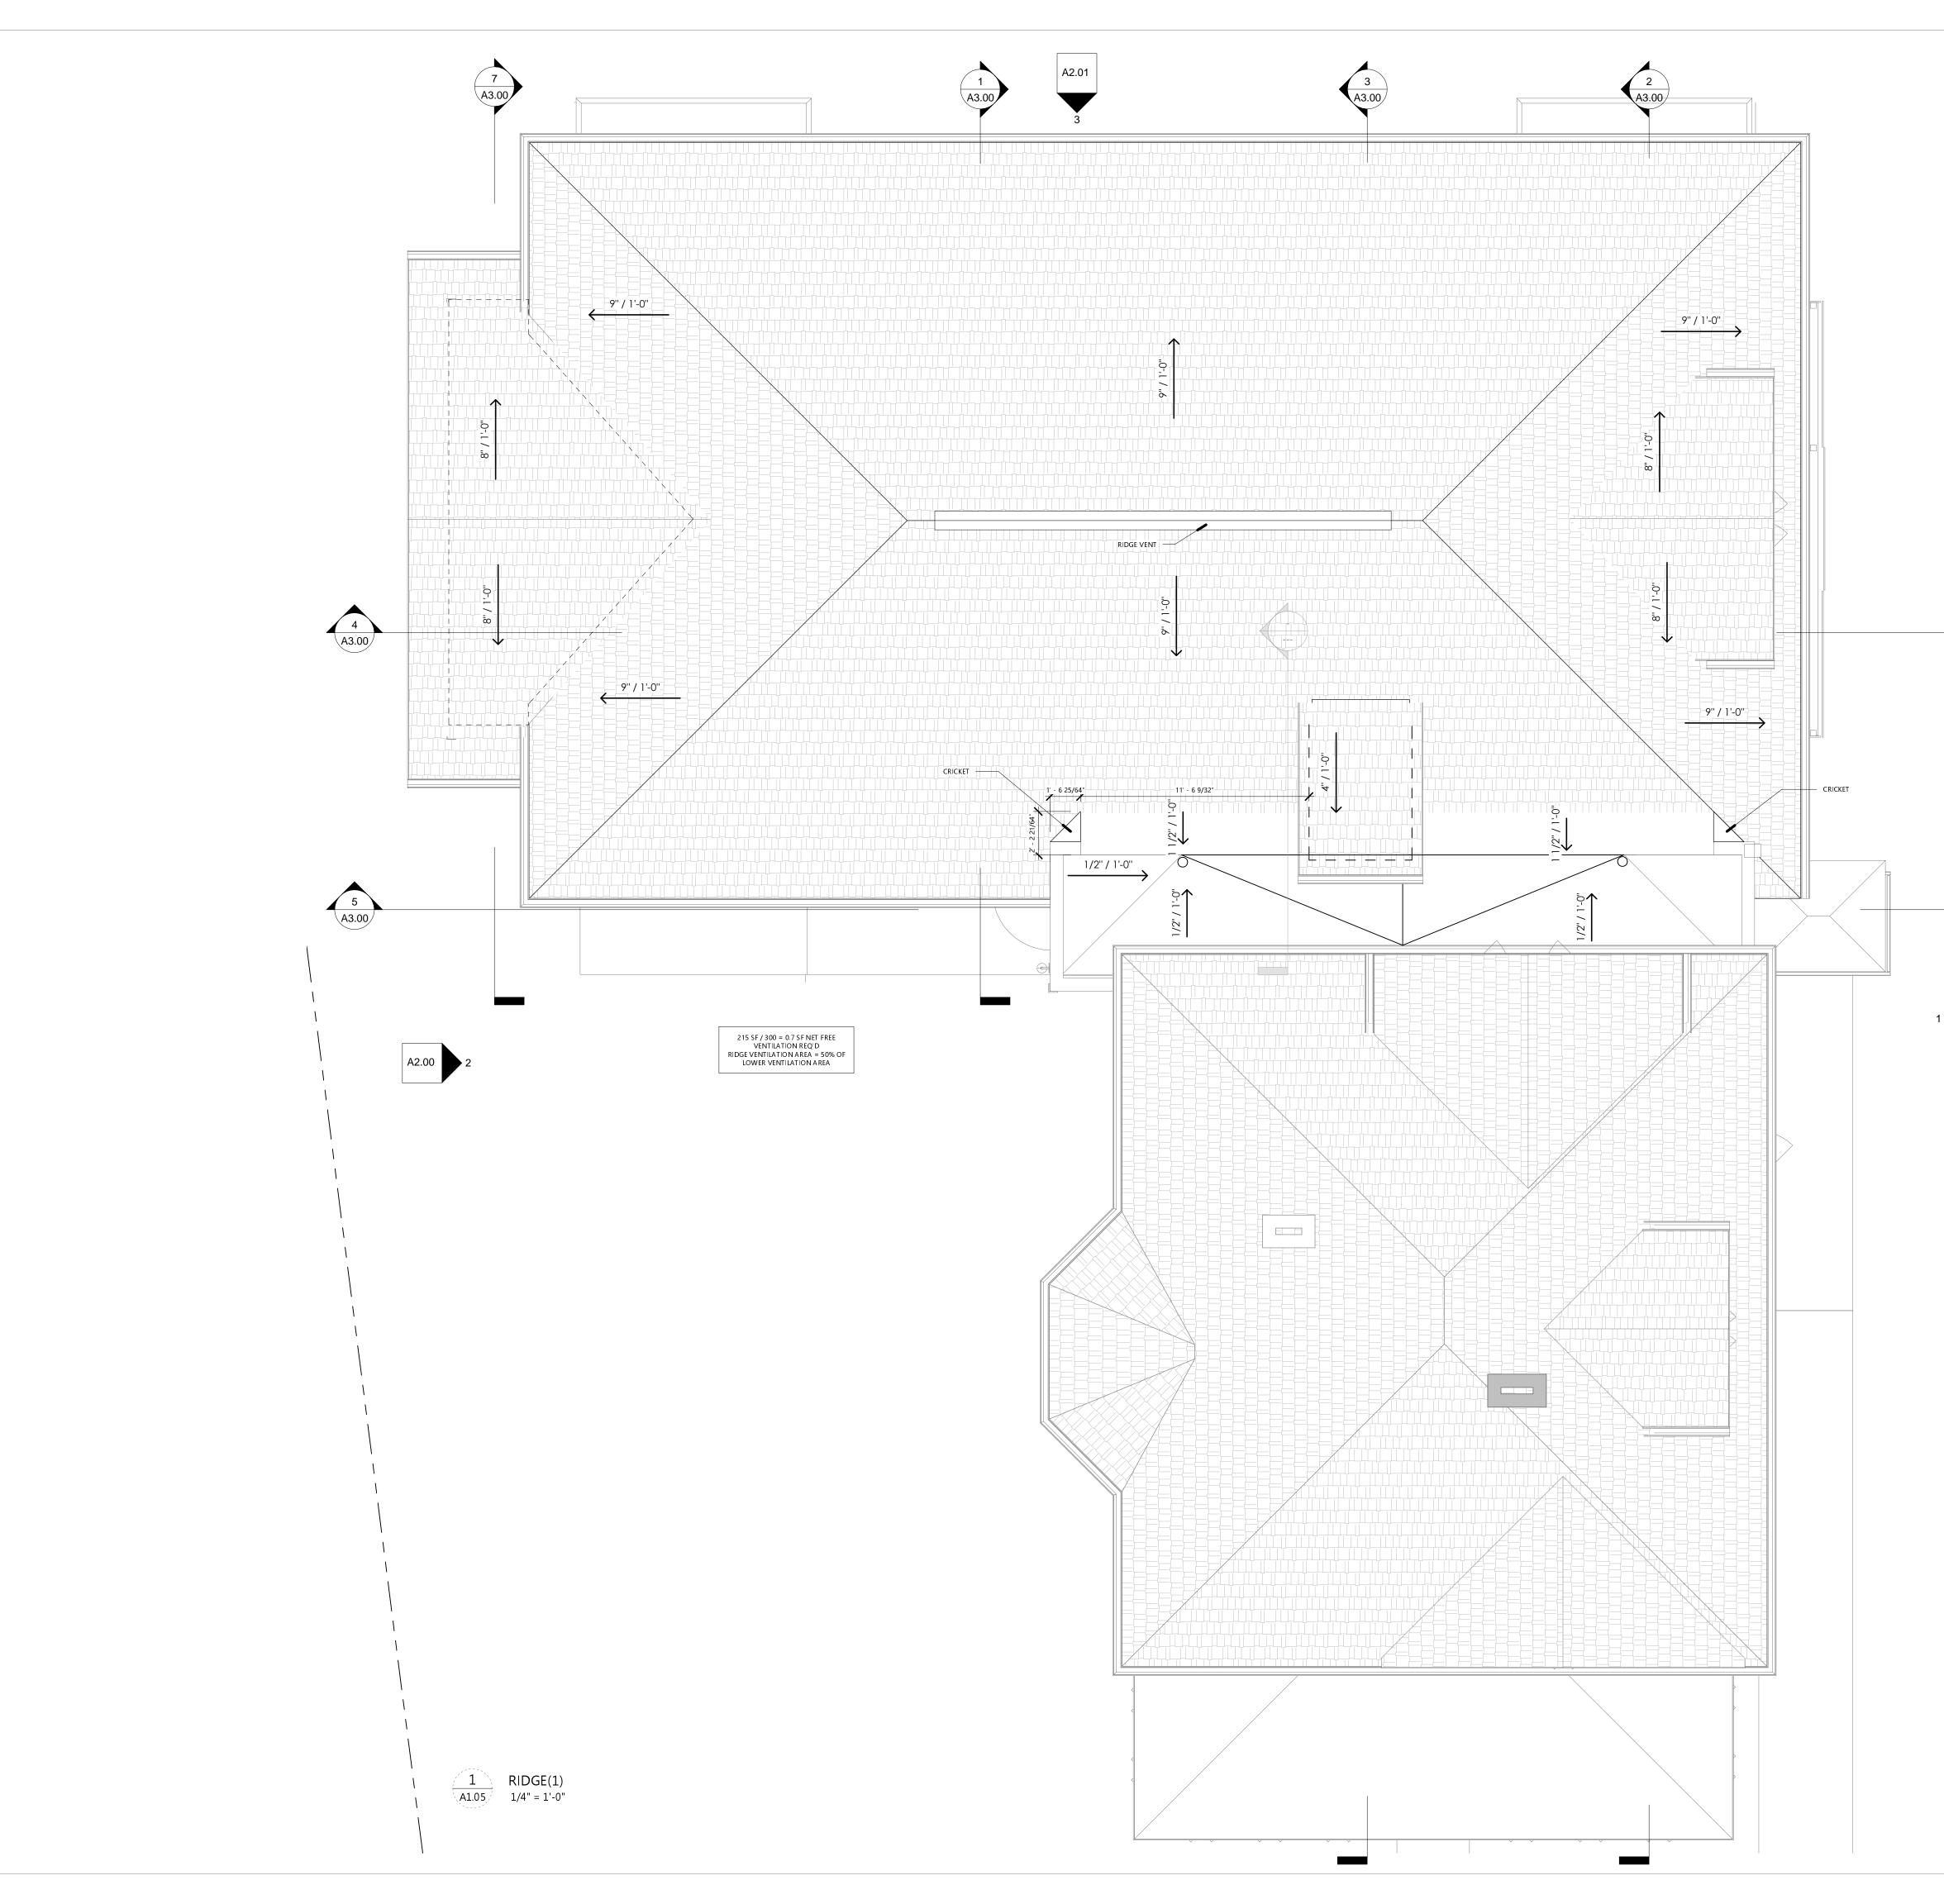
80 E OLENTANGY STREET POWELL, OHIO 43065

PROJECT NO. SJM_2010 ISSUE HDAC **ISSUE DATE** 03.29.2021

EXTG. ATTIC

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NOTE

VERIFIED IN FIELD.

NO.

GC TO PROVIDE "WARM GRAY BOX . Α. INCLUDING PLUMBING ROUGH-INS, ELECTRICAL SERVICE, TEMPORARY HEAT, LEVEL 4 FINISH ALL GWB SURFACES

FLOOR PLAN NOTES

INACCESSIBLE EXTG. CRAWL SPACE CONDITIONS TO BE

EXTG. VENTILATION OPENINGS IN CRAWL SPACE

- FOUNDATION WALL, TYP. OF (3) REMOVE EXTG. STONE MASONRY AS REQ'D TO PROVIDE A2.00
 - NEW SECURE, INSULATED CRAWL SPACE ACCESS PANEL. EXTG. SPLIT SYSTEM AHU TO REMAIN. RECONFIGURE EXTG. DUCTWORK AS REQ'D TO ACCOMODATE OVERHEAD CLEARANCE IN BASEMENT ROOM 1 AND 2 PROVIDE NEW OPENING IN EXTG. LOAD BEARING MASONRY WALL PROVIDE NEW 4" CONC. SLAB THROUGHOUT BASEMENT PROVIDE NEW 8" DOUBLE WYTHE BRICK MASONRY WALL ON 16" WIDE X 8" DEEP REINFOCED CONC. FOOTER AS INDICATED MAINTAIN AS EMERGENCY EGRESS OPENING
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 - 11 INFILL EXTG. DOOR OPENING W/ MASONRY TO MATCH EXTG. GLASS GUARDRAIL, 42" 12
 - 65 GALLON REFUSE / RECYCLING TOTES AND/OR 13 LAWNCARE AND MAINTENANCE STORAGE CONCEALED IN REFUSE ENCLOSURE 16 MAINTAIN AS EMERGENCY EGRESS OPENING





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SHEET TITLE

SHEET NO.

ISSUE

THE VENERY

80 E OLENTANGY STREET POWELL, OHIO 43065

ROOF PLAN

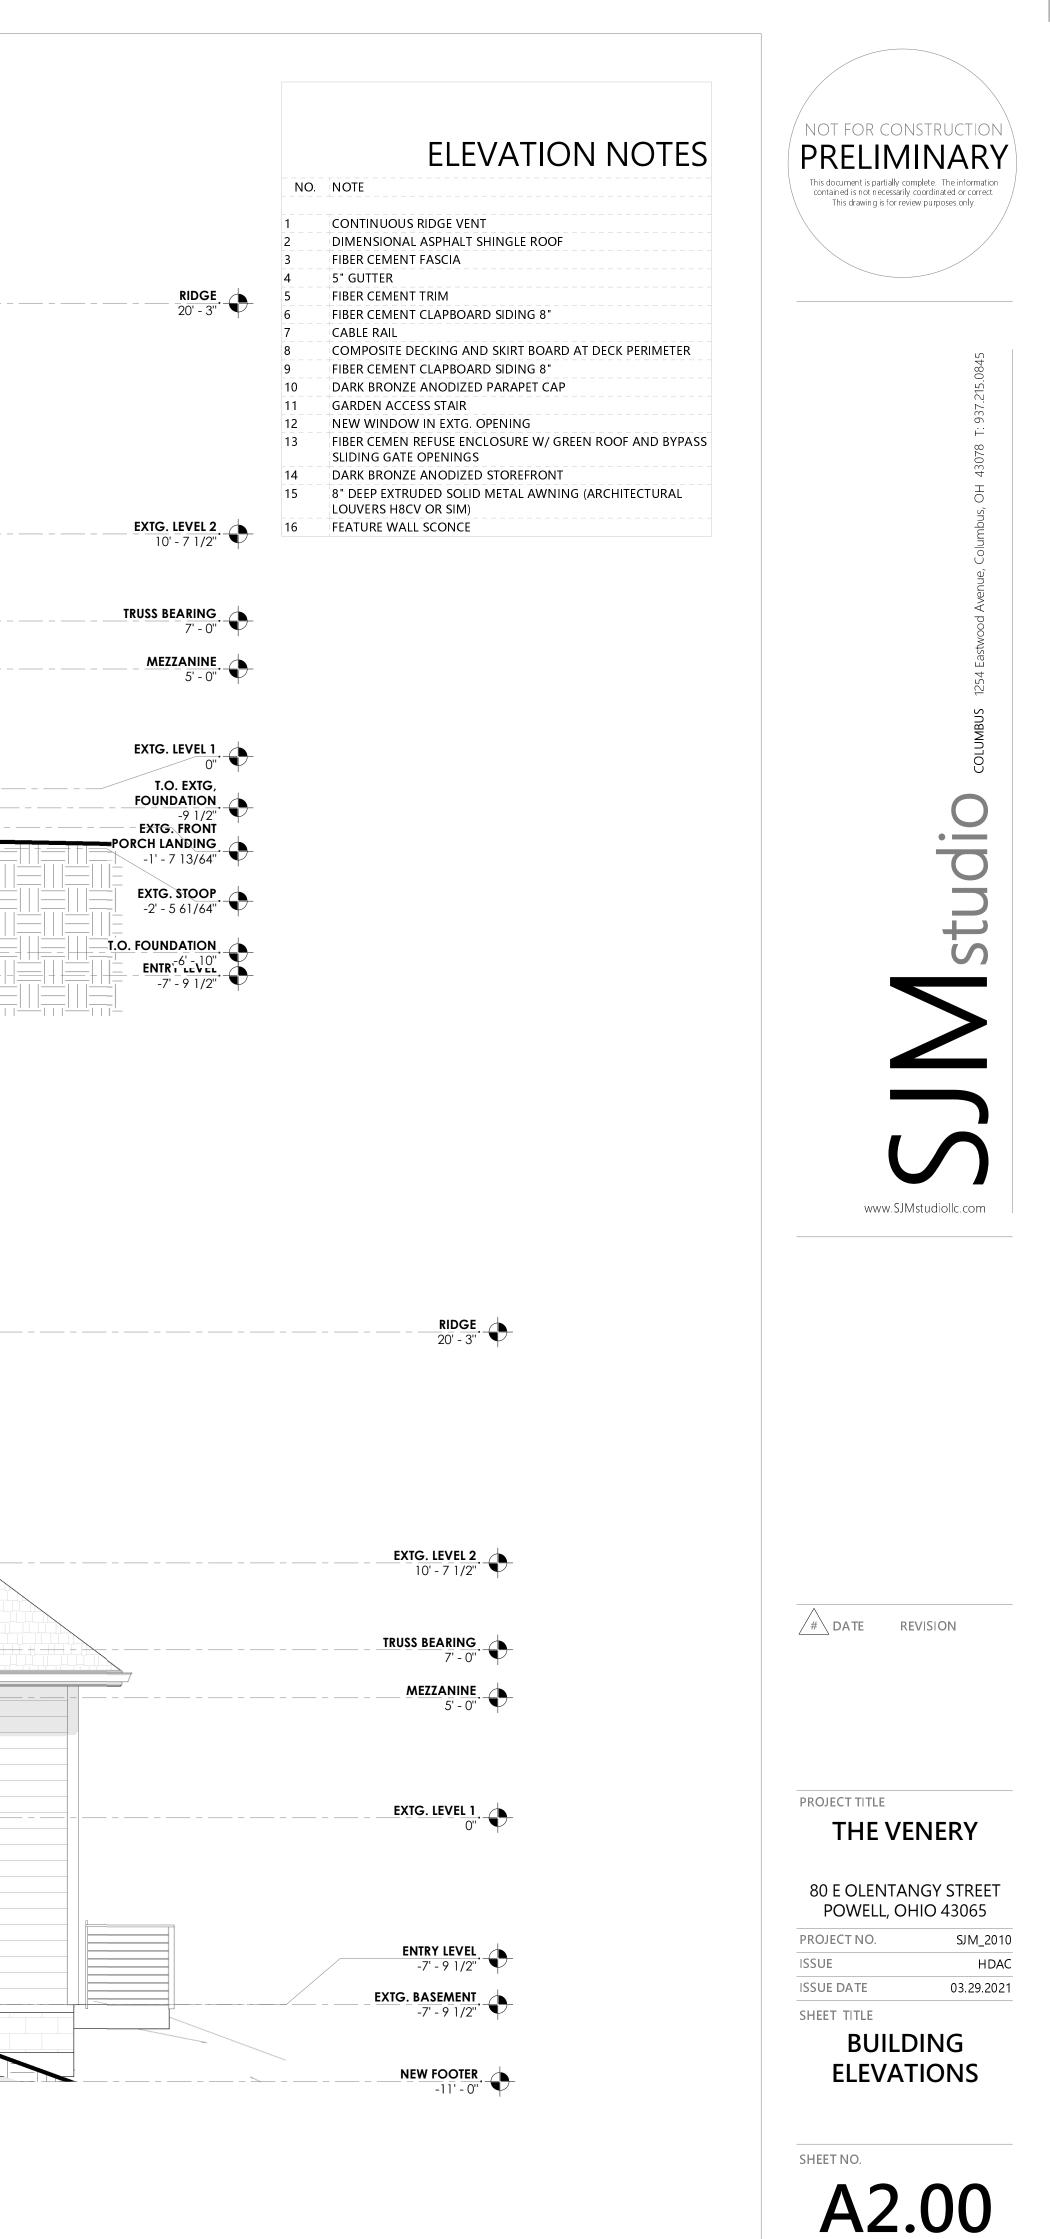
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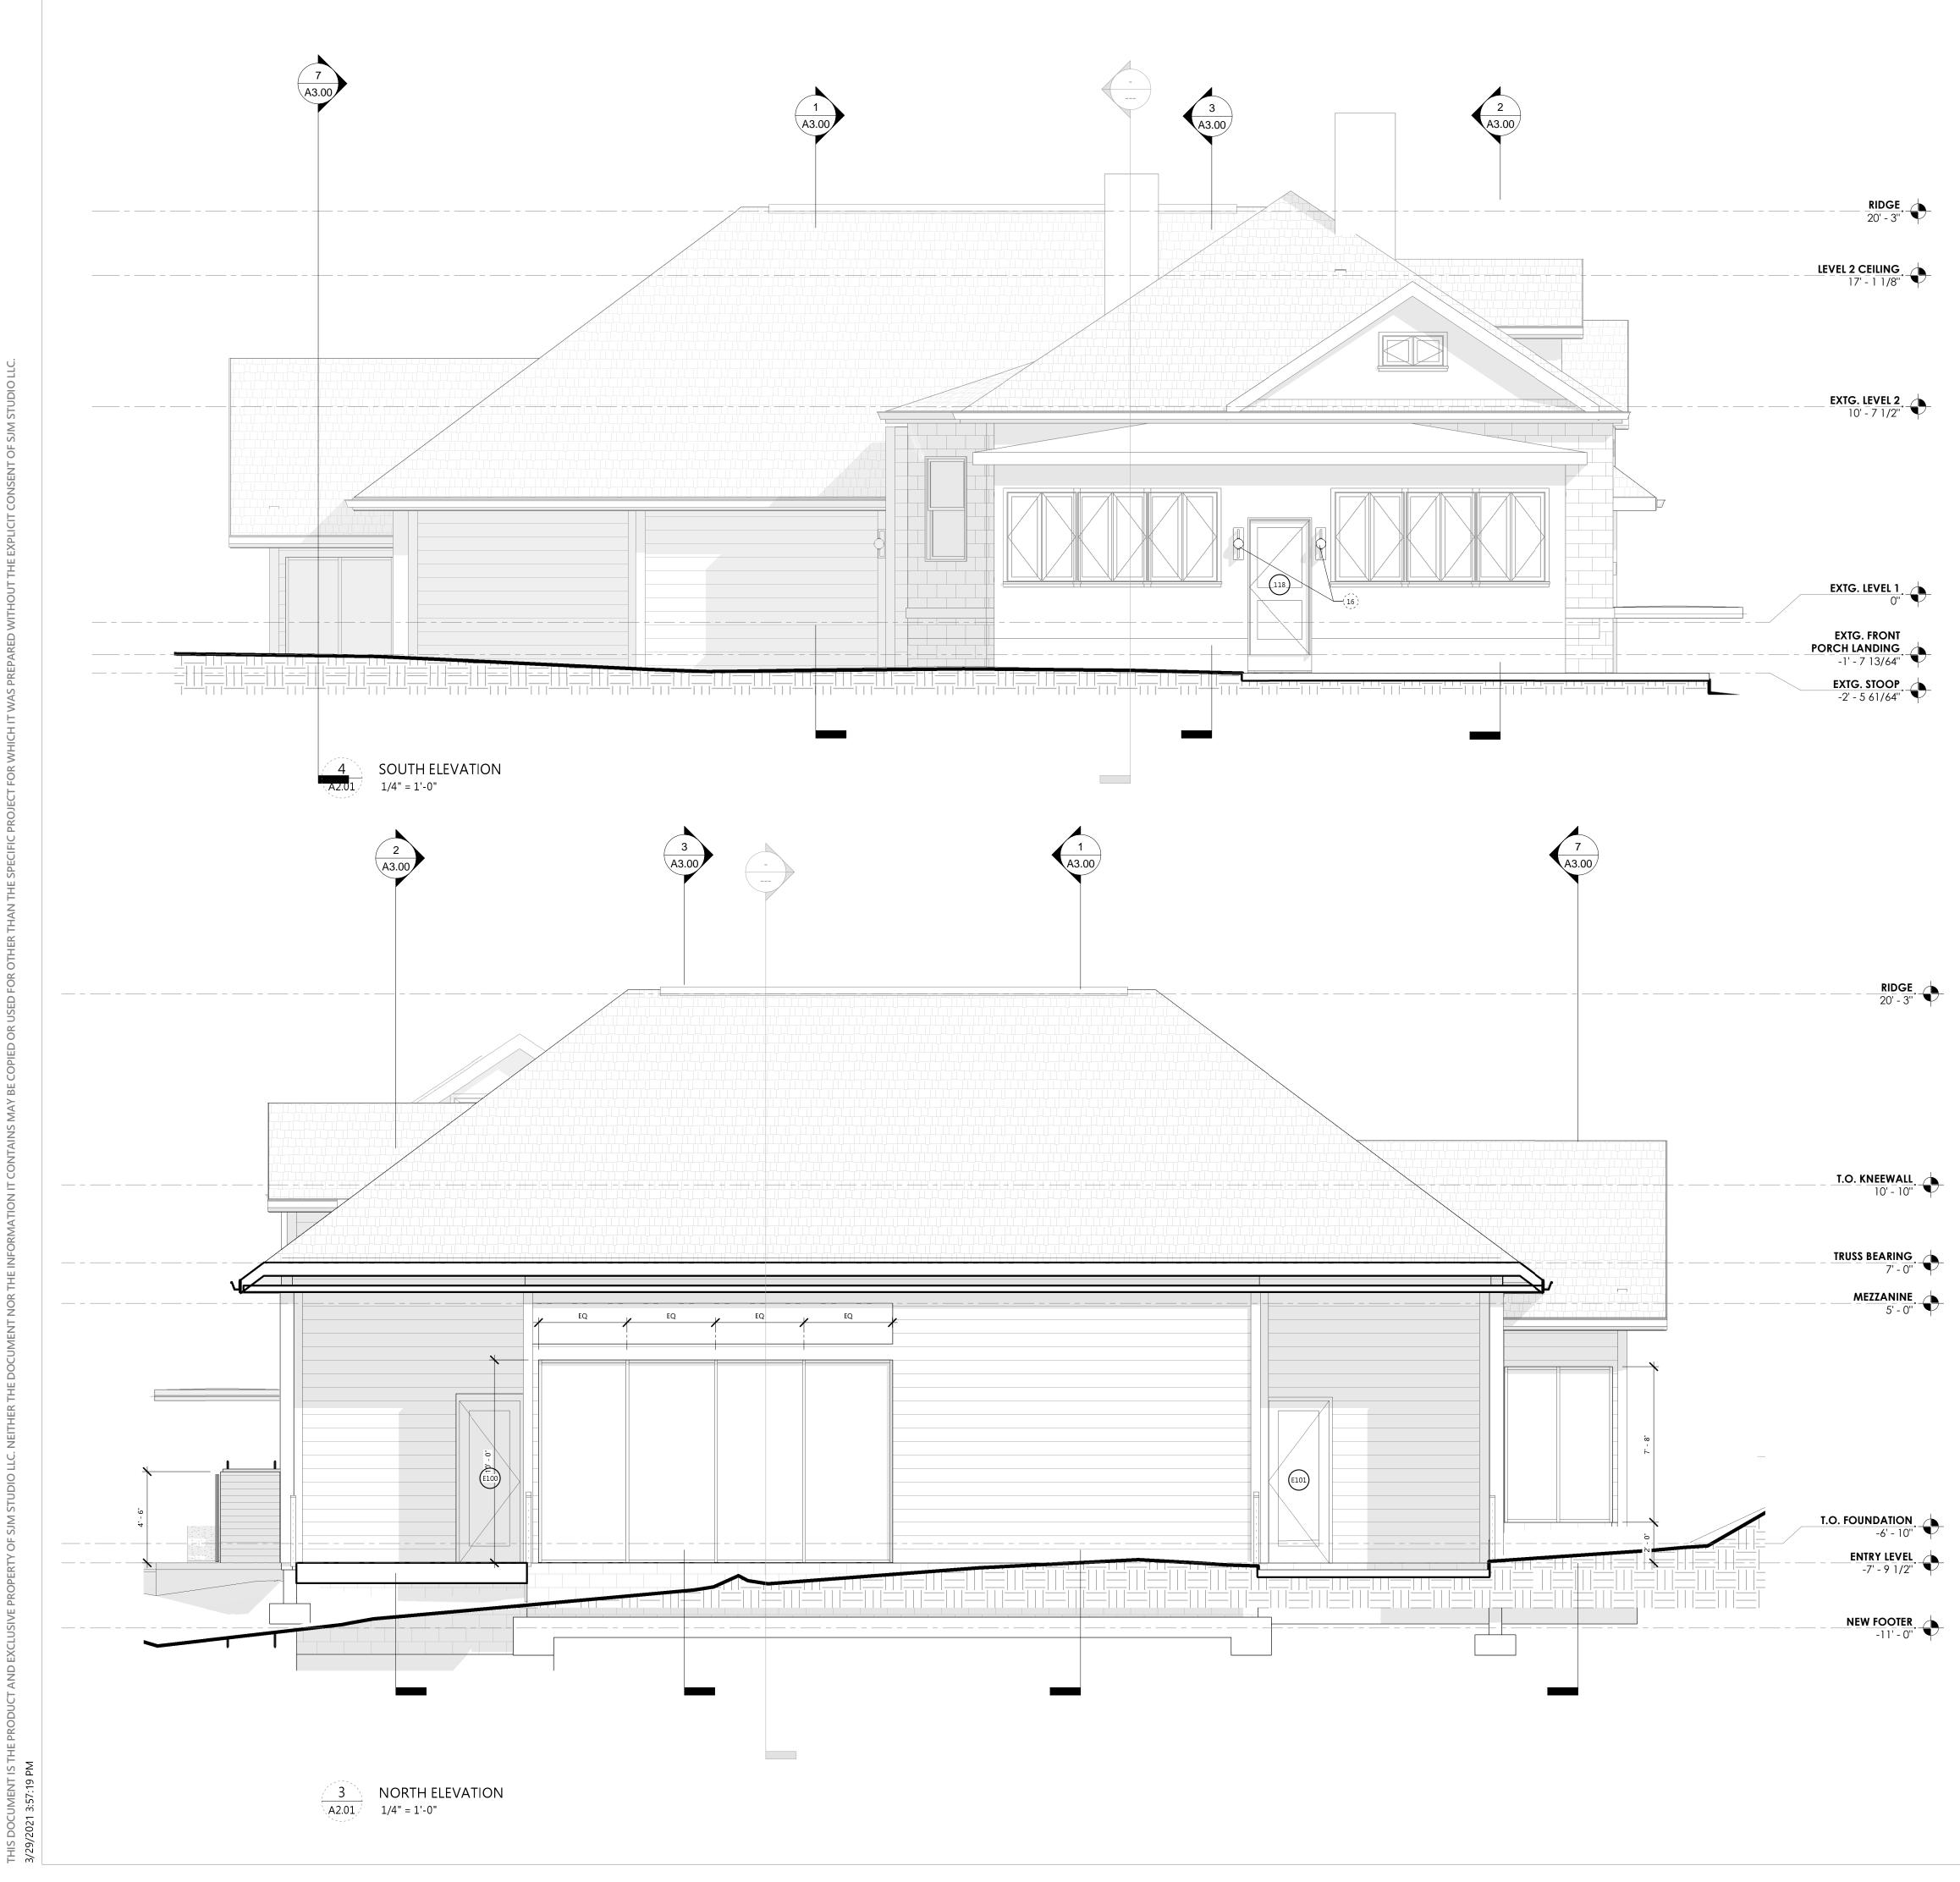
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03.29.2021





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ELEVATION NOTES		
NO.	NOTE	
1	CONTINUOUS RIDGE VENT	
2	DIMENSIONAL ASPHALT SHINGLE ROOF	
3	FIBER CEMENT FASCIA	
4	5" GUTTER	
5	FIBER CEMENT TRIM	
6	FIBER CEMENT CLAPBOARD SIDING 8"	
7	CABLE RAIL	
8	COMPOSITE DECKING AND SKIRT BOARD AT DECK PERIMETER	
9	FIBER CEMENT CLAPBOARD SIDING 8"	
10	DARK BRONZE ANODIZED PARAPET CAP	
11	GARDEN ACCESS STAIR	
12	NEW WINDOW IN EXTG. OPENING	
13	FIBER CEMEN REFUSE ENCLOSURE W/ GREEN ROOF AND BYPASS SLIDING GATE OPENINGS	
14	DARK BRONZE ANODIZED STOREFRONT	
15	8" DEEP EXTRUDED SOLID METAL AWNING (ARCHITECTURAL LOUVERS H8CV OR SIM)	
16	FEATURE WALL SCONCE	





PROJECT NO. ISSUE ISSUE DATE SHEET TITLE

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80 E OLENTANGY STREET POWELL, OHIO 43065

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RENDERINGS

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PROJECT NO.	SJM_2010
ISSUE	HDAC
ISSUE DATE	03.29.2021
SHEET TITLE	



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RENDERINGS

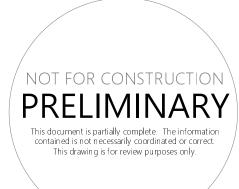
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EXTERIOR LIGHTING



PATH LIGHTING





MAIN ENTRANCE CHANDELIER

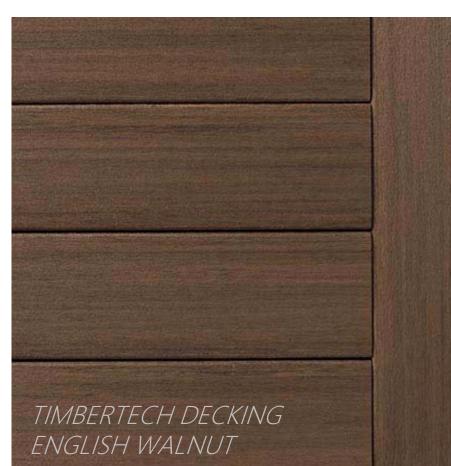
SCONCE







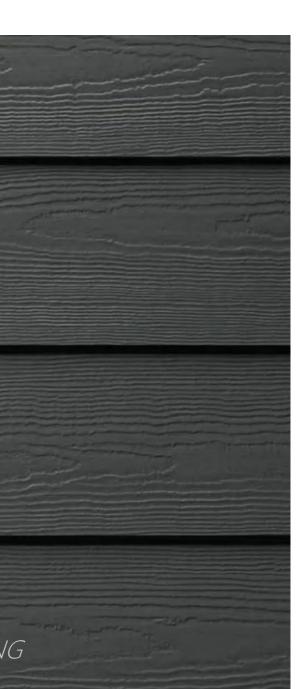






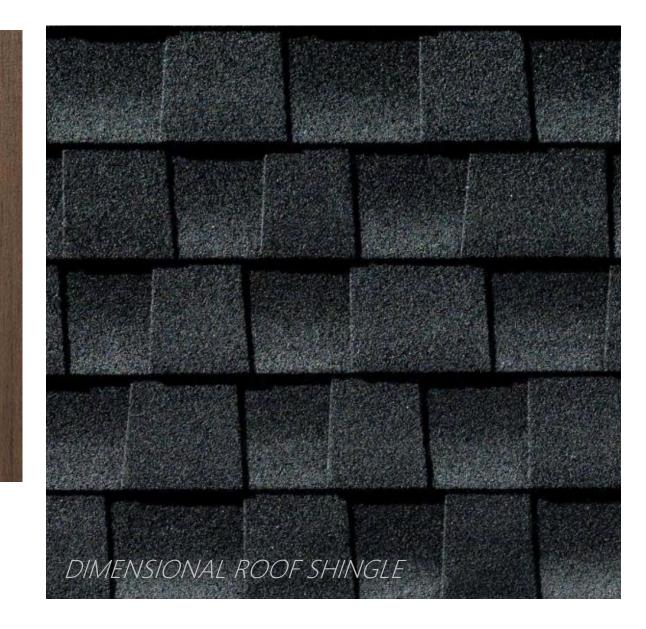
DARK BRONZE STOREFRONT ALUMINUM

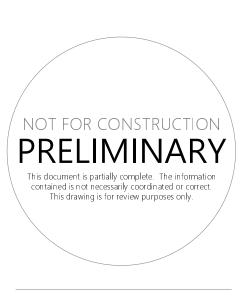




SHERWIN WILLIAMS DARK NIGHT

SHERWIN WILLIAMS MOUNT ETNA







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THE VENERY

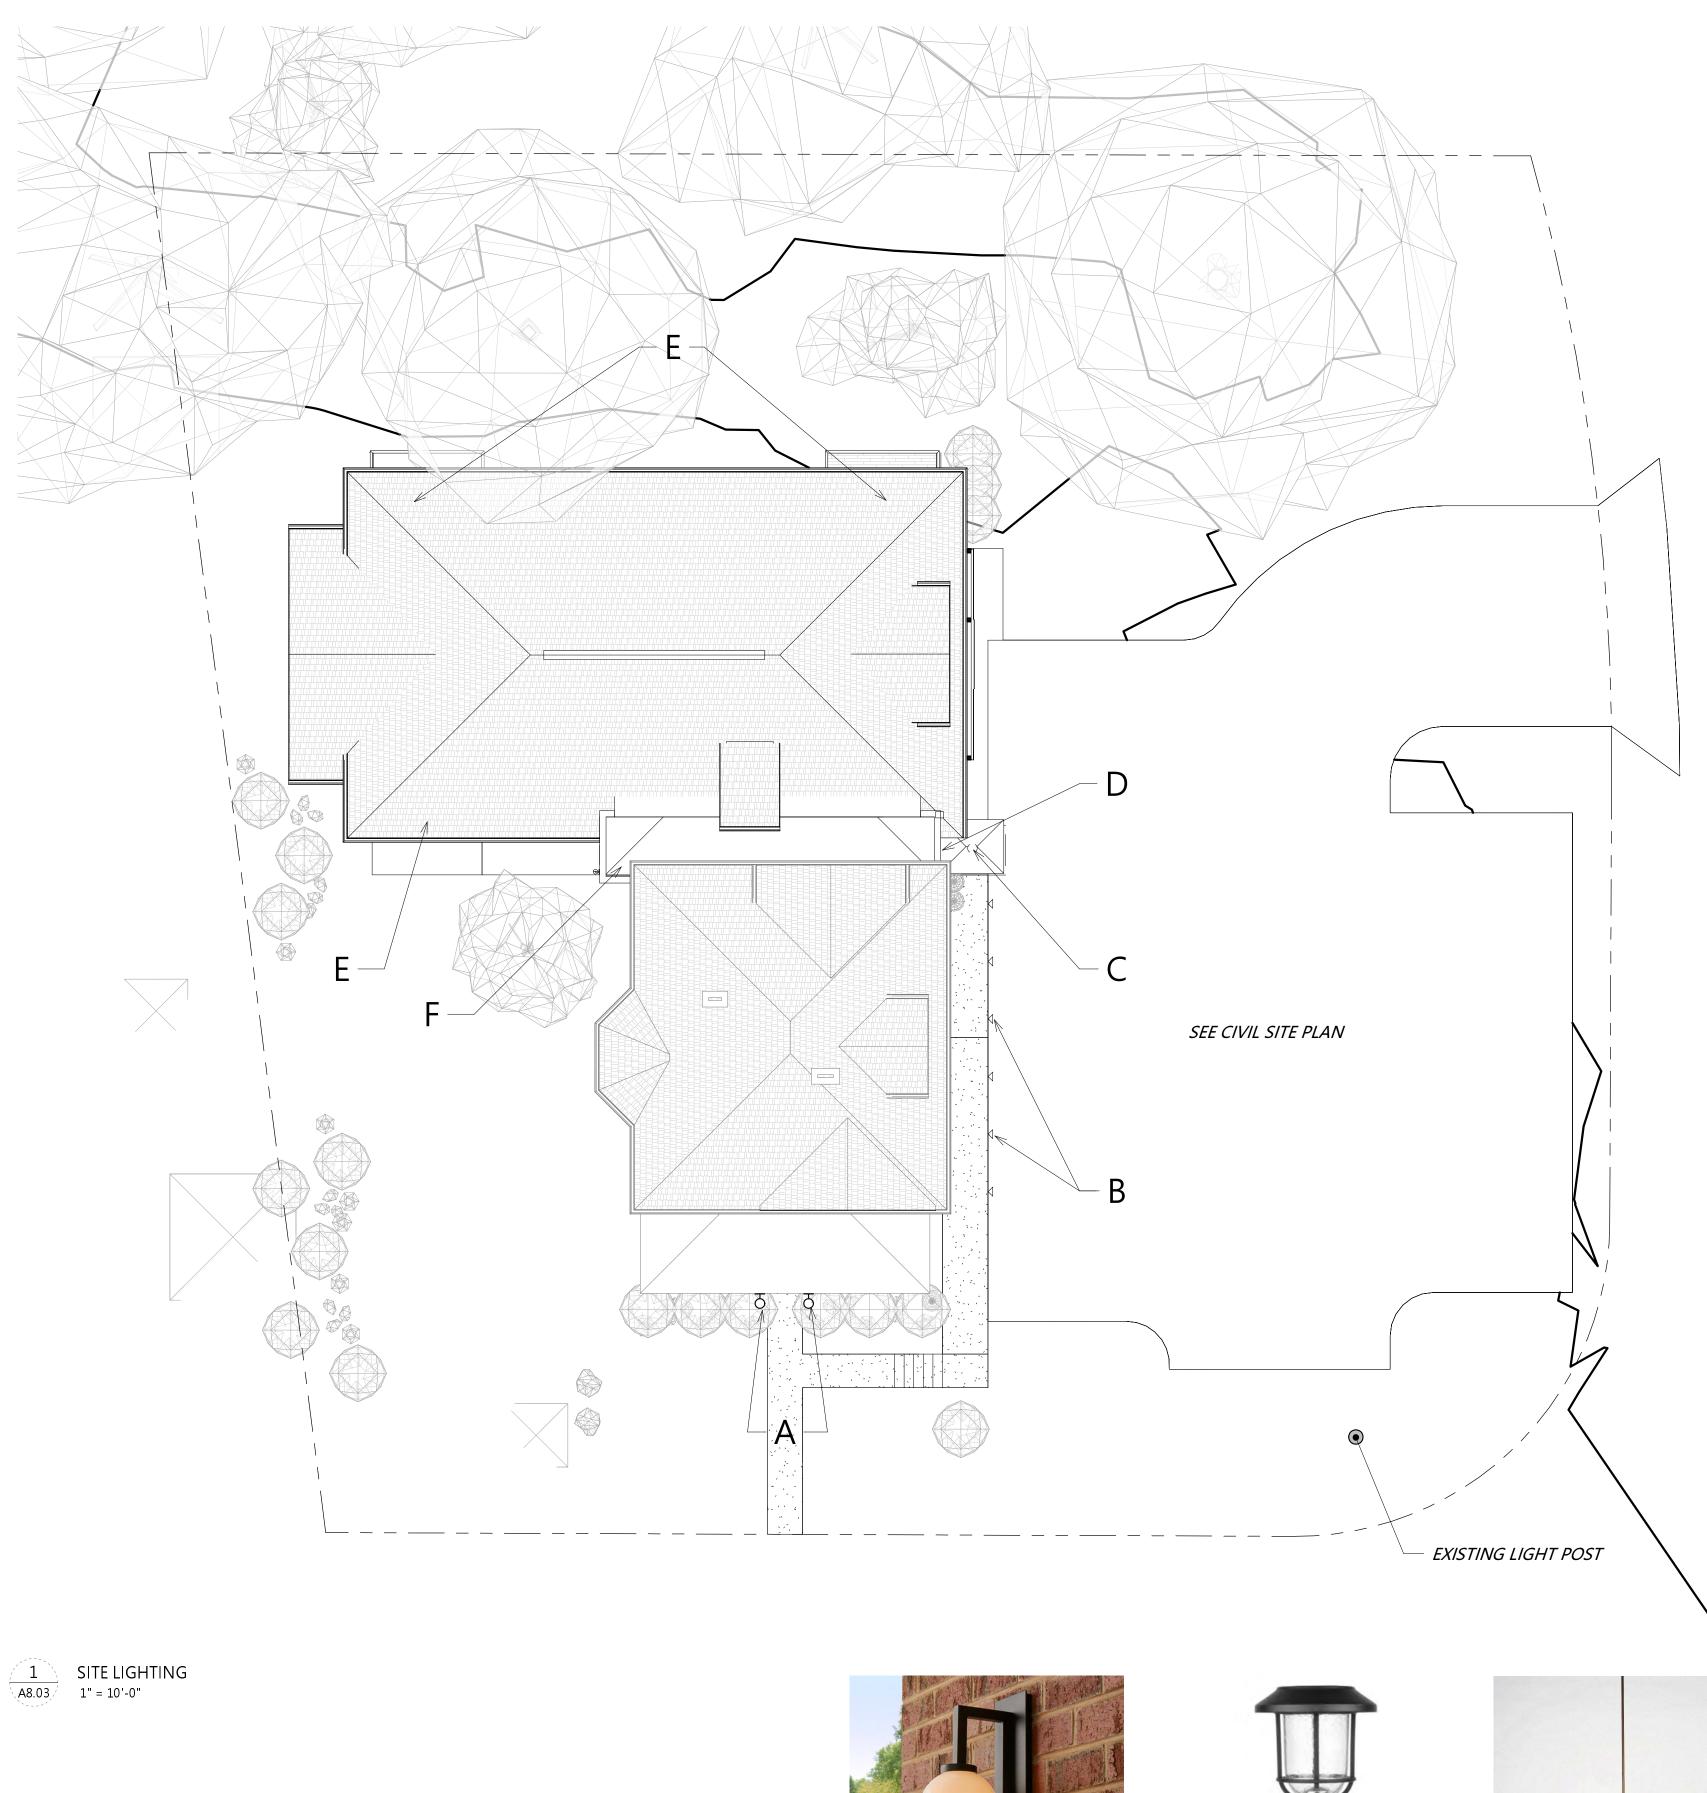
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03/29/21

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SHEET NO. A8.02



FEATURE WALL SCONE

R

A, F



PATH LIGHTING FEATURE CHANDELIER IN VESTIBULE, D

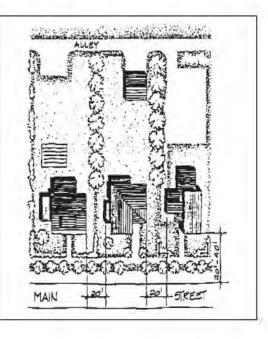
POWELL ARCHITECTURAL GUIDELINES LIGHTING

Setbacks

Most buildings in Powell are set back approximately 20 to 40 feet from the road with modest front lawns. The exceptions are the commercial buildings at the corner of Olentangy and Liberty Streets, which are built right up to their property lines at the sidewalks. Rear yards are generally long and narrow. Residential buildings on adjacent lots throughout the City are set approximately 20 feet apart from each other at their sides. New construction should follow the setback lines appropriate to its location and purpose.

Lighting

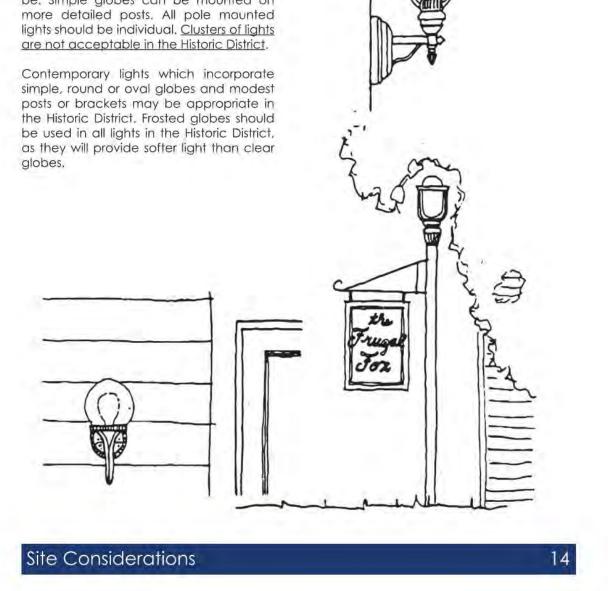
One of the charms of rural areas is the complete darkness of nightfall away from the 24 hour light of the city. However, proper lighting fixtures can increase the safety of Powell, and may become more necessary as development continues. Exterior lighting in the Historic District should be incandescent, and low in wattage. Entrance lights and individual free standing path lights are acceptable. Lighting fixtures should be simple Victorian or turn of the century in design, with round or egg-shaped globes on metal posts with minimal detailing.



Colonial style "coach lights" are not appropriate in the Historic District. These types belong to an earlier historical period, and generally belong on coaches.

Site Considerations

Free standing, pole mounted lamps may be used to light paths or drives. These lights should not be taller than the height of the first story of adjacent buildings. Metal posts should be painted in dark, muted colors such as black, brown, or dark green. The more elaborate the shape of the globe, the simpler the detailing of the post should be. Simple globes can be mounted on more detailed posts. All pole mounted lights should be individual. <u>Clusters of lights</u> are not acceptable in the Historic District.





- A FEATURE WALL SCONCE
- B PATH LIGHTING
- C RECESSED EXTERIOR CAN LIGHT IN AWNING
- D FEATURE HANGING CHANDELIER
- RECESS EXTERIOR CAN LIGHTS IN DECK OVERHANGS
- F FEATURE WALL SCONCE





ISSUE



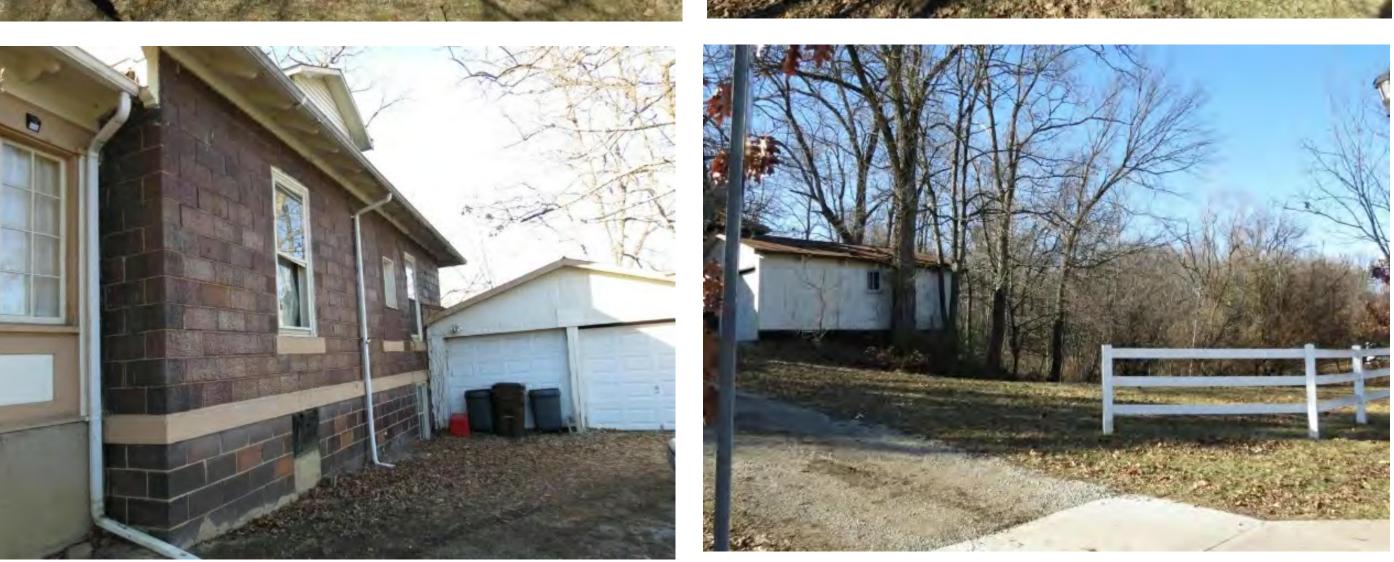
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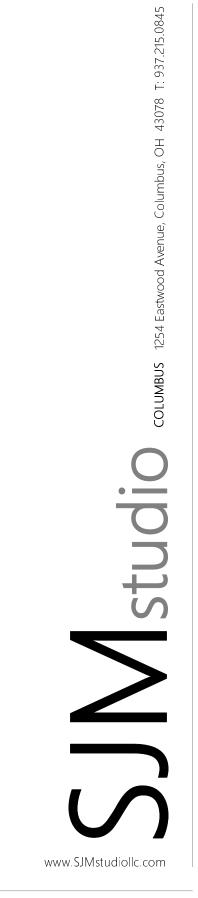
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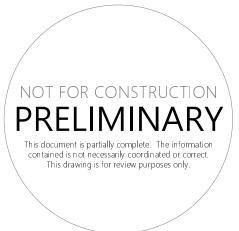


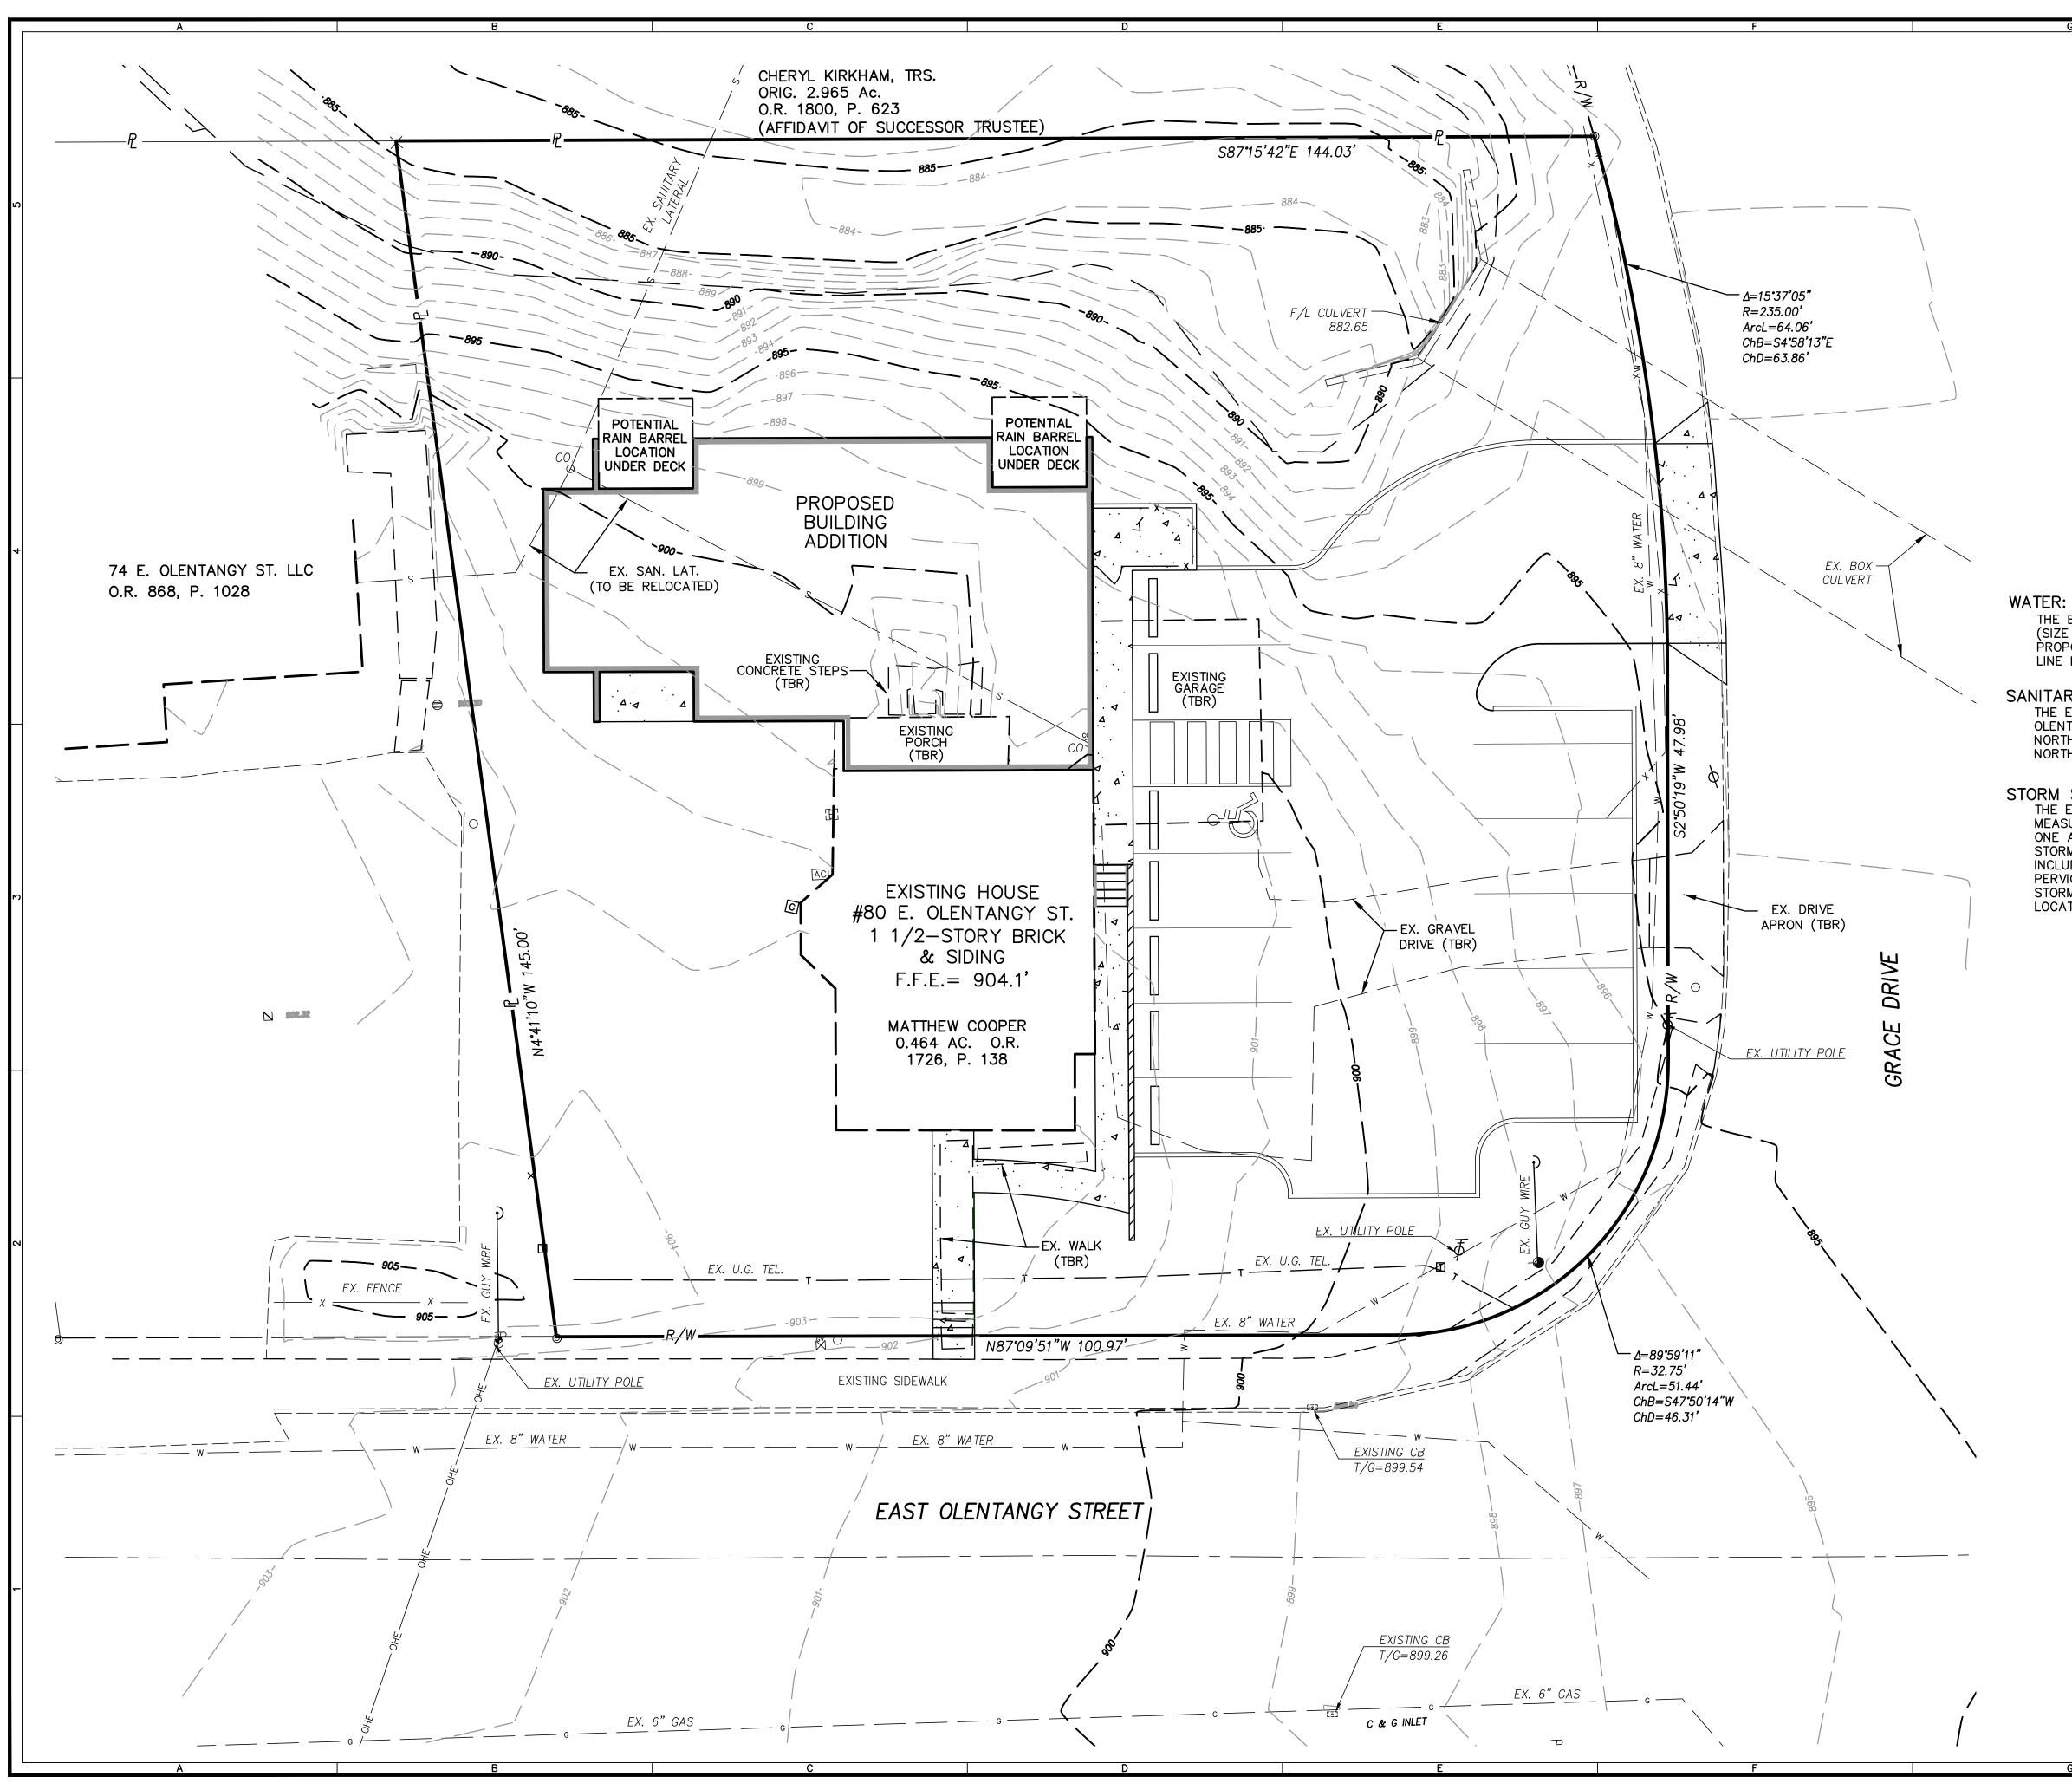
PROJECT TITLE

DATE REVISION









APPLICANT:

GOOD NIGHT INVESTMENTS LLC 42 MACDUFF WAY DUBLIN, OH 43016 CONTACT: GRETCHEN BONASERA PHONE: (614) 477-8030 GRETCHEN@GÓODNIGHTINVESTMENTS.COM

ENGINEER:

IBI GROUP 8101 NORTH HIGH ST. SUITE 100 COLUMBUS, OH 43235 CONTACT: ERIC CHENEVEY PHONE: (614) 818-4900 x2041 FAX: (614) 818-4901 ERIC.CHENÉVEY@BIGROUP.COM

ARCHITECT:

SJM STUDIOS 1254 EASTWOOD AVE COLUMBUS, OH 43203 CONTACT: SARAH MACKERT PHONE: (937) 215-0845 SJM@SJMSTUDIOLLC.COM

PROPOSED UTILITY SERVICES

THE EXISTING BUILDING IS SERVED BY A DEL-CO WATER SERVICE LINE (SIZE UNKNOWN BY DEL-CO WATER). IF AN UPGRADE IS NEEDED, THE PROPOSED IMPROVEMENT WILL CONNECT TO THE EXISTING 8" WATER LINE LOCATED ALONG THE NORTH SIDE OF E. OLENTANGY STREET.

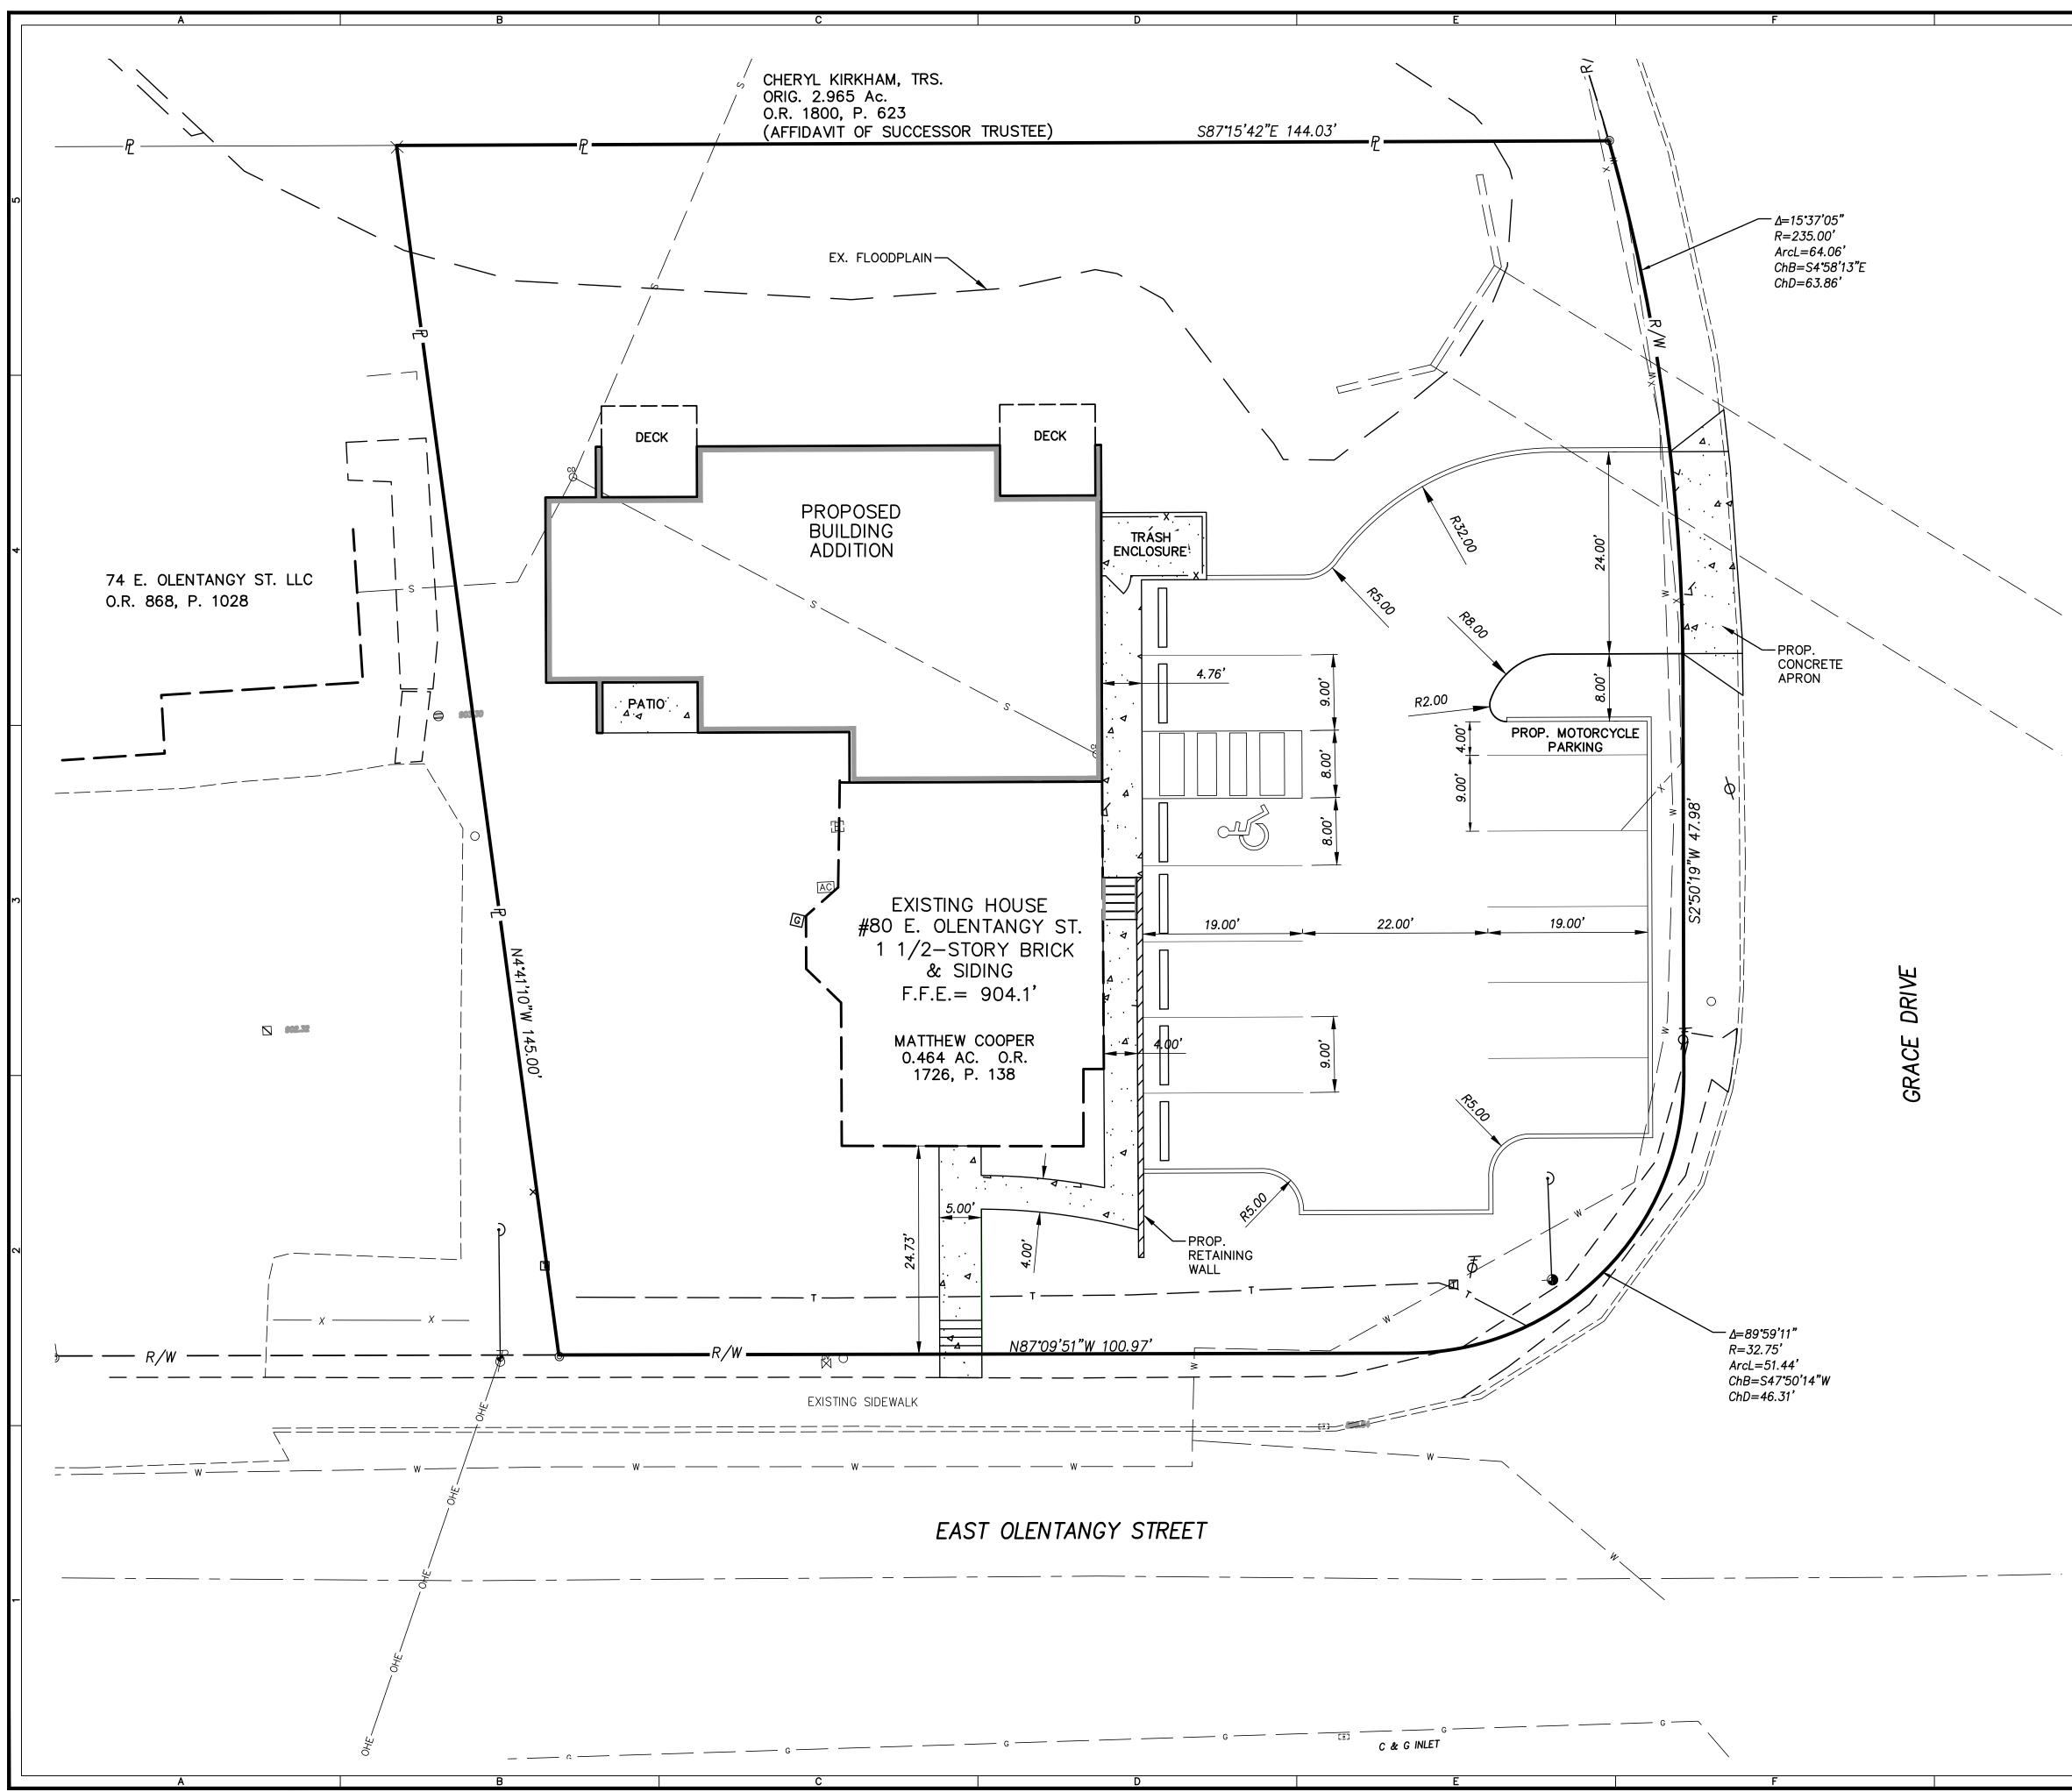
SANITARY SEWER:

THE EXISTING BUILDINGS LOCATED AT 74 E. OLENTANGY STREET & 80 E. OLENTANGY STREET BOTH CONNECT TO A CLEANOUT LOCATED NEAR THE NORTHWEST PROPERTY CORNER. FROM THIS POINT, SANITARY FLOW HEADS NORTHEAST AND CONNECTS TO AN EXISTING 12" SANITARY SEWER.

STORM SEWER:

THE EXISTING SITE DOES NOT CONTAIN ANY STORM WATER DETENTION MEASURES. THE PROPOSED IMPROVEMENTS WILL DISTURB LESS THAN ONE ACRE, THEREFORE NO WATER QUALITY MEASURES ARE NEEDED. STORM WATER DETENTION MEASURES BEING CONSIDERED FOR THIS SITE INCLUDE, BUT ARE NOT LIMITED TO RAIN BARRELS, RAIN GARDENS, PERVIOUS PAVEMENT AND/OR UNDERGROUND STORAGE CHAMBERS. THE STORM IMPROVEMENTS WILL DISCHARGE INTO THE EXISTING CHANNEL LOCATED ON THE NORTH SIDE OF THE PROPERTY.

Q	GRAPHIC SCALE $10 5 0 10$ $(IN FEET)$ $1 inch = 10 ft.$
4	IBI GROUP 8101 North High Street Suite 100 Columbus OH 43235 tel 614 818 4900 fax 614 818 4902 Contact: Eric Chenevey Ext: 2041 ibigroup.com
	REVISION:
	SUBMISSION:
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	80 E. OLENTANGY ST.
	POWELL, OH 43065 DESIGN DRAFT CHECK
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	133470 DATE: MARCH 5, 2021
	SCALE:
_	SHEET TITLE:
	PRELIMINARY UTILITY PLAN
	SHEET NO.: $1/3$



5	GRAPHIC SCALE $(IN FEET)$ $(IN FEET)$ $(In FEET)$ $(In FEET)$ $(In FEET)$
4	IBI GROUP 8101 North High Street Suite 100 Columbus OH 43235 tel 614 818 4900 fax 614 818 4902 Contact: Eric Chenevey Ext: 2041 ibigroup.com
3	SUBMISSION:
	PRELIMINARY ENGINEERING SET AGENCY REVIEW SET CONSTRUCTION DOCUMENT SET AS-BUILT DOCUMENT SET STAMP:
	NOT FOR CONSTRUCTION
2	DELAWARE COUNTY THE VENERY 80 E. OLENTANGY ST. POWELL, OH 43065
	DESIGN DRAFT CHECK LS LS EPC IBI NO.: 133470
1	DATE: MARCH 5, 2021 SCALE: SHEET TITLE:
	PRELIMINARY SITE PLAN
	SHEET NO.: 2/3

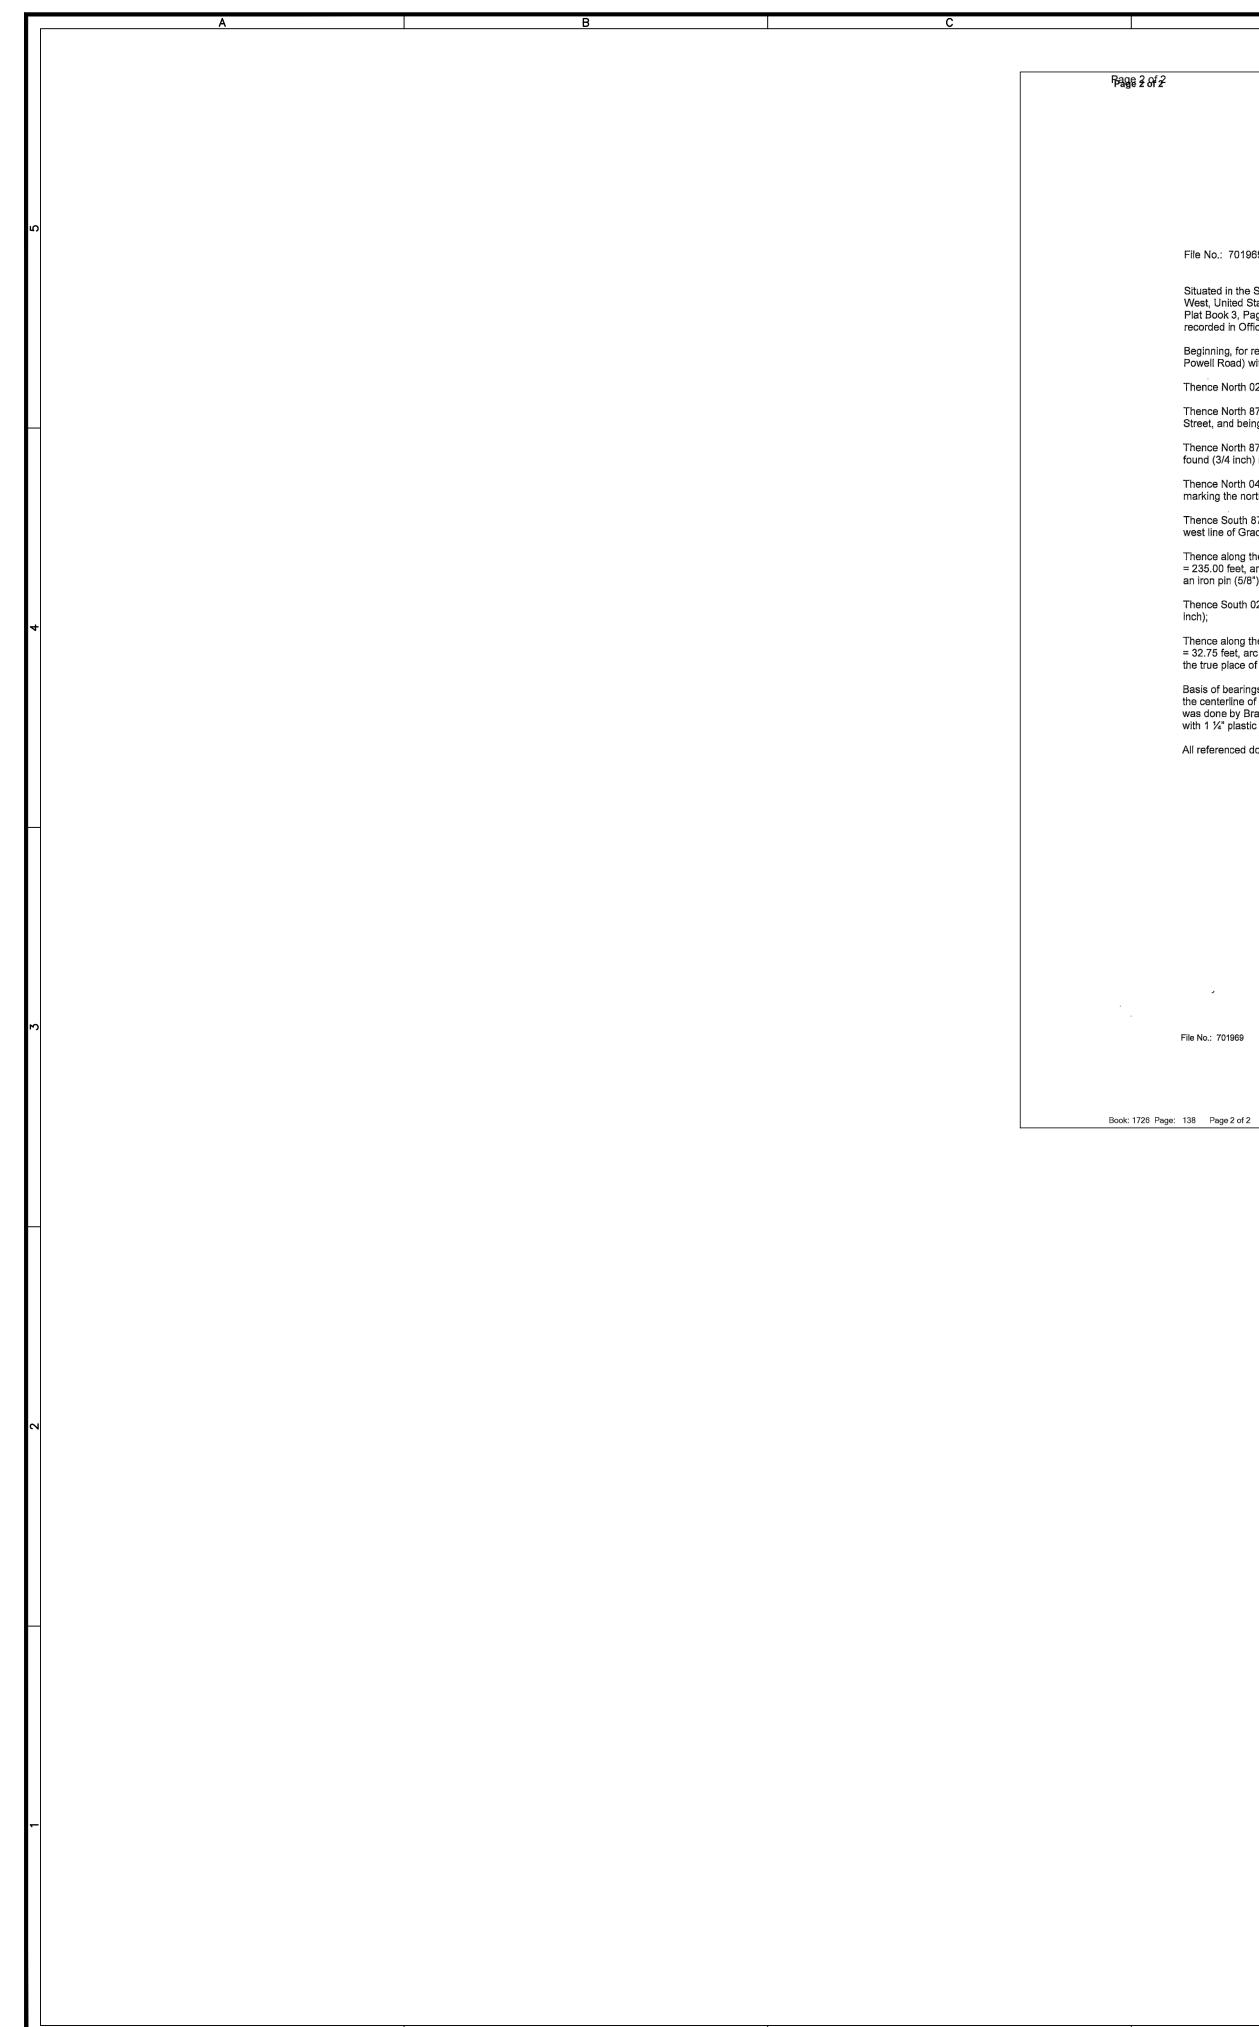


EXHIBIT "A" LEGAL DESCRIPTION

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File No.: 701969

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Situated in the State of Ohio, County of Delaware, City of Powell, Section 4, Township 3 North, Range 19 West, United States Military Lands, and being part of OutLots 7, 8 & 9 of Case's Addition, as recorded in Plat Book 3, Page 99 and part of a 3.429 acre tract presently owned by Charles F. Dorton Trustee, as recorded in Official Record 761, Page 2104, and being more particularly described as follows:

Beginning, for reference, at a point marking the intersection of the centerlines of E. Olentangy Street (E. Powell Road) with Grace Drive, as shown on Plat Cabinet 2, Slide 778;

Thence North 02° 50' 09" East 27.25 feet, along the centerline of Grace Drive, to a point; Thence North 87° 09' 51" West 57.75 feet, to an iron pin found (5/8 inch) in the north line of E. Olentangy

Street, and being the TRUE POINT OF BEGINNING of the herein described tract;

Thence North 87° 10' 01" West 100.97 feet, along the north line of E. Olentangy Street, to an iron pin found (3/4 inch) marking the southeast corner of Lot 131 of said Case's Addition; Thence North 04° 41' 20" West 145.00 feet, along the east line of Lot 131, to an iron pin found (3/4 inch)

marking the northeast corner of Lot 131; Thence South 87° 15' 52" East 144.03 feet, across said 3.429 acre tract, to an iron pin (5/8") set in the

west line of Grace Drive;

Thence along the arc of a curve to the right and west line of Grace Drive, delta angle = 15° 37' 05", radius = 235.00 feet, arc length = 64.06 feet, chord bearing and distance of South 04° 58' 24" East 63.86 feet, to an iron pin (5/8") found;

Thence South 02° 50" 09" West 47.98 feet, along the west line of Grace Drive, to an iron pin found (3/4 inch);

Thence along the arc of a curve to the right and west line of Grace Drive, delta angle = 89° 59' 50", radius = 32.75 feet, arc length = 51.44 feet, chord bearing and distance of South 47° 50' 04" West 46.31 feet, to the true place of beginning, counting 0.464 acres.

Basis of bearings from GPS Observation, Ohio State Plane Coordinate System (North Zone), based on the centerline of Grace Drive being South 19° 47' 35" East. A survey of the above described premises was done by Bradley J. Patridge, P.S. 7068, in October, 2012. All iron pins set are 5/8" rebar, 30" long, with 1 ¼" plastic caps stamped "Patridge Surveying".

All referenced documents are on file at the Delaware County Recorder's Office, Delaware, Ohio.

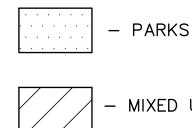


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VICINITY MAP 1"=80'

- PARKS & RECREATION

- MIXED USE & COMMERCIAL BUILDINGS

5	$GRAPHIC SCALE$ $M = 40 0 \qquad 80$ $(IN FEET)$ $1 inch = 40 ft.$
4	IBIGROUP 8101 North High Street Suite 100 Columbus OH 43235 tel 614 818 4900 fax 614 818 4902 Contact: Eric Chenevey Ext: 2041 ibigroup.com
	SUBMISSION:
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	VICINITY MAP & LEGAL DESCRIPTION
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