

### PLANNING AND ZONING COMMISSION (P&Z) PRELIMINARY DEVELOPMENT PLAN APPLICATION

ALL ITEMS ON THIS APPLICATION MUST BE COMPLETED.

Application Fee: \$500.00 + \$100.00 per acre Per Fee Ordinance 2019-49

Applicant:				
Address/City/State/Zip:				
Email Address:				
Phone No:	Cell Phone No:	Fax No:		
Property Owner:				
Address/City/State/Zip:				
Email Address:				
Phone No:	Cell Phone No:	Fax No:		
Architect/Designer for Applicant:				
Address/City/State/Zip:				
Email Address:				
Phone No:	Cell Phone No:	Fax No:		
Property Address:				
Lot Number/Subdivision:	Existing Use:	Proposed Use:		
Reason for Administrative Review (attach	necessary documents):			
Checklist:				
☐ Preliminary Plan requirements set forth	in Section <u>1143.11(c)</u> .			
☐ Provide any other information that may	be useful to the Planning and Zoning Com	nmission or City Staff in the space		
below or attach additional pages.				
☐ <b>5 copies</b> of all drawings, text, any othe	r items, and application.			
□ 1 digital copy (CD, USB, Email) of the complete application packet.				
☐ Attach the required fee - \$500.00 + \$100.00 per acre.				
□ Post a public notice sign at least (10) days prior to a public hearing or public meeting, pursuant to ordinance 1107.035				
Public notice sign details found here.				

(SEE OVER)

I agree to grant the City Staff, the Commission, Board or Council considering this application access to the property that is the subject of this application for the purposes of reviewing this application and posting public notice for this application.

Signature of Applicant:	TEL	Date: 3/1/2021

Office Use	Office Use Type/Date:
	Base Fee: \$500.00
	Per Acre:\$100,00X (
Received	Total:
	Prepared by:
	Reviewed by:
	PAYOR:
	RECIEPT#

City of Powell · 47 Hall Street · Powell, Ohio 43065 · (614) 885-5380 · (614) 885-5339 fax· www.cityofpowell.us

March 5, 2021

Planning and Zoning Commission City of Powell 47 Hall Street Powell, OH 43065 614.885.5380

Re: The Venery Preliminary Development Application

To whom it may concern,

I am pleased to submit this application for the redevelopment of the property located at 80 E Olentangy Street for The Venery, a private social club featuring hard to find bourbons and other liquors, chef crafted cocktails, fine wines and beers in a low key elegant ambiance. This tenant-specific use will have a 10 year lease with four additional 5 year renewal terms. The development will also have long term value to the surrounding area to continue with other future tenants as the same concept or as two commercial spaces with separate storefronts.

The architectural design criteria of the project will be to restore and maintain the original residential structure including the front porch, though the garage structure and rear porch will be removed. A new addition will be added to the north with a roofline that will mimic the existing. A transitional architectural component will be constructed between the two buildings with a flat roof in order to allow for the original north-facing roof soffit to remain uninterrupted. This fulcrum between the new and old will also accommodate the new primary entry from the new parking lot. Additional detail and tabular data has been provided in the drawings of the project which have been included in this proposal.

It is our intention to explore alternative stormwater management strategies if feasible. These may include but not limited to pervious pavers in the parking area, blue roof in the flat roof area, rainwater harvesting, bioswales, etc. These would be represented in our final application pending preliminary approval from the Commission.

The proposed landscape will include herbaceous borders along the west and east property edges along with some planted areas along the south facade of the house. Plant materials will likely include a variety of perennial grasses and flowers. Images representing the proposed plantings are included here for reference and discussion.


It is anticipated that a number of non-contributing and/or diseased/dead trees and shrubs will be removed from the property. A final tree survey will be included in the final application. Any significant and healthy trees located within the footprint of the proposed building will be noted for proposed removal at that time.


Assuming our project is acceptable, we will plan to proceed with developing the details required for final approval.

Thank you,

Sarah Mackert SJM studio. LLC

such Market

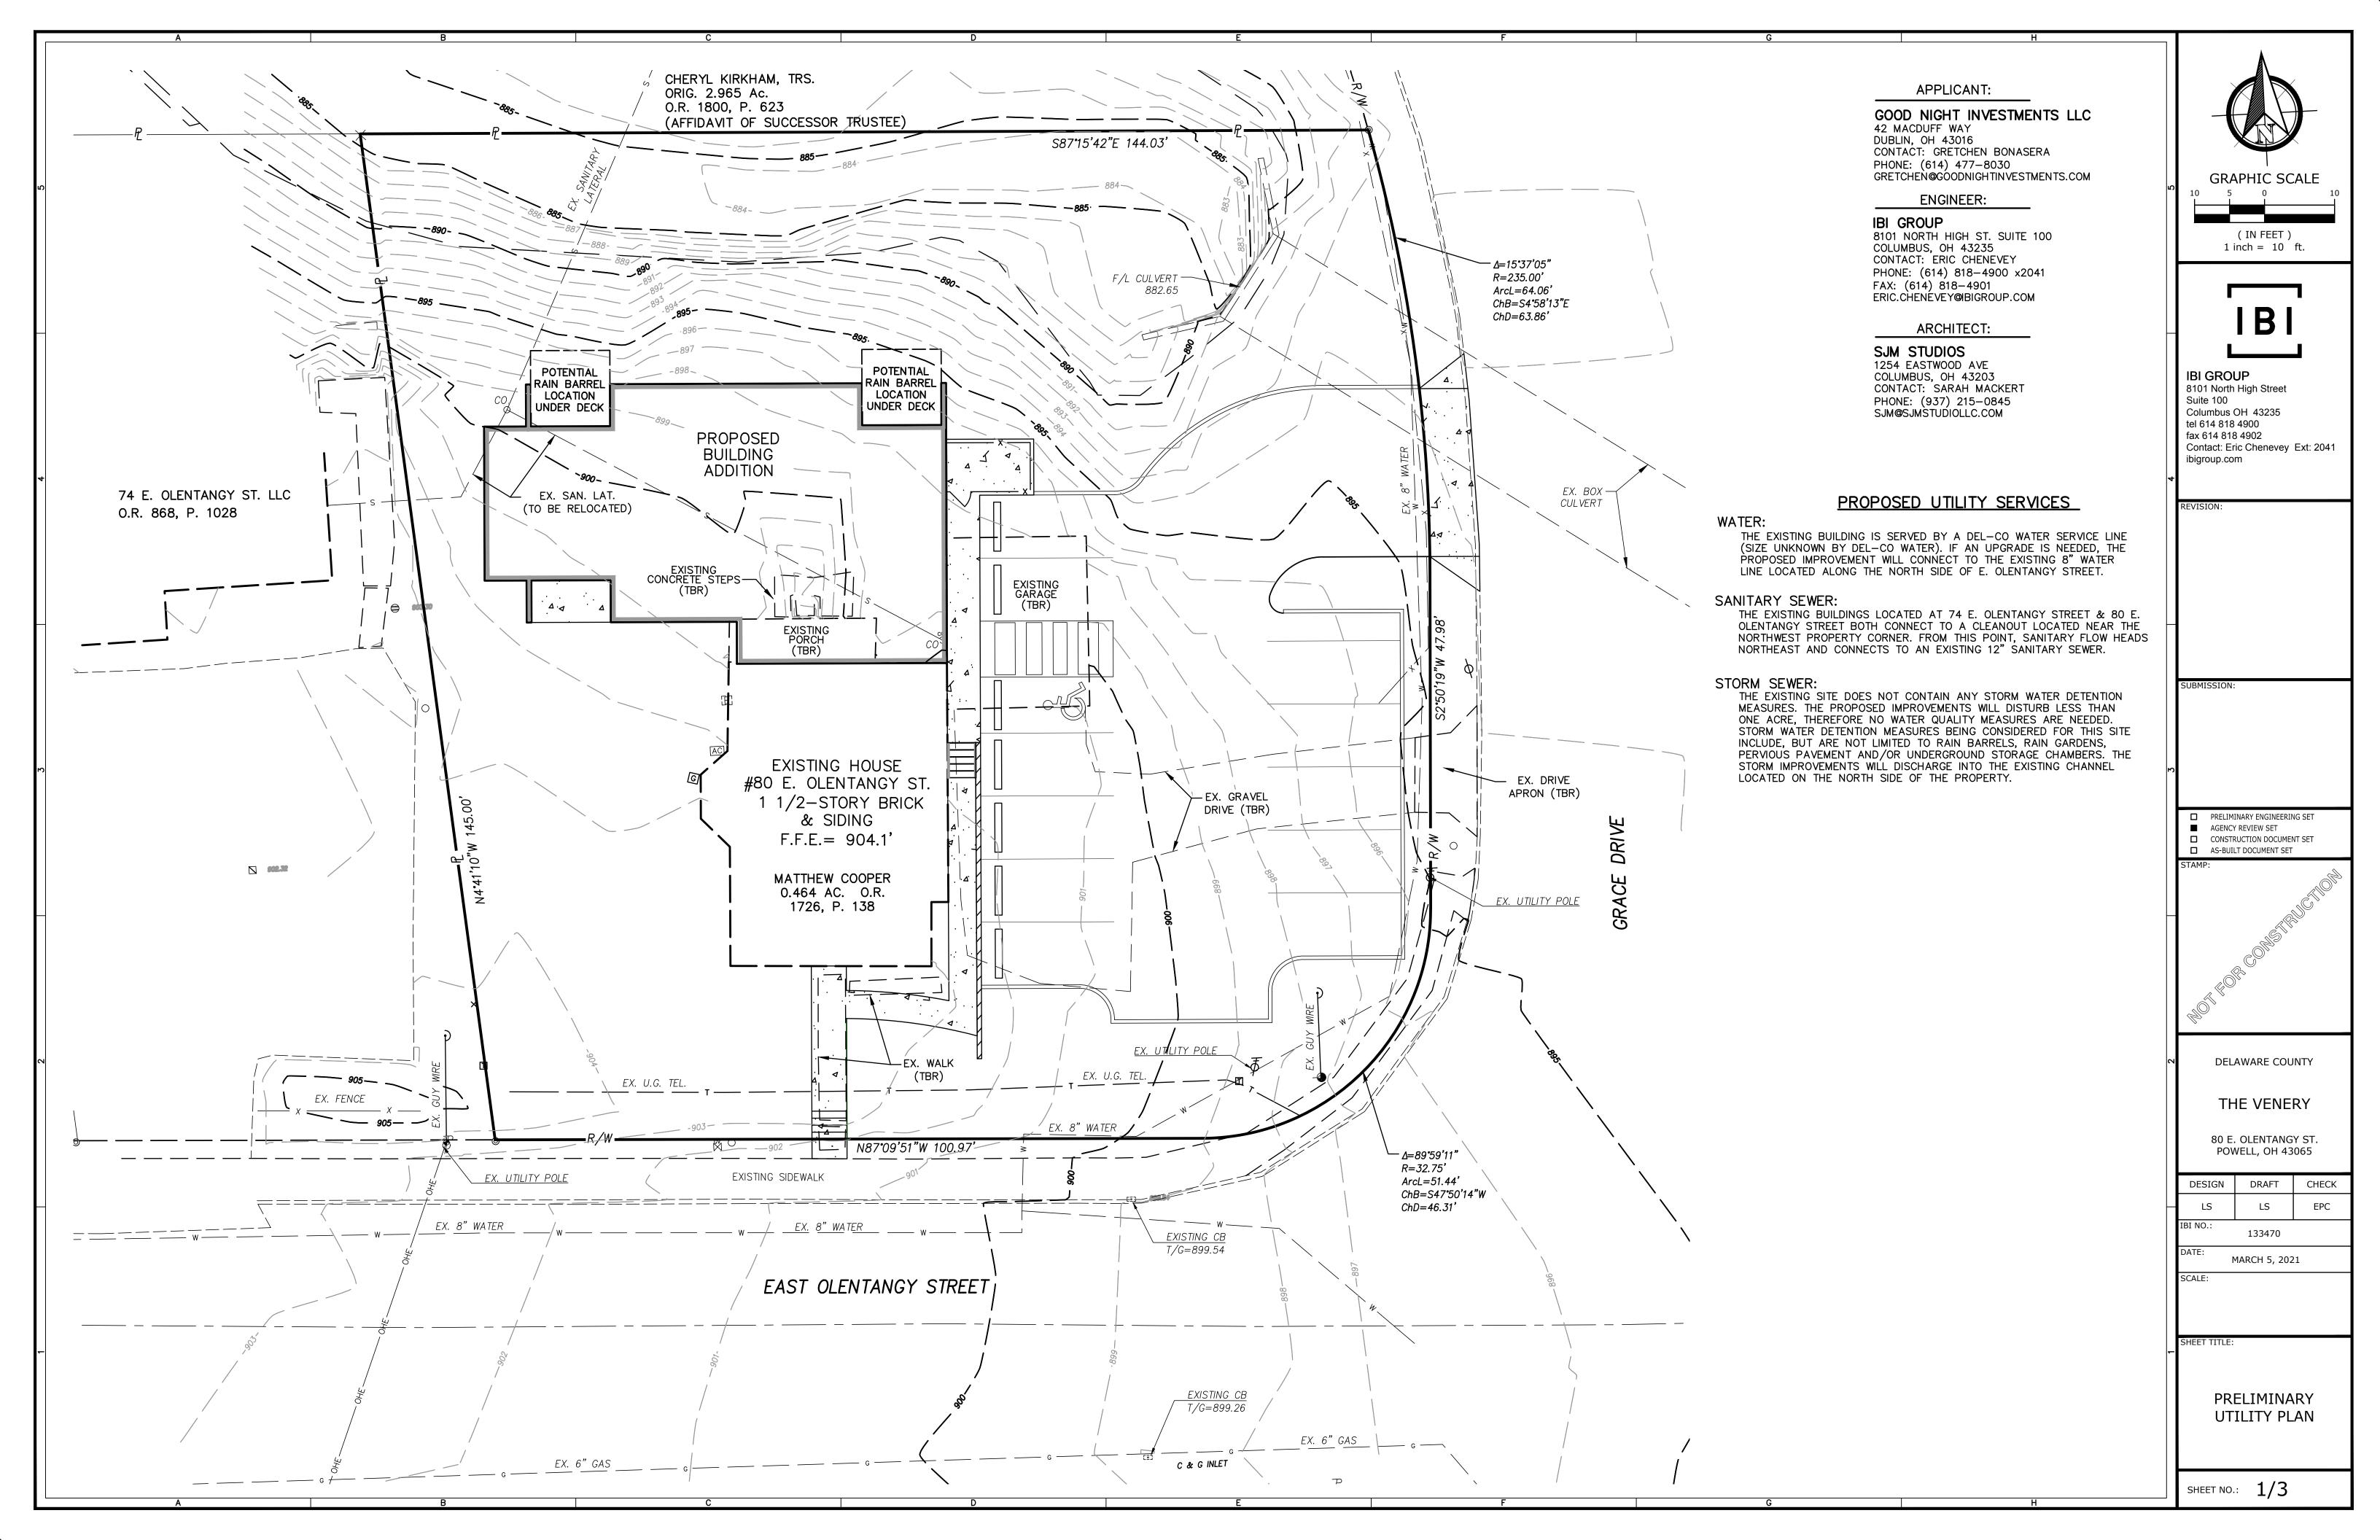

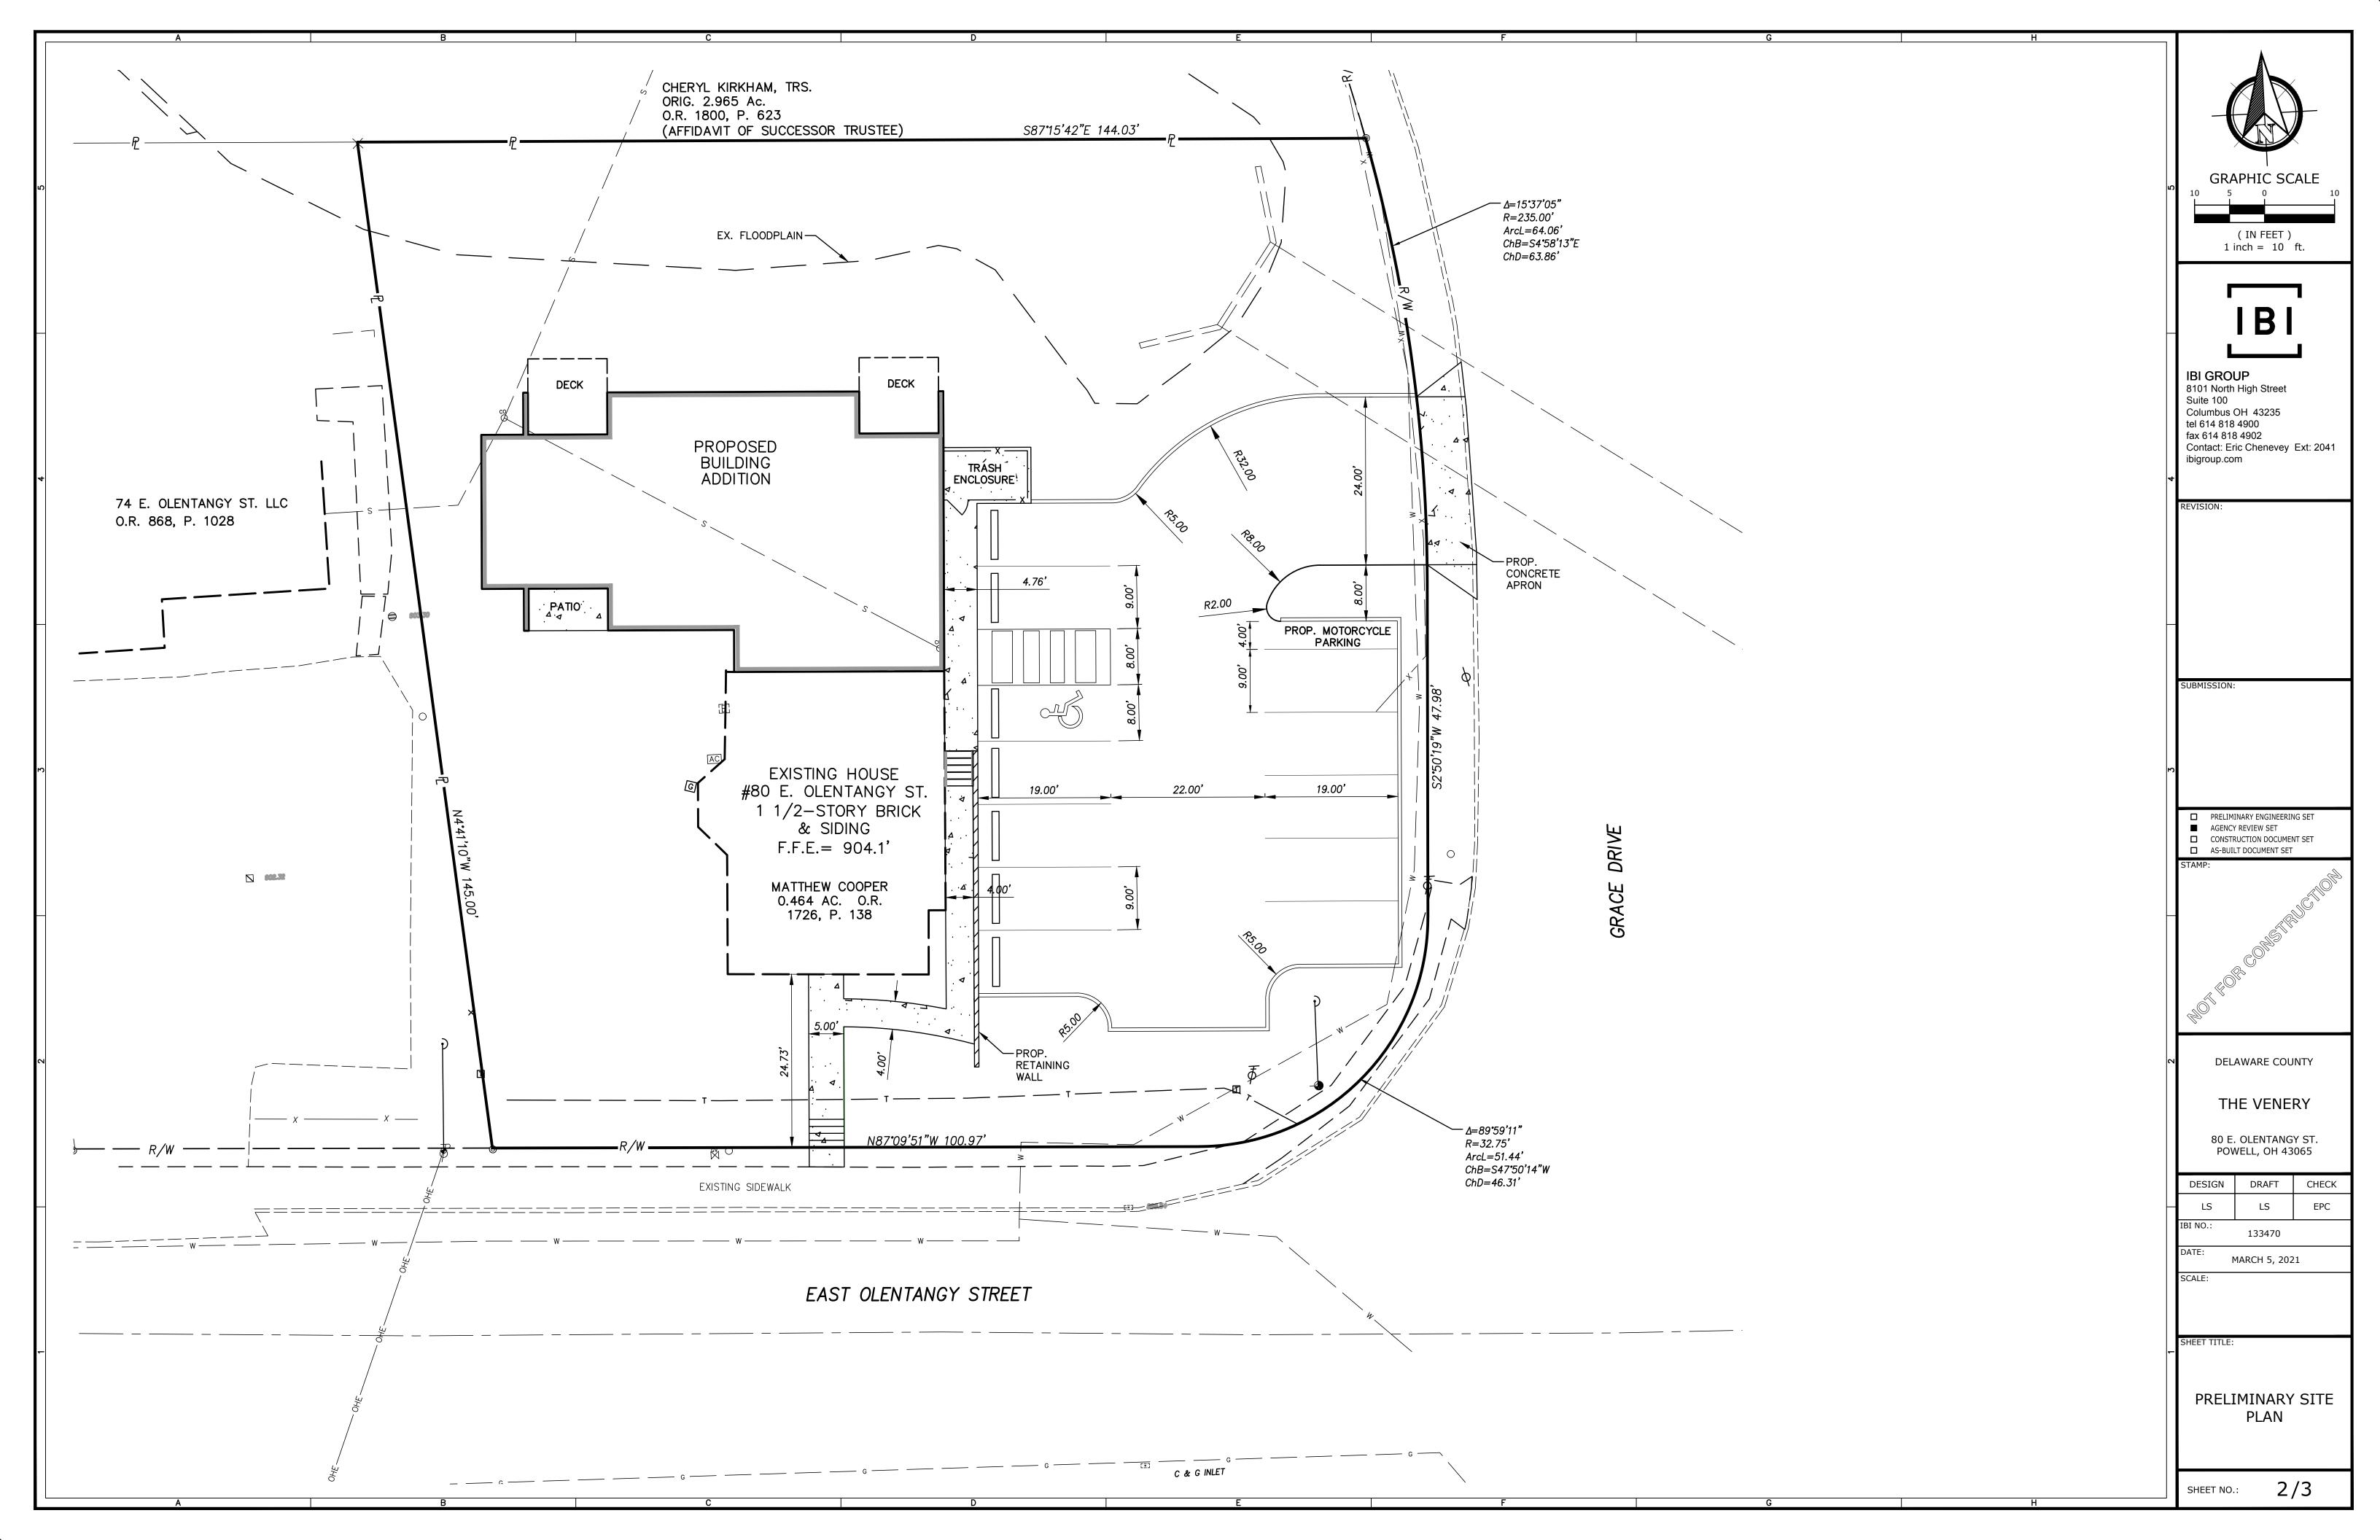





#### VICINITY MA

– PARKS & RECREATION

- MIXED USE & COMMERCIAL BUILDINGS



GRAPHIC SCALE

80 40 0



( IN FEET )

1 inch = 40 ft.

IBI GROUP
8101 North High Street
Suite 100
Columbus OH 43235
tel 614 818 4900
fax 614 818 4902
Contact: Eric Chenevey Ext: 2041
ibigroup.com

REVISION:

SUBMISSION

□ PRELIMINARY ENGINEERING SET
 ■ AGENCY REVIEW SET
 □ CONSTRUCTION DOCUMENT SET

STAMP:

DELAWARE COUNTY

80 E. OLENTANGY ST.

THE VENERY

POWELL, OH 43065

DESIGN DRAFT CHECK

LS	LS	EPC	
IBI NO.:	133470		
DATE:	TE: MARCH 5, 2021		
SCALE:			

SHEET TITLE:

VICINITY MAP & LEGAL DESCRIPTION

SHEET NO.: 3/3

80 E OLENTANGY STREET POWELL, OHIO 43065

### **ABREVIATIONS**

@ = ATG = GASAB = ANCHOR BOLT GA = GAUGEA/C = AIR CONDITIONING GALV = GALVANIZEDGC = GENERAL CONTRACTOR ADJ = ADJACENTAFF = ABOVE FINISHED FLOOR GEN L = GENERAL GL = GLASSAFS = ABOVE FINISHED SLAB ALS = ACRYLIC LATEX SEALANT GR = GRANITE ALUM = ALUMINUM GRND = GROUND GST = GLAZED STRUCTURAL TILE ANOD = ANODIZED GWB = GYPSUM WALL BOARD ARA = AREA OF RESCUE ASSISTANCE

ID = INSIDE DIAMETER

INFO = INFORMATION

INSUL = INSULATION

INT = INTERIOR

JAN = JANITOR

KIT = KITCHEN

KP = KICK PLATE

JB = JUNCTION BOX

JC = JANITORS CLOSET

MAINT = MAINTENANCE

MDF = MEDIUM DENSITY FIBER

MDO = MEDIUM DENSITY OVERLAY

MAR = MARBLE

MAS = MASONRY

MATL = MATERIAL

MAX = MAXIMUM

MECH = MECHANICAL

MEMB = MEMBRANEMEZZ = MEZZANINE

MFD = MANUFACTURED

MFR = MANUFACTURER

MGT = MANAGEMENT

MISC = MISCELLANEOUS

NIC = NOT IN CONTRACT

OD = OUTSIDE DIAMETER

OH = OPPOSITE HAND

O/O = OUT TO OUT

OPNG = OPENING

PARTN = PARTITION

PC = PERPENDICULAR

PERF = PERFORATED

P/L = PROPERTY LINE

PLY WD = PLY WOOD

PLAM = PLASTIC LAMINATE

PREFAB = PREFABRICATED

P.T. = PRESSURE TREATED

PSF = POUNDS PER SQUARE FOOT PSI = POUNDS PER SQUARE INCH

PFN = PREFINISH (ED)

PCP = PRECAST CONCRETE PLATE

OPP = OPPOSITE

OZ = OUNCE

PH = PHASE

PL = PLATE

PR = PAIR

PT = PAINTPTD = PAINTED

O.R.C. = OHIO RESIDENTIAL CODE

MO = MASONRY OPENING

MGR = MANAGER

MH = MAN HOLE

MIN = MINIMUM

MP = METAL PANEL

MTD = MOUNTED

MTG = MEETING

NAT = NATURAL

NO = NUMBER

OA = OVERALL

OC = ON CENTER

NOM = NOMINAL

NTS = NOT TO SCALE

MTL = METAL

N = NORTH

MIR = MIRROR

IG = INSIDE GLAZED

IN = INCH

J = JOIST

AP = ACCESS PANEL APPROX = APPROXIMATELYHB = HOSE BIBBARCH = ARCHITECT BDW = HARDWARE HDWD = HARDWOOD AS = ACOUSTICAL SEALANT HM = HOLLOW METAL B/ = BOTTOM OF HORIZ = HORIZONTAL B/B = BACK TO BACK HR = HOURBD = BOARDHS = HIGH STRENGTH BFG = BELOW FINISHED GRADE HT = HEIGHT HVAC = HEATING, VENTILATION, A/C

BLDG = BUILDING BLK = BLOCK (BLOCKING)BM = BEAMBMT = BUTYL MASTIC TAPE SEALANT BRK = BRICKBRS = BUTYL RUBBER SEALANT BRZ = BRONZEBSMT = BASEMENT BTW = BETWEEN

BYD = BEYONDC/C = CENTER TO CENTERCIP = CAST-IN-PLACE CEM = CEMENTCER = CERAMICCFL = COUNTERFLASH (ING) CJ = CONTROL JOINT CL = CENTER LINE

CLG = CEILING L = LENGTHLAM = LAMINATE (D) CLO = CLOSETCLR = CLEAR OPENING LAV = LAVATORY CMU = CONCRETE MASONRY UNIT LB = POUNDCO = CLEAN OUT LBL = LABELCOL = COLUMNLH = LEFT HAND CONC = CONCRETE LIN = LINEARCONST = CONSTRUCTION LLH = LONG LEG HORIZONTAL CONTR - CONTRACTOR LLV = LONG LEG VERTICAL CONT = CONTINUOUS LNFT = LINEAR FEET COOR = COORDINATE LP = LOW POINT CORR = CORRIDOR LT(G) = LIGHTING(ING)CPT = CARPETLVPL = LEVELING PLATE CT = CERAMIC TILE LVR = LOUVER

DB = DIRECT BURIAL DBL = DOUBLEDD = DECK DRAINDIA = DIAMETERDIFF = DIFFUSER DIM = DIMENSION DIR = DIRECTION DN = DOWNDR = DOORDS = DOWN SPOUT DTL = DETAILDW = DRY WALL DWG(S) = DRAWING(S)EA = EACH

CTSK = COUNTERSINK

CTR = CENTER

CU = CUBIC

EB = EXPANSION BOLT EC = EXPOSED CONSTRUCTION EF = EXHAUST FANEJ = EXPANSION JOINT EL = ELEVATORELEC = ELECTRIC ELEV = ELEVATION EOS = EDGE OF SLAB EQ = EQUALEQUIP = EQUIPMENT EXIST G = EXISTING EXT = EXTERIOR

F = FEMALEFA = FIRE ALARM FACP = FIRE ALARM CONTROL PANEL FB = FACE BRICK F/C = FAN COILFD = FLOOR DRAIN FE = FIRE EXTINGUISHER FEC = FIRE EXTINGUISHER CABINET FF = FINISHED FLOOR FIN = FINISH (ED)FIXT = FIXTURE FLR = FLOOR FLUOR = FLUORESCENT FND = FOUNDATION FOC = FACE OF CONCRETE FOF = FACE OF FINISH FOS = FACE OF STUD FSD = FIRE SEPARATION DISTANCE FRT = FIRE RETARDANT TREATED

FT = FEET

FTG = FOOTING

FV = FIELD VERIFY

QT = QUARRY TILE QTY = QUALITY QUANT = QUANTITY

> R = RADIUSRA = RETURN AIR RB = RESILIENT BASE RC = REINFORCED CONCRETE RD = ROOF DRAIN REF = REFERENCE REG = REGISTER REINF = REINFORCED REQ D = REQUIREDREV = REVISION RFL = REFLECTEDRGTR = REGISTER RI = RISERRM = ROOM

RMV = REMOVE

RO = ROUGH OPENING RoW = RIGHT OF WAY S = SOUTHSA = SUPPLY AIRSD = SMOKE DETECTOR SECT = SECTIONSGG = SILICONE GLAZING GASKET SGS = SILICONE GLAZING SEALANT SHT = SHEETSHTG = SHEATHING SIM = SIMILARSJS = SILICONE JOINT SEALANT

SPEC = SPECIFICATION SQ = SQUARESQFT = SQUARE FEET SQYD = SQUARE YARDSS = STAINLESS STEEL ST = SEALANT TAPE STD = STANDARDSTL = STEELSTM = STORM STOR = STORAGE STRUCT = STRUCTURAL SUSP = SUSPENDED SYS = SYSTEM

T = TOWNHOUSE T/ = TOP OF TEL = TELEPHONE TEMP = TEMPERATURE TH = TOWNHOUSE THK = THICK (NESS)THR = THRESHOLD MACH = MACHINE TYP = TYPICAL

> UC = UNDERCUT UG = UNDERGROUND UNF = UNFISNISHED UNO = UNLESS NOTED OTHERWISE

VA = VOLT-AMPSVAL = VALVEVERT = VERTICAL VEST = VESTIBULE VIF = VERIFY IN FIELD VCT = VINYL COMPOSITION TILE VWC = VINYL WALL COVERING

W = WESTW/ = WITHW/O = WITH OUT WC = WATER CLOSET WCO = WALL CLEAN OUT WD = WOODWDW = WINDOW WRB = WEATHER RESISTIVE BARRIER WPR = WATERPROOFING WPT = WORK POINT WT = WEIGHT WWF = WELDED WIRE FABRIC

YD = YARD

### SYMBOLS LEGEND

DETAIL NO.			
SIM A101	BUILDING SECTION	AREA NAME	AREA TAG
DETAIL NO.		ROOM NAME	
1 SIM	WALL SECTION	101	ROOM TAG
DETAIL NO. SHEET NO.		150 SF	
A101	DETAIL SECTION	$\binom{1}{1}$ NOTE	CODED NOTE
DETAIL NO.			
DETAIL 11A5.00 SIM	DETAIL CALLOUT	?	KEYNOTE
DETAIL NO. SHEET NO.		$\wedge$	
1 A101 1 DETAIL NO.	EXTERIOR ELEVATION		REVISION TAG
SHEET NO.		waa .	
1 A101 1	INTERIOR ELEVATION	W22	WALL TAG
- <b>LEVEL</b> 876' - 0"	ELEVATION	\alpha\cdot	WINDOW TAG
¥ 876' - 0"	LLEVATION	V	WINDOW IAC
XXX.X'	SPOT ELEVATION	(101)	DOOR TAG
<b>*</b>			
— — — — <b>1</b>	STURCTURAL GRID LINE		FLOOR/ROOF TAG
	MATCH LINE	(ÂCÌ)	ACCESSORY TAG

CENTERLINE		

\_\_-\_\_\_

GLASS

# MATERIALS LEGEND

	1717 1 1	LIVII ILS LL OL
SITEWORK  EARTH	GRAVEL	GEOLOGICAL ROCK
CONCRETE  CIP/PRECAST	GROUT	+ + + + + + + MORTAR
MASONRY BRICK	СМО	FIREBRICK
STONE  CUT STONE	RUBBLE	SLATE
METAL STEEL	ALUMINUM	BRASS
WOOD	ROUGH	BLOCKING
PLYWOOD (LARGE SCALE)	PLYWOOD (SMALL SCALE)	CORK
FINISHES PLASTIC	GYPSUM PLASTER	CERAMIC TILE
NSULATION  BATT/ LOOSE	RIGID	SPRAY FOAM
GLASS		

### DRAWING INDEX

NO.	NAME	REVISION NO.	REVISIOI DATE
01 - GE	NERAL		
G0.00	COVER SHEET		
G0.01	ARCHITECTURAL SITE PLAN	<u> </u>	
G0.02	PROJECT SUMMARY		
G1.02	LIFE SAFTEY FLOOR PLANS + BUILDING SECTIONS	<u> </u>	<u> </u>
03 - SU	RVEY		
V1.00	EXISTING BASEMENT + LEVEL 1	T	T
V1.01	EXISTING LEVEL 2 + ROOF PLAN	+	+
V2.00	EXISTING ELEVATIONS	+	+
V3.00	EXISTING BUILDING SECTIONS	+	+
09 - AR	CHITECTURAL		
A1.00	BASEMENT PLAN		
A1.01a	LEVEL 1 - ENTRY LEVEL		
A1.01b	LEVEL 1 - EXISTING FIRST FLOOR		
A1.02a	LEVEL 2 - MEZZANINE		
A1.02b	LEVEL 2 - EXISTING ATTIC		
A1.03	ROOF PLAN		
A2.00	BUILDING ELEVATIONS		
A2.01	BUILDING ELEVATIONS	<u></u>	
A2.01 A3.00	BUILDING ELEVATIONS BUILDING SECTIONS	+	+

### PROJECT DIRECTORY

Owner:	Goodnight Investments Michael + Gretchen Bonasera thefoodsmith@foodsmith.com Owner Phone No.
Architect:	SJM studio, LLC Sarah Mackert sjm@sjmstudiollc.com (937) 215-0845
Civil Engineer:	IBI Group Eric Chenevey eric.chenevey@ibigroup.com 614.679.3645
Structural Engineer:	Ehlers Engineering, LLC Derek Ehlers, PE derek@ehlersengineering.com 614.330.2298
MEP Engineer:	Allemang Engineering, LLC Donald K. Allemang, PE dalleman@columbus.rr.com 614.580.9006
General Contractor:	Lincoln Construction Greg Schmitt gschmitt@lincolnconstruction.com

# APPLICABLE CODES

614.457.0180

VILLAGE OF POWELL, PLANNING AND ZONING CODE 2017 OHIO BUILDING CODE (OBCO + AMENDMENTS 2017 OHIO PLUMBING CODE (OPC) + AMENDMENTS 2017 OHIO MECHANICAL CODE (OMC) + AMENDMENTS 2017 NATIONAL ELECTRIC CODE (NEC) | NFPA 70 ICC A117.1-2009 ACCESSIBLE + USABLE BUILDINGS + FACILITIES 2012 INTERNATIONAL ENERGY CONSERVATION CODE + AMENDMENTS 2015 INTERNATIONAL FUEL GAS CODE ASHRAE 90.1 2010 NATIONAL FIRE ALARM + SIGNALING CODE (NFPA 72-10) OHIO FIRE CODE 2017

### PROJECT SUMMARY


PARCEL SUMMARY:

DELAWARE COUNTY PARCEL NO. 31942513051002 0.46 ACRES

PROJECT DESCRIPTION:

THE PROJECT CONSISTS OF A CHANGE OF OCCUPANCY WITH ALTERATIONS TO AN EXISTING 2,772 SF IIIB STRUCTURE LOCATED WITHIN THE VILLAGE OF POWELL, OHIO. A 2,821 SF ADDITION OF TYPE VB CONSTRUCTION WILL BE ADDED TO THE NORTH. THESE COMBINED SPACES WILL ACCOMMODATE AN A-2 ASSEMBLY OCCUPANCY WITH SUPPORTING OFFICE, RESTROOMS, STORAGE, UTILITY AND CIRCULATION AS REQUIRED FOR THE PRIVATE CLUB.

## VICINITY MAP

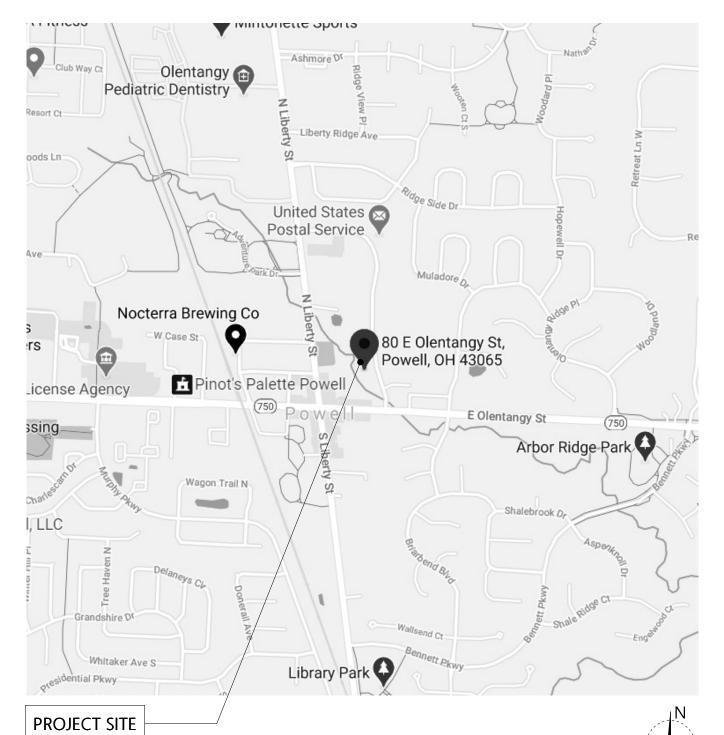

#\ DATE

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This drawing is for review purposes only.

PROJECT TITLE THE VENERY

**80 E OLENTANGY STREET** 


POWELL, OHIO 43065 PROJECT NO. SJM\_2010 P&Z PRELIMINARY ISSUE **ISSUE DATE** 03.05.2021

SHEET TITLE


**COVER SHEET** 

SHEET NO.

6 LEVEL 2 1/16" = 1'-0"

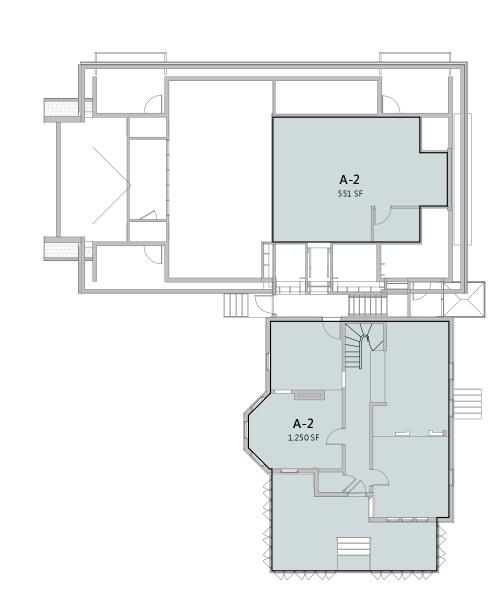


RENTABLE AREA - LEVEL 1 1/16" = 1'-0"

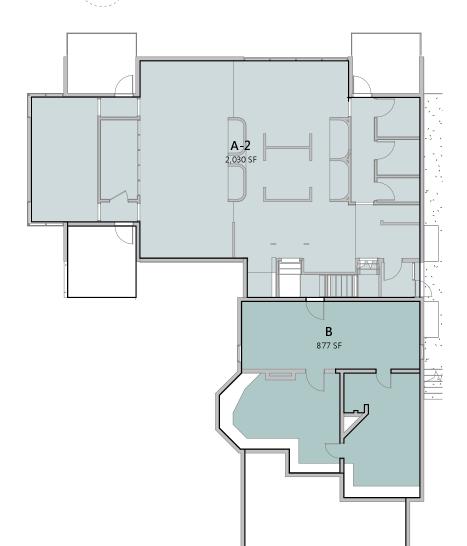


5 EXTG. BASEMENT 1/16" = 1'-0"


BASEMENT GROSS AREA
1/16" = 1'-0"

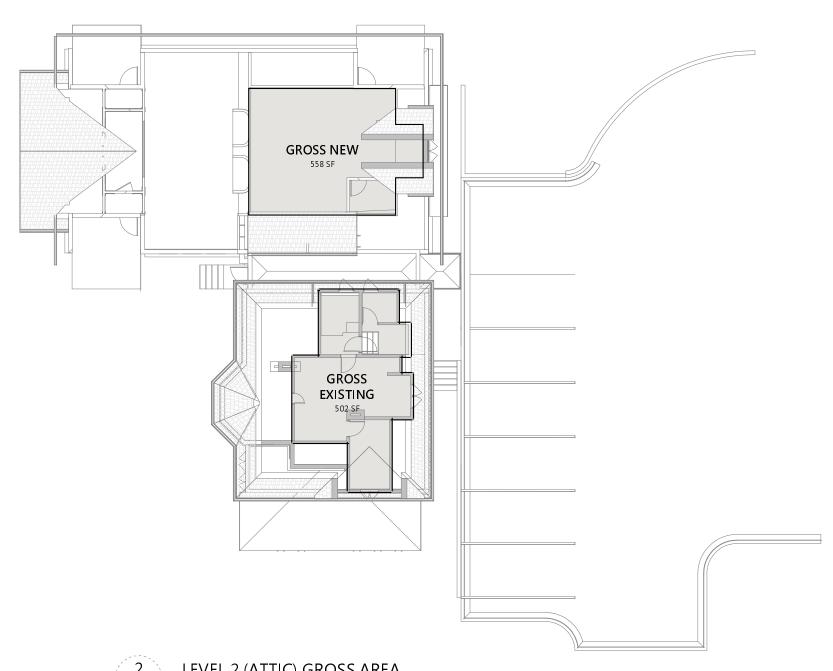

2 LEVEL 2 (ATTIC) GROSS AREA 1/16" = 1'-0"

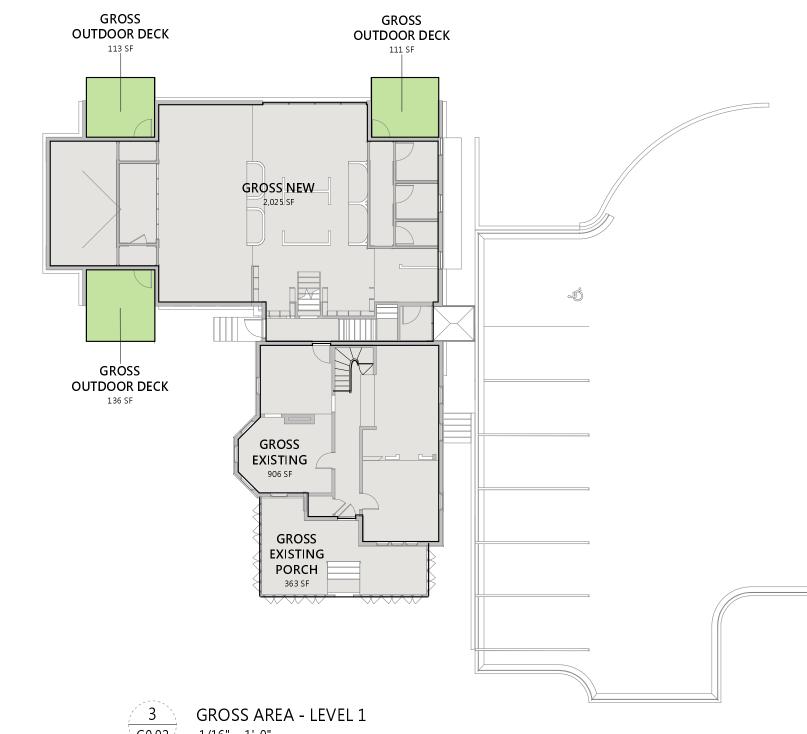


3 GROSS AREA - LEVEL 1 1/16" = 1'-0"

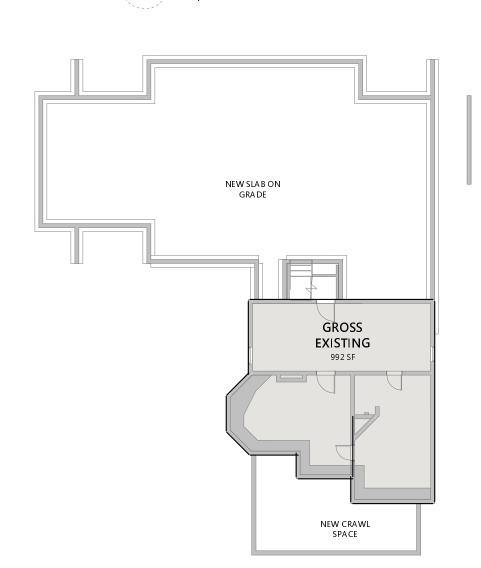

GROSS AREA - EXISTING AREA NAME NEW FOOTER **GROSS EXISTING** 992 SF EXTG. LEVEL 1 **GROSS EXISTING** 906 SF GROSS EXISTING PORCH 363 SF EXTG. LEVEL 2 **GROSS EXISTING** 502 SF 2,762 SF Grand total: 4

GROSS AREA - NEW
AREA
2.025 SF
558 SF
2,583 SF

GROSS AREA OUTDO	OR DECK
AREA NAME	AREA
EXTG. LEVEL 1	
GROSS OUTDOOR DECK	111 SF
GROSS OUTDOOR DECK	113 SF
GROSS OUTDOOR DECK	136 SF
Grand total: 3	360 SF

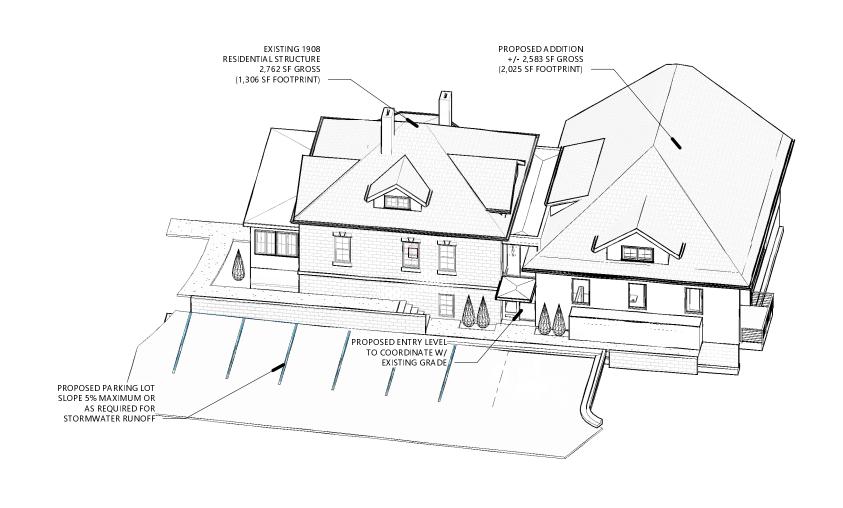

3D AXONOMETRIC



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# DATE REVISION

PROJECT TITLE

THE VENERY

80 E OLENTANGY STREET POWELL, OHIO 43065

PROJECT NO. SJM\_2010 P&Z PRELIMINARY ISSUE DATE 03.05.2021

SHEET TITLE

**PROJECT SUMMARY** 

SHEET NO.

- ALL DRAWINGS AND SPECIFICATIONS ARE THE PROPERTY OF THE ARCHITECT, WHO RESERVES COPYRIGHT WITH RESPECT TO THIS DOCUMENT. THIS DOCUMENT SHALL NOT BE DUPLICATED, USED, OR CIRCULATED FOR ANY OTHER PURPOSE THAN THAT FOR WHICH IT IS ISSUED.
- SEE G1.02 G1.03 FOR EXTENTS AND TECHNICAL DETAILS OF FIRE-RATED BARRIERS, FIRE-RATED PARTITIONS AND SHAFT WALLS. SEE G1.04 FOR UL ASSEMBLIES.
- SEE G1.10 FOR TYPICAL ACCESSIBLE CLEARANCES AND DETAILS.
- EXTERIOR DIMENSIONS ARE TO FACE OF FOUNDATION, FACE OF MASONRY OR FACE OF SHEATHING UNO.
- INTERIOR DIMENSIONS ARE TO FACE OF STUD UNO. VERIFY ALL DIMENSIONS PRIOR TO BEGINNING WORK AND NOTIFY ARCHITECT FOR RESOLUTION OF ANY DISCREPANCIES.
- EXTEND FIRE BARRIERS TO UNDERSIDE OF DECK ABOVE UNO.
- PROVIDE SOUND BATT INSULATION AT ALL TOILET ROOMS AND MECHANICAL ROOMS.
- PROVIDE 5/8" CEMENT BACKER BOARD AT ALL TILE WALL LOCATIONS W/ BLOCKING BEHIND ALL CEMENT BACKER BOARD SEAMS.
- PROVIDE 5/8" MOISTURE RESISTANT GWB AT ALL WET WALL LOCATIONS.
- COMPLY WITH MANUFACTURER INSTRUCTIONS FOR INSTALLATION OF BUILDING MATERIALS AND FF&E.
- LOCATION AND SIZE OF PENETRATIONS/MEMBRANE PENETRATIONS OF FIRE-RATED ASSEMBLIES ARE APPROXIMATE. GC TO FIELD VERIFY SIZE AND LOCATION.
- CONSULT OWNER TO VERIFY PROJECT SALVAGE REQUIREMENTS OF ITEMS NOT IDENTIFIED FOR REUSE HERE PRIOR TO REMOVAL START.
- PROTECT EXISTING ORIGINAL ARCHITECTURE THROUGHOUT INCLUDING WINDOWS, DOORS, MISC. GLASS, CASEWORK, MILLWORK, STAIRS, RAILINGS, HARDWARE AND (TO THE GREATEST EXTENT POSSIBLE) PLASTER.
- COMMERCIAL SPACE SCOPE: GC TO PROVIDE WARM GRAY BOX INCLUDING PLUMBING ROUGH-INS, ELECTRICAL SERVICE, TEMPORARY HEAT, LEVEL 4 FINISH ALL GWB SURFACES

#### FLOOR PLAN NOTES

EXTG. CRAWL SPACE CONDITIONS TO BE VERIFIED IN

FIELD. NEW 4" CIP CONC. SOG

- MAINTAIN AS EMERGENCY EGRESS OPENING EXTG. SPLIT SYSTEM AHU TO REMAIN. RECONFIGURE EXTG. DUCTWORK AS REQ'D TO ACCOMODATE OVERHEAD CLEARANCE IN BASEMENT ROOM 1 AND 2
- PROVIDE NEW OPENING IN EXTG. LOAD BEARING MASONRY WALL
- PROVIDE NEW 4" CONC. SLAB THROUGHOUT BASEMENT PROVIDE NEW 8" DOUBLE WYTHE BRICK MASONRY WALL ON 16" WIDE X 8" DEEP REINFOCED CONC. FOOTER AS INDICATED

/ not for construction  $^{ackprime}$ **PRELIMINARY** This document is partially complete The information contained is not necessarily coordinated or correct.

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# DATE REVISION

PROJECT TITLE

THE VENERY

80 E OLENTANGY STREET POWELL, OHIO 43065

SJM\_2010


03.05.2021

PROJECT NO. ISSUE P&Z PRELIMINARY

**ISSUE DATE** SHEET TITLE

**BASEMENT PLAN** 

SHEET NO.

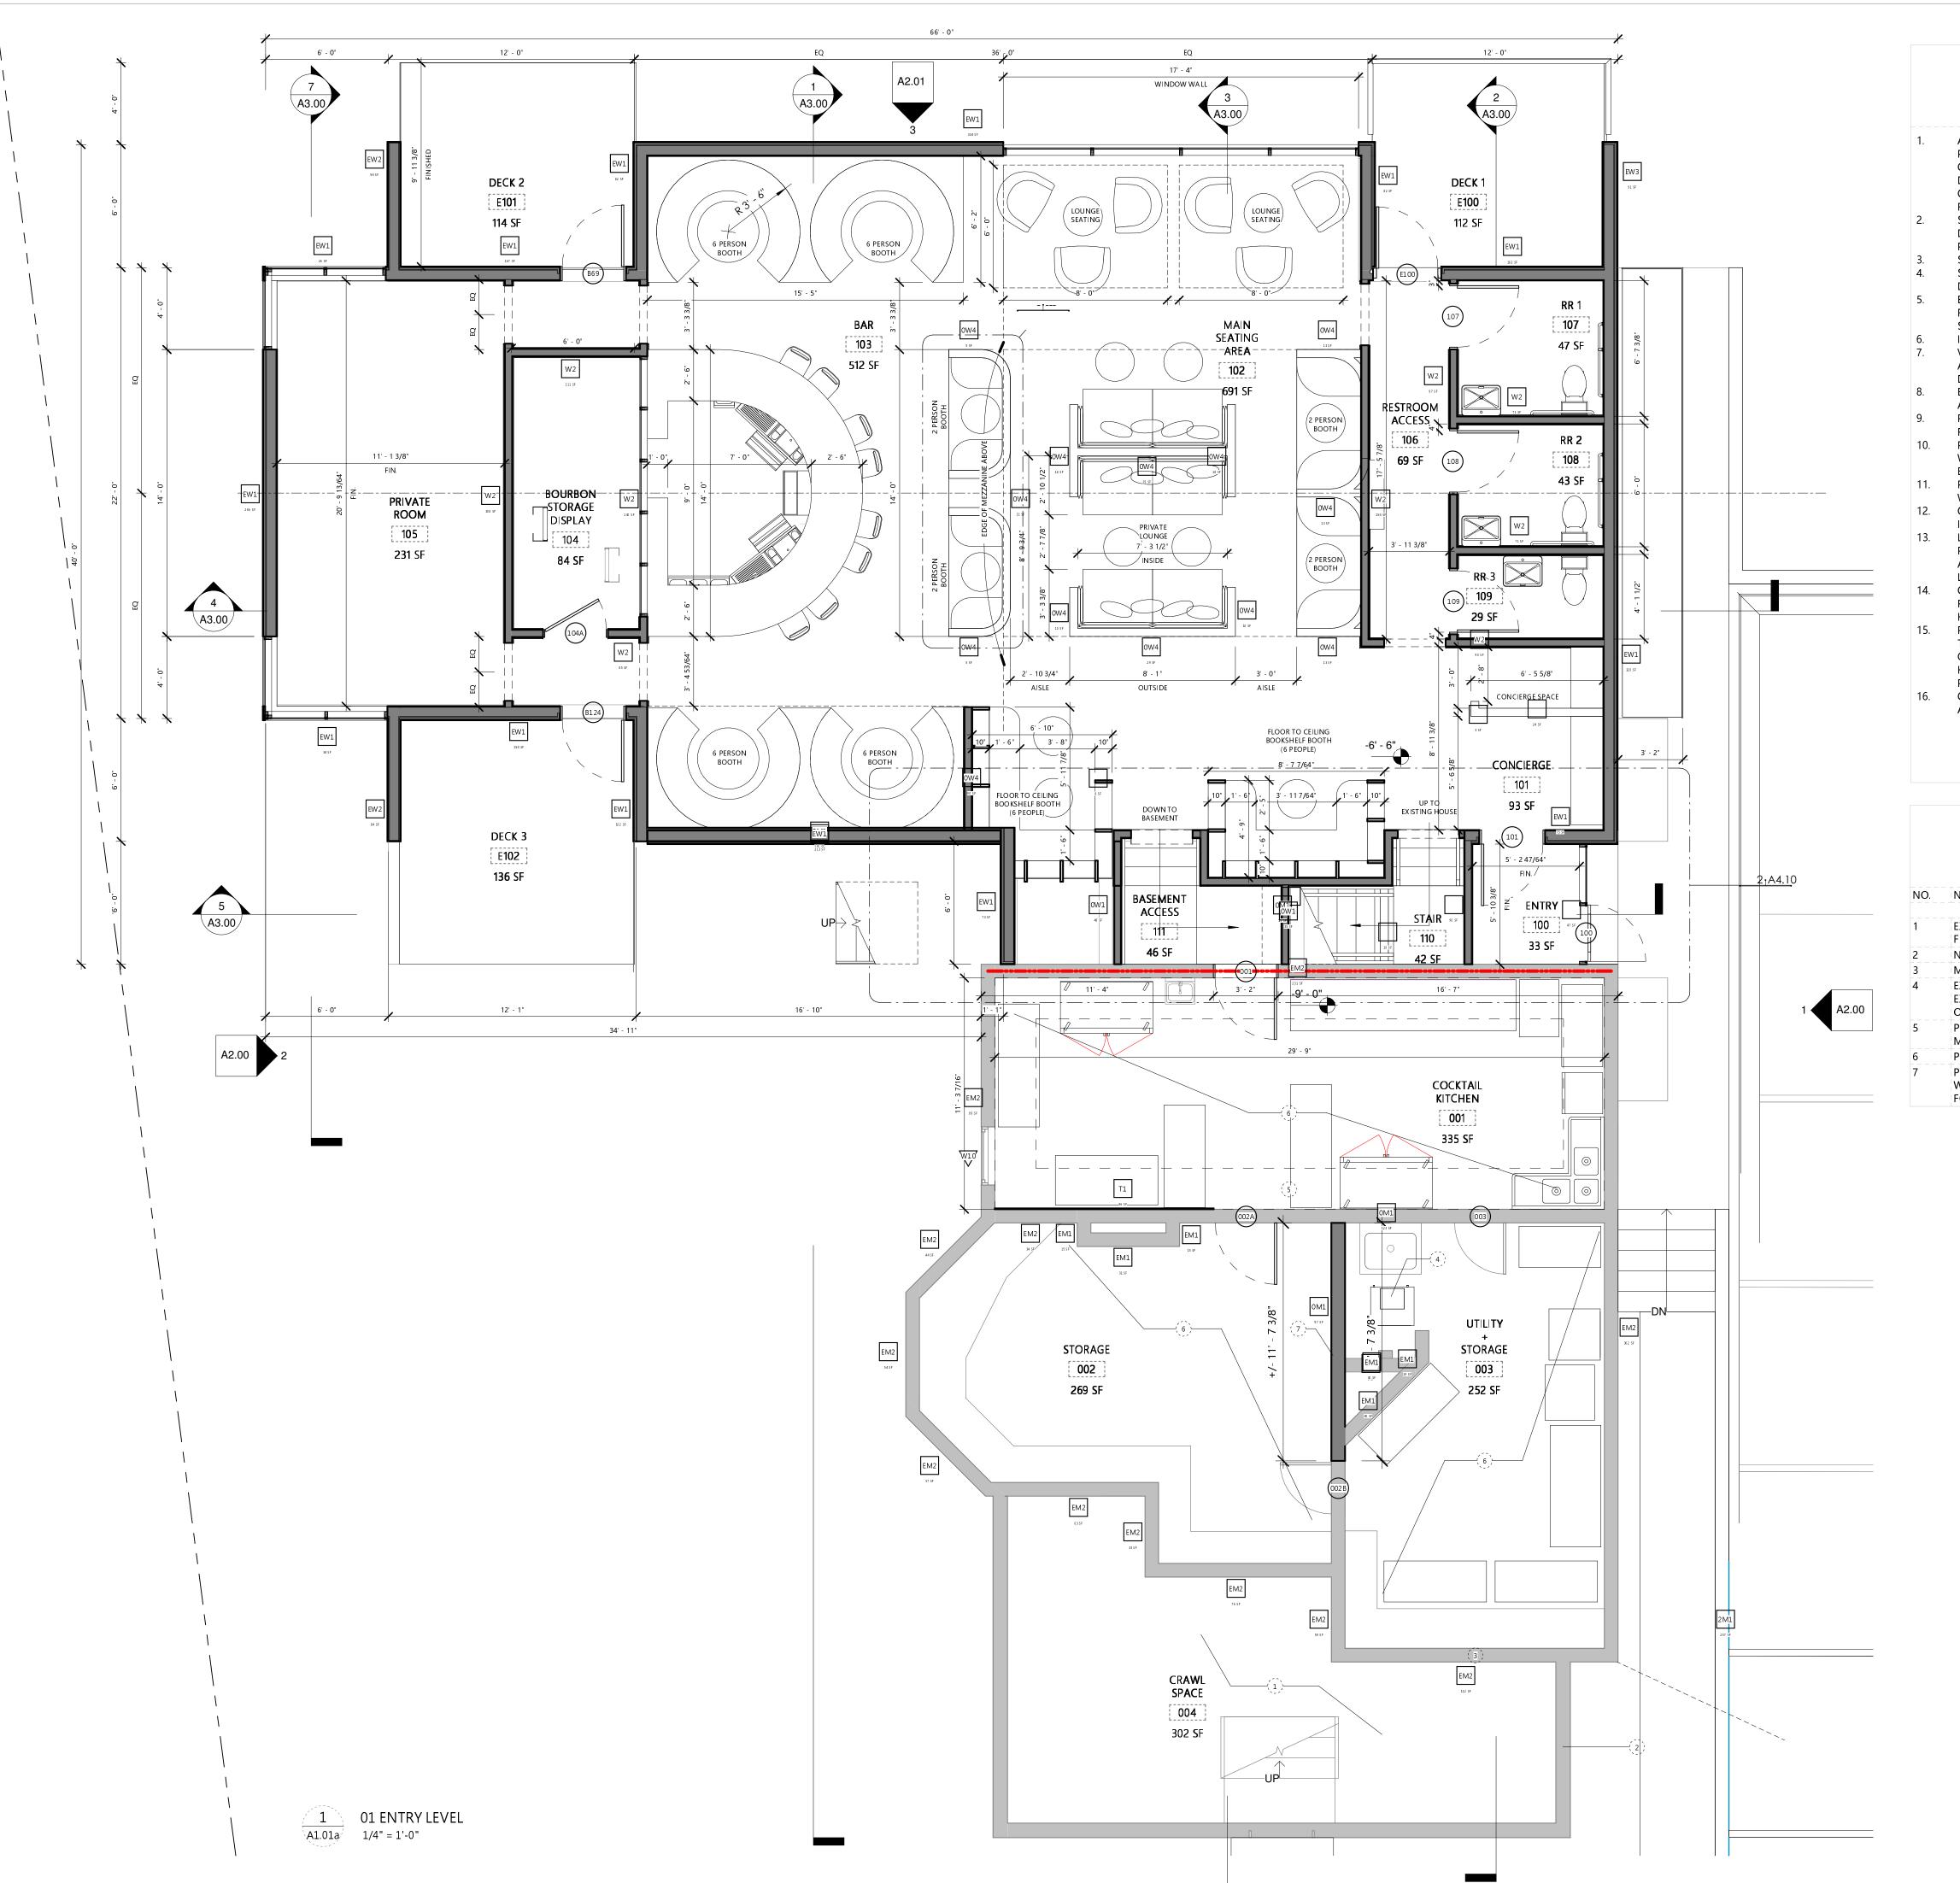

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PROJECT NO. SJM\_2010 ISSUE P&Z PRELIMINARY 03.05.2021

**ISSUE DATE** SHEET TITLE

LEVEL 1 - ENTRY **LEVEL** 

SHEET NO.

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- SEE G1.02 G1.03 FOR EXTENTS AND TECHNICAL DETAILS OF FIRE-RATED BARRIERS, FIRE-RATED PARTITIONS AND SHAFT WALLS.
   SEE G1.04 FOR UL ASSEMBLIES.
- 4. SEE G1.10 FOR TYPICAL ACCESSIBLE CLEARANCES AND DETAILS.
- EXTERIOR DIMENSIONS ARE TO FACE OF FOUNDATION, FACE OF MASONRY OR FACE OF SHEATHING UNO.
- INTERIOR DIMENSIONS ARE TO FACE OF STUD UNO.
  VERIFY ALL DIMENSIONS PRIOR TO BEGINNING WORK
  AND NOTIFY ARCHITECT FOR RESOLUTION OF ANY
  DISCREPANCIES.
- EXTEND FIRE BARRIERS TO UNDERSIDE OF DECK ABOVE UNO.
- PROVIDE SOUND BATT INSULATION AT ALL TOILET ROOMS AND MECHANICAL ROOMS.
- 10. PROVIDE 5/8" CEMENT BACKER BOARD AT ALL TILE WALL LOCATIONS W/ BLOCKING BEHIND ALL CEMENT BACKER BOARD SEAMS.
- PROVIDE 5/8" MOISTURE RESISTANT GWB AT ALL WET WALL LOCATIONS.
- 2. COMPLY WITH MANUFACTURER INSTRUCTIONS FOR INSTALLATION OF BUILDING MATERIALS AND FF&E.
- 13. LOCATION AND SIZE OF PENETRATIONS/MEMBRANE PENETRATIONS OF FIRE-RATED ASSEMBLIES ARE APPROXIMATE. GC TO FIELD VERIFY SIZE AND LOCATION.
- 14. CONSULT OWNER TO VERIFY PROJECT SALVAGE REQUIREMENTS OF ITEMS NOT IDENTIFIED FOR REUSE HERE PRIOR TO REMOVAL START.
- 15. PROTECT EXISTING ORIGINAL ARCHITECTURE THROUGHOUT INCLUDING WINDOWS, DOORS, MISC. GLASS, CASEWORK, MILLWORK, STAIRS, RAILINGS, HARDWARE AND (TO THE GREATEST EXTENT POSSIBLE) PLASTER.
- 6. COMMERCIAL SPACE SCOPE:

  A. GC TO PROVIDE WARM GRAY BOX INCLUDING PLUMBING ROUGH-INS, ELECTRICAL SERVICE, TEMPORARY HEAT, LEVEL 4 FINISH ALL GWB SURFACES

#### FLOOR PLAN NOTES

o. Noti

EXTG. CRAWL SPACE CONDITIONS TO BE VERIFIED IN FIELD.

NEW 4" CIP CONC. SOG

- MAINTAIN AS EMERGENCY EGRESS OPENING
  EXTG. SPLIT SYSTEM AHU TO REMAIN. RECONFIGURE
  EXTG. DUCTWORK AS REQ'D TO ACCOMODATE
  OVERHEAD CLEARANCE IN BASEMENT ROOM 1 AND 2
- OVERHEAD CLEARANCE IN BASEMENT ROOM 1 AND 2
  PROVIDE NEW OPENING IN EXTG. LOAD BEARING
  MASONRY WALL
- PROVIDE NEW 4" CONC. SLAB THROUGHOUT BASEMENT PROVIDE NEW 8" DOUBLE WYTHE BRICK MASONRY WALL ON 16" WIDE X 8" DEEP REINFOCED CONC. FOOTER AS INDICATED

NOT FOR CONSTRUCTION
PRELIMINARY

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# DATE REVISION

PROJECT TITLE

THE VENERY

80 E OLENTANGY STREET POWELL, OHIO 43065

PROJECT NO. SJM\_2010
ISSUE P&Z PRELIMINARY


SHEET TITLE

LEVEL 1 -EXISTING FIRST FLOOR

03.05.2021

SHEET NO.

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NO. NO
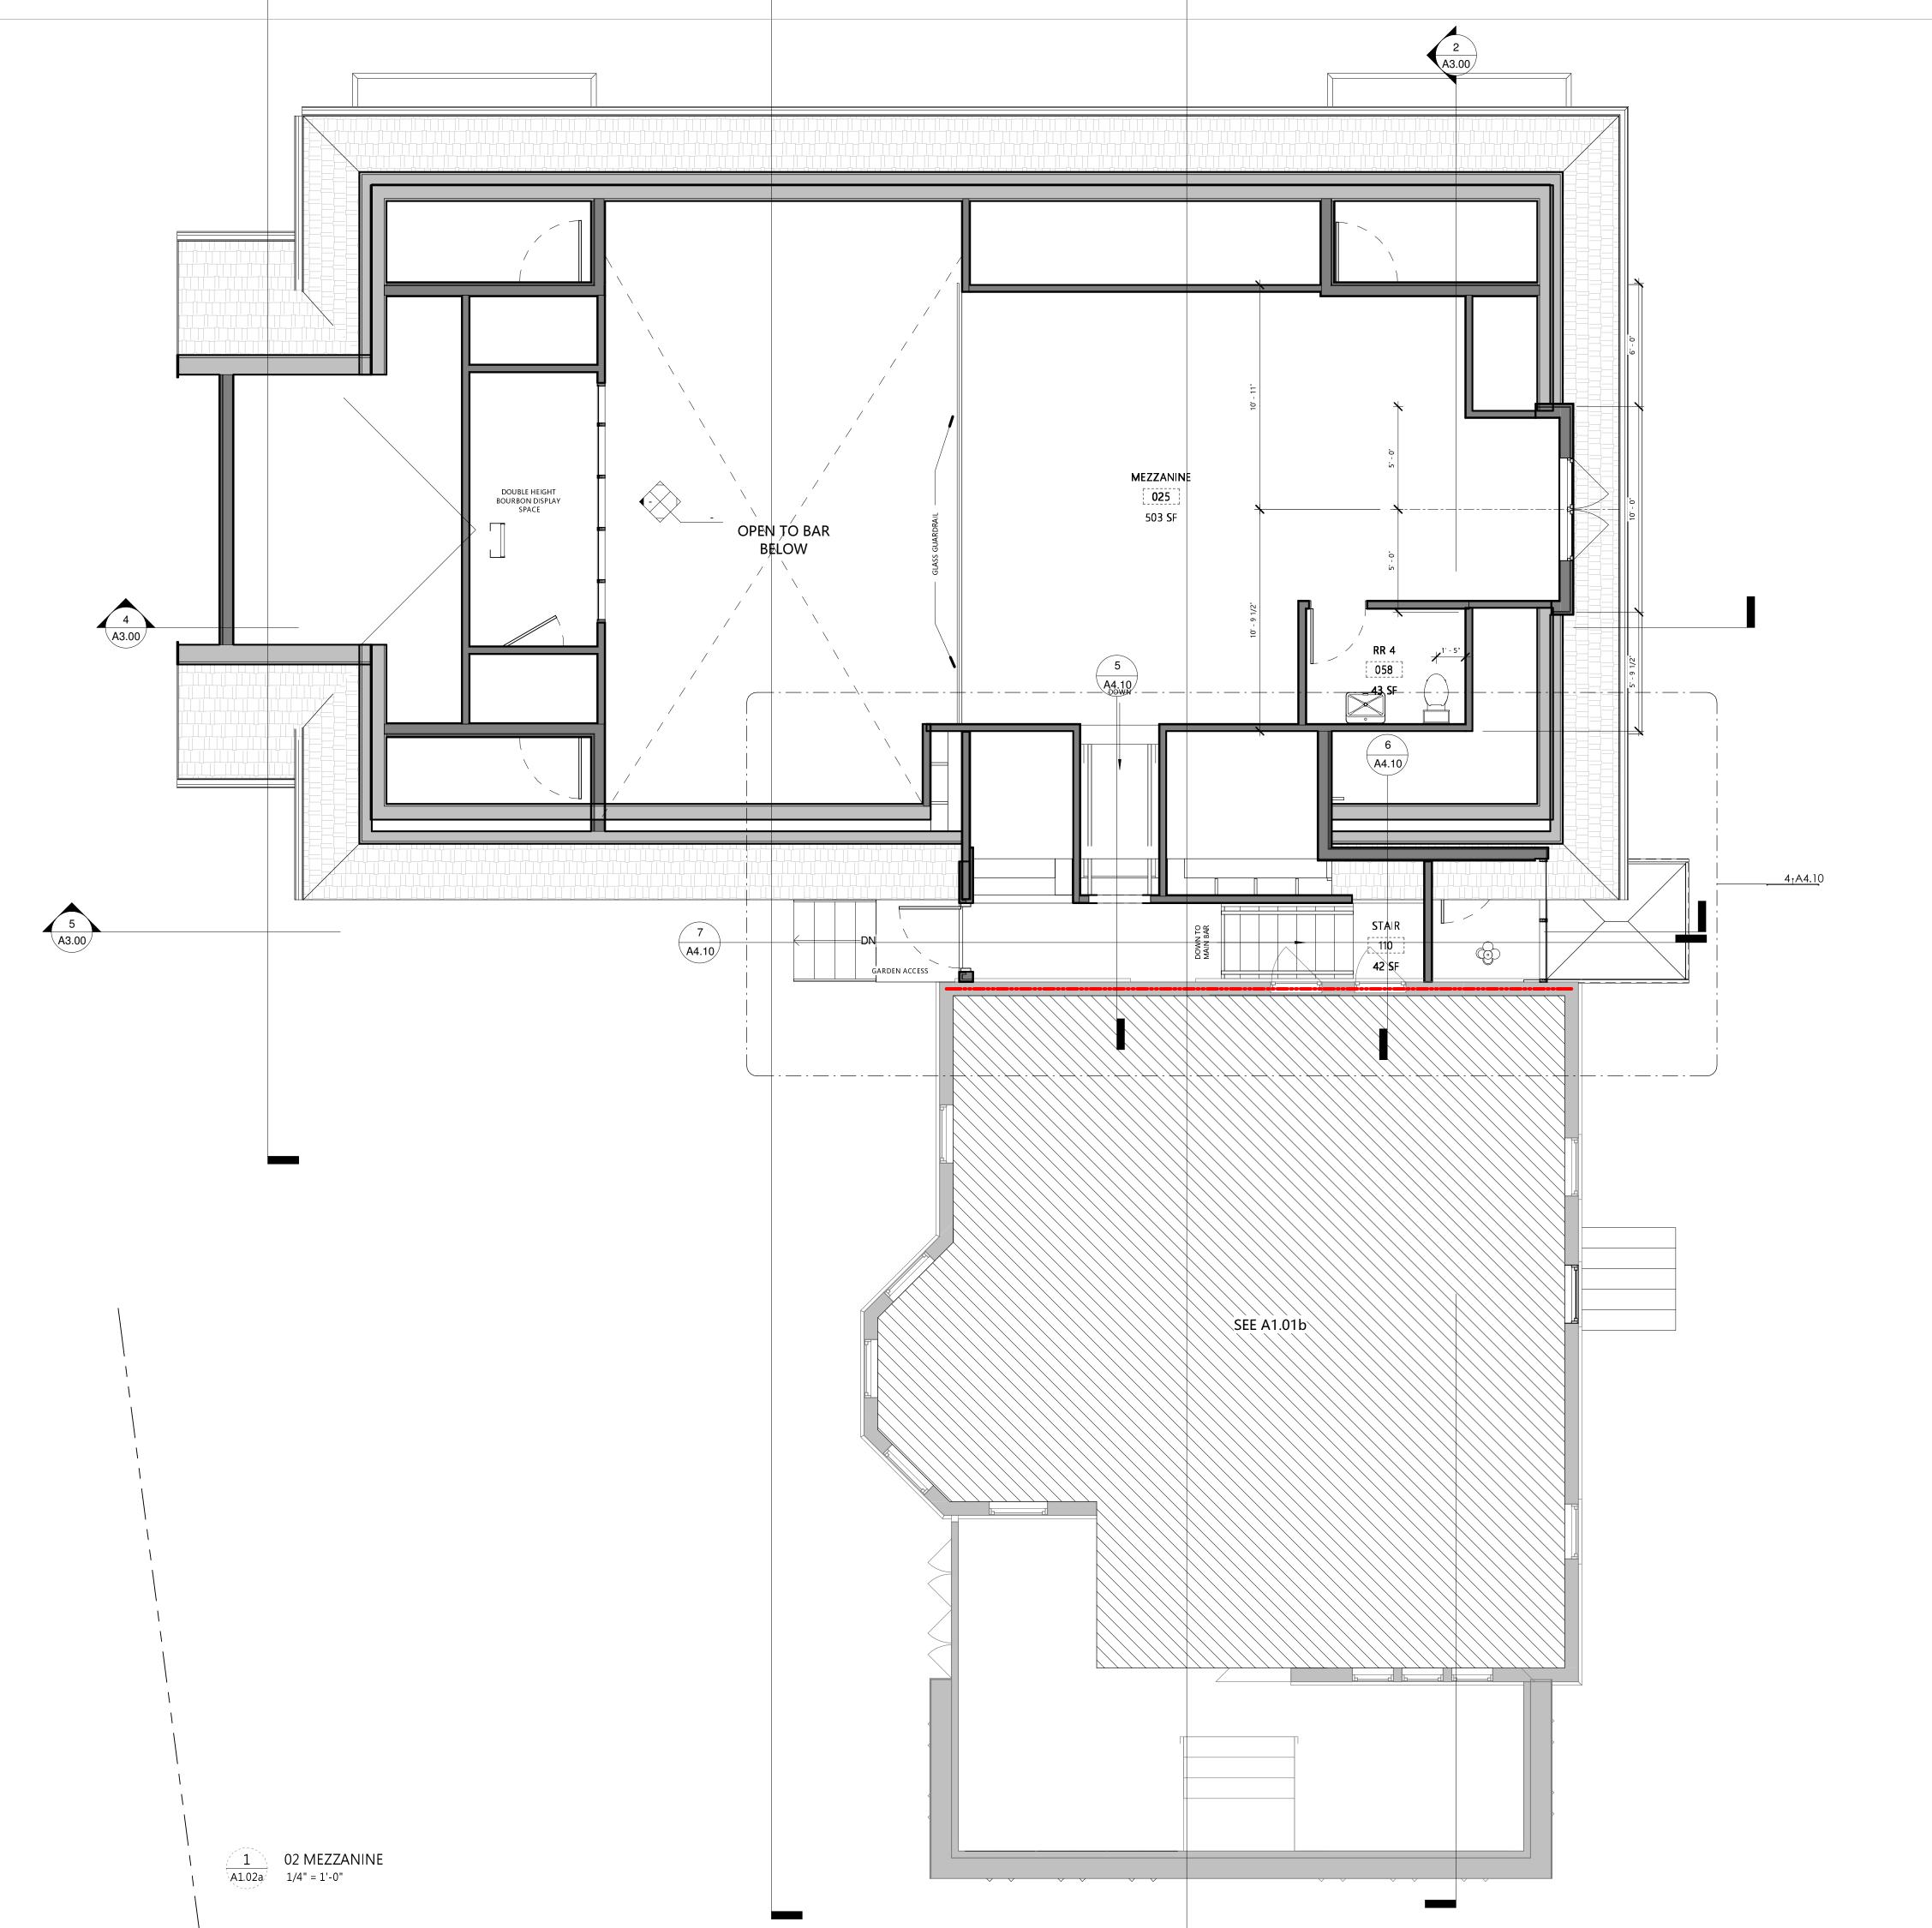
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PRELIMINARY

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# DATE REVISION

PROJECT TITLE

THE VENERY

80 E OLENTANGY STREET POWELL, OHIO 43065

PROJECT NO. SJM\_2010
ISSUE P&Z PRELIMINARY

SHEET TITLE

LEVEL 2 -MEZZANINE

03.05.2021

SHEET NO.

A1.02a

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#### FLOOR PLAN NOTES

#### NO.

EXTG. CRAWL SPACE CONDITIONS TO BE VERIFIED IN

FIELD. NEW 4" CIP CONC. SOG

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# DATE REVISION

PROJECT TITLE

#### THE VENERY

80 E OLENTANGY STREET POWELL, OHIO 43065

SJM\_2010


03.05.2021

PROJECT NO. ISSUE P&Z PRELIMINARY

**ISSUE DATE** SHEET TITLE

LEVEL 2 -**EXISTING ATTIC** 

SHEET NO.

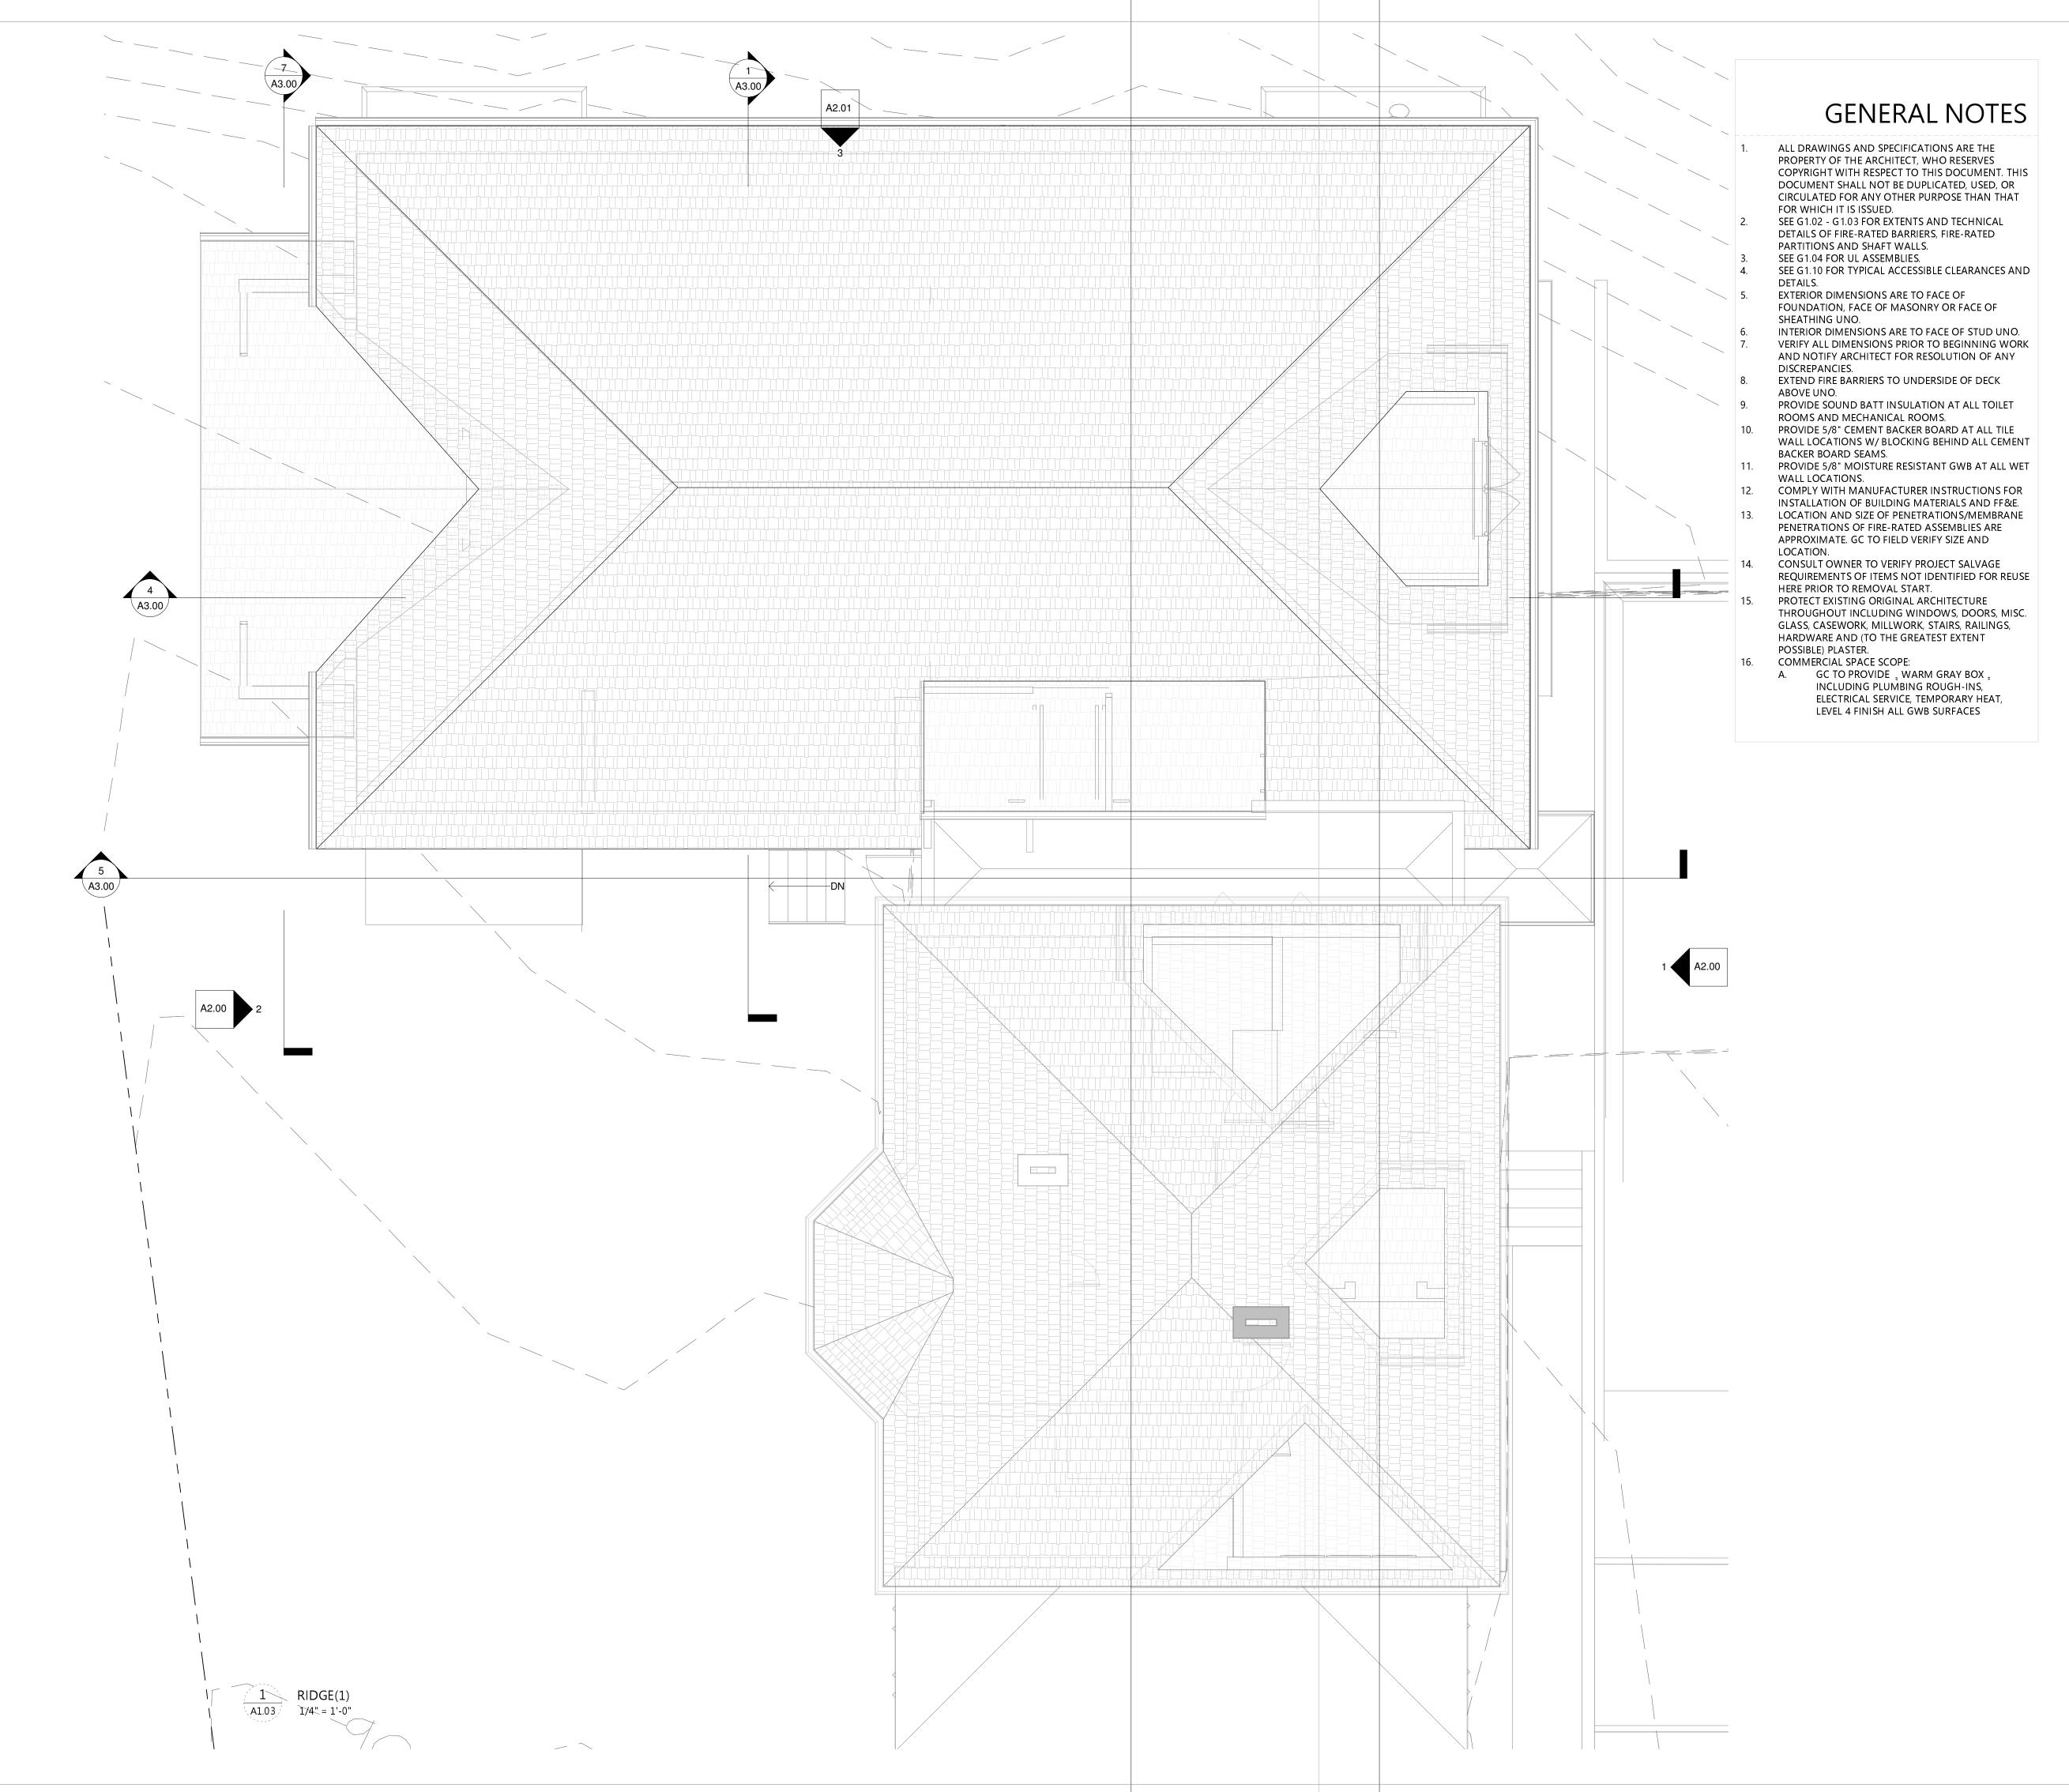

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# DATE REVISION

PROJECT TITLE

THE VENERY

80 E OLENTANGY STREET POWELL, OHIO 43065

SJM\_2010 PROJECT NO.


P&Z PRELIMINARY

ISSUE DATE

SHEET TITLE

**ROOF PLAN** 

SHEET NO.

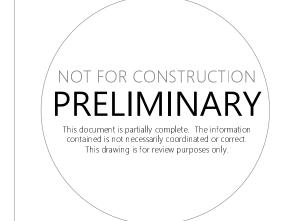

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# DATE REVISION

PROJECT TITLE

THE VENERY

80 E OLENTANGY STREET POWELL, OHIO 43065

SJM\_2010


PROJECT NO.

P&Z PRELIMINARY 03.05.2021 ISSUE DATE

SHEET TITLE

BUILDING **ELEVATIONS** 

SHEET NO.

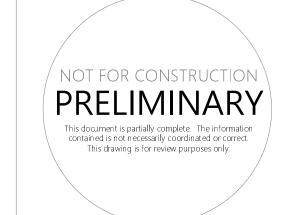

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PROJECT TITLE

THE VENERY

80 E OLENTANGY STREET POWELL, OHIO 43065

PROJECT NO. SJM\_2010

SUE P&Z PRELIMINARY

ISSUE DATE 03.05.2021

SHEET TITLE

BUILDING ELEVATIONS


SHEET NO.

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PROJECT NO. SJM\_2010 P&Z PRELIMINARY 03.05.2021 ISSUE DATE


SHEET TITLE **BUILDING** SECTIONS

SHEET NO.

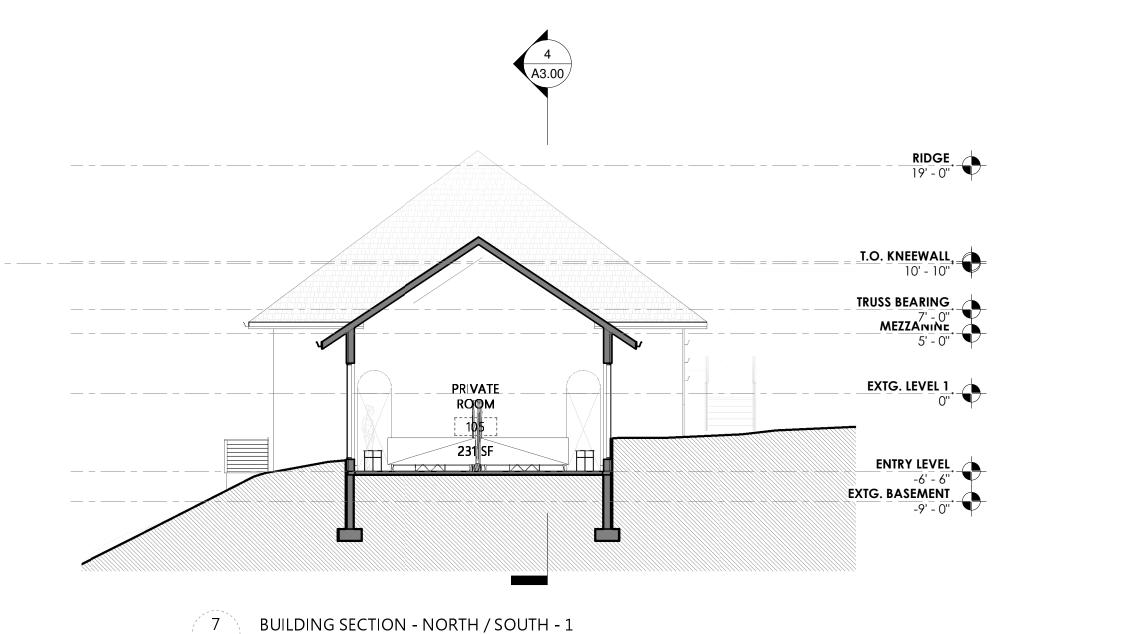


BUILDING SECTION - NORTH / SOUTH - 1


1/8" = 1'-0"

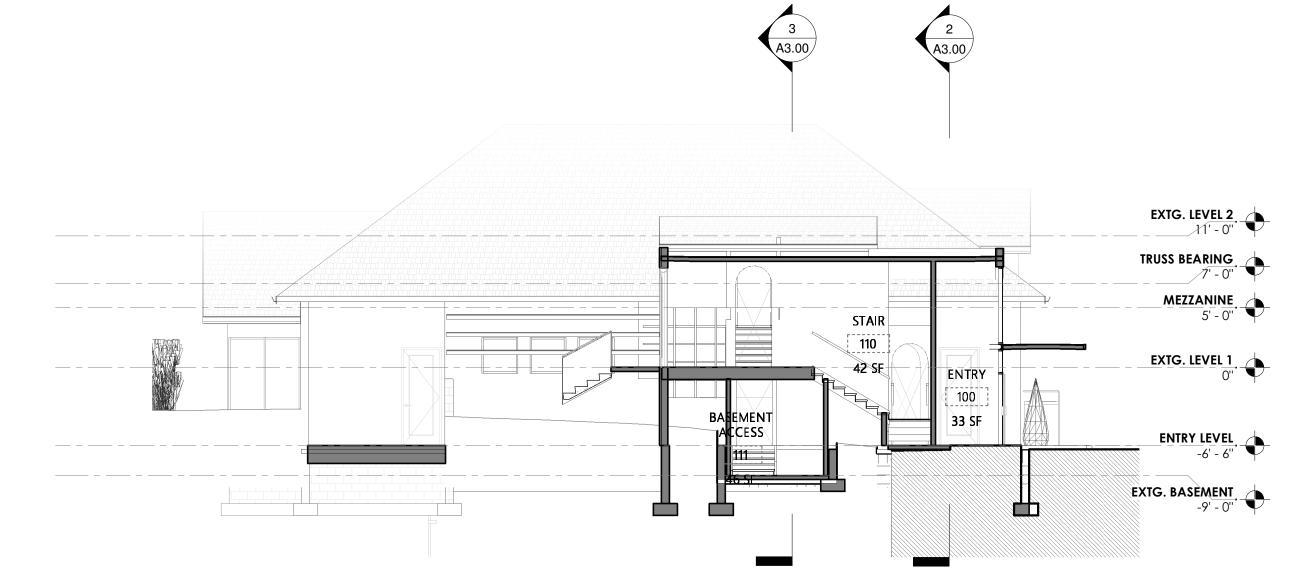


BUILDING SECTION - EAST/WEST 1

1/8" = 1'-0"

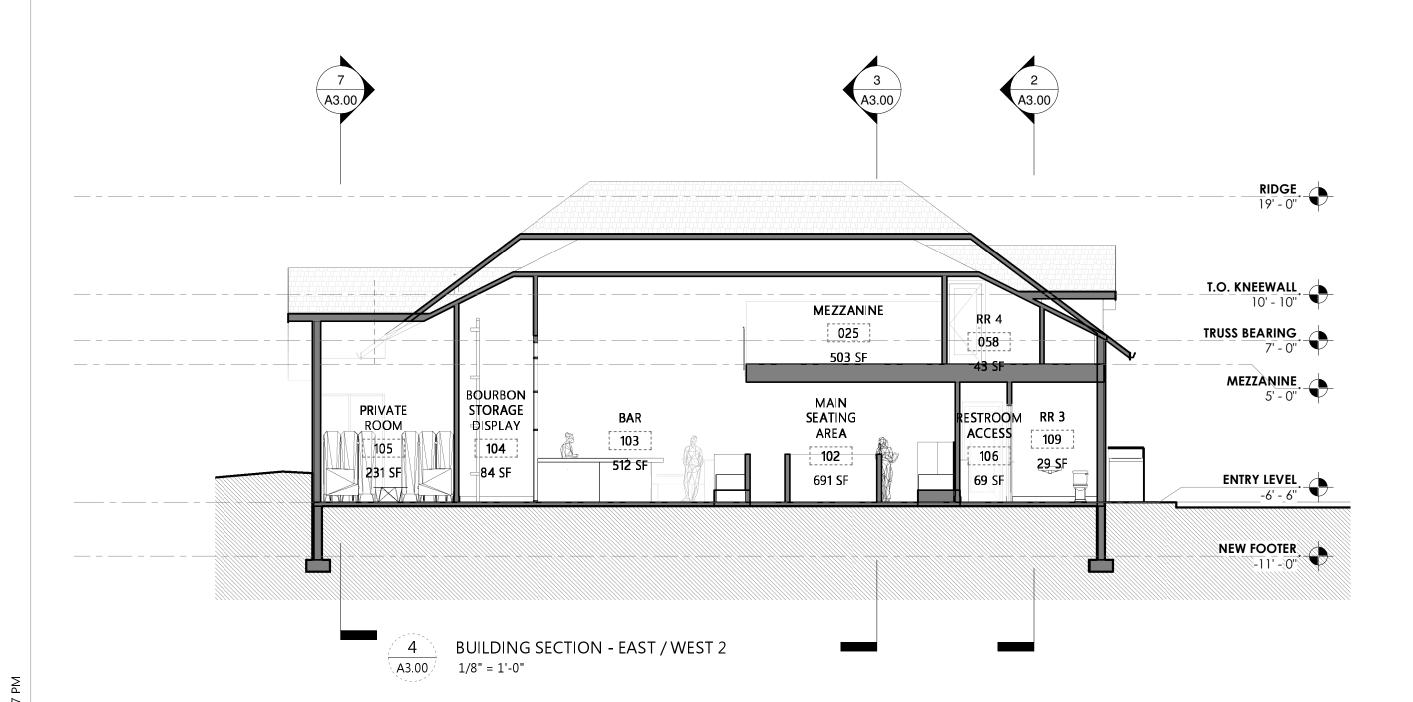

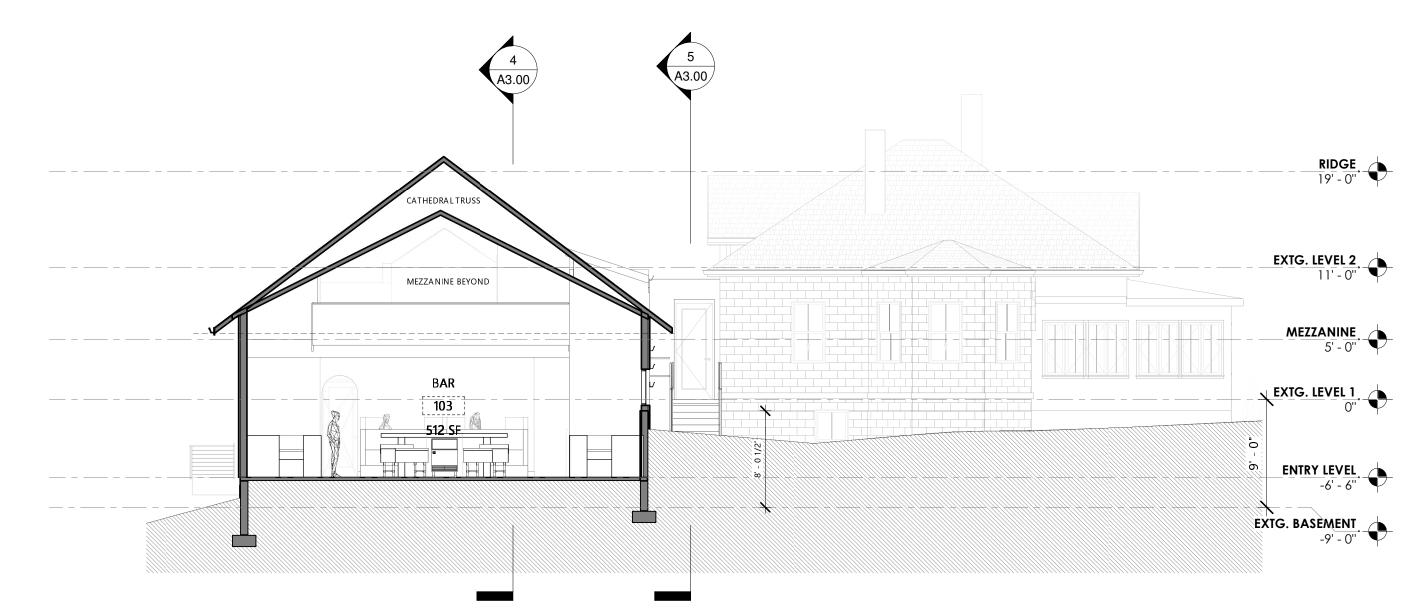


BUILDING SECTION - NORTH / SOUTH - 2 1/8" = 1'-0"

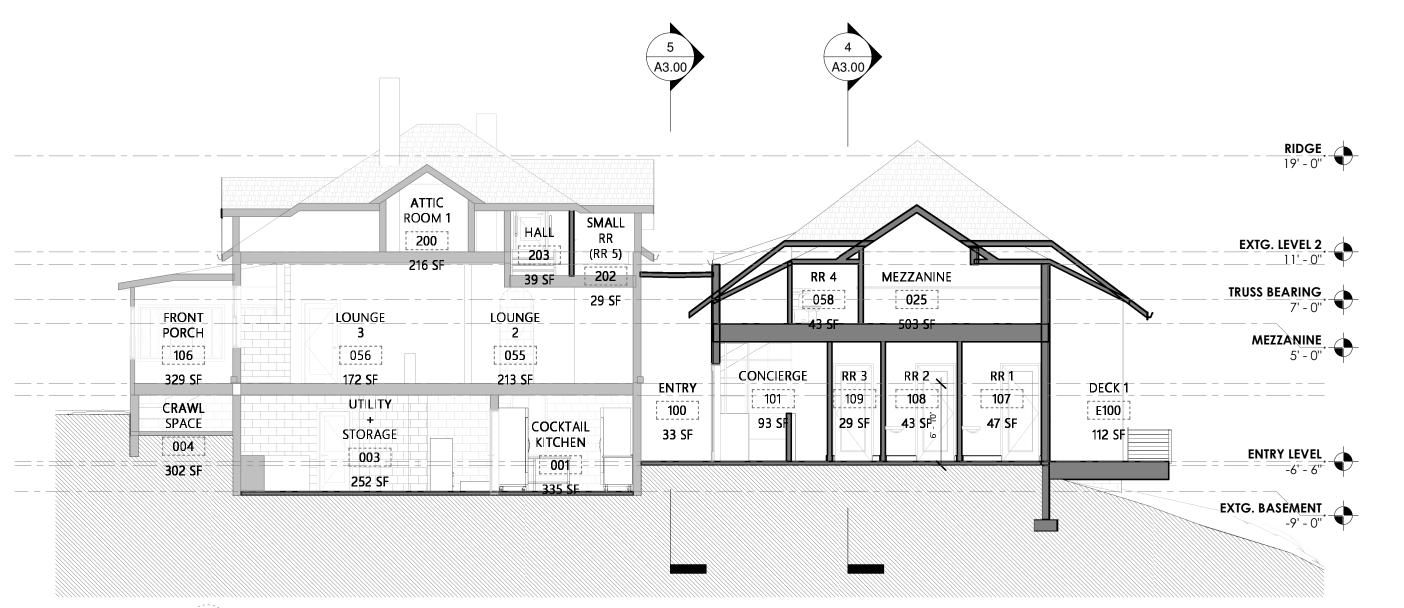

BUILDING SECTION - NORTH / SOUTH 3

1/8" = 1'-0"

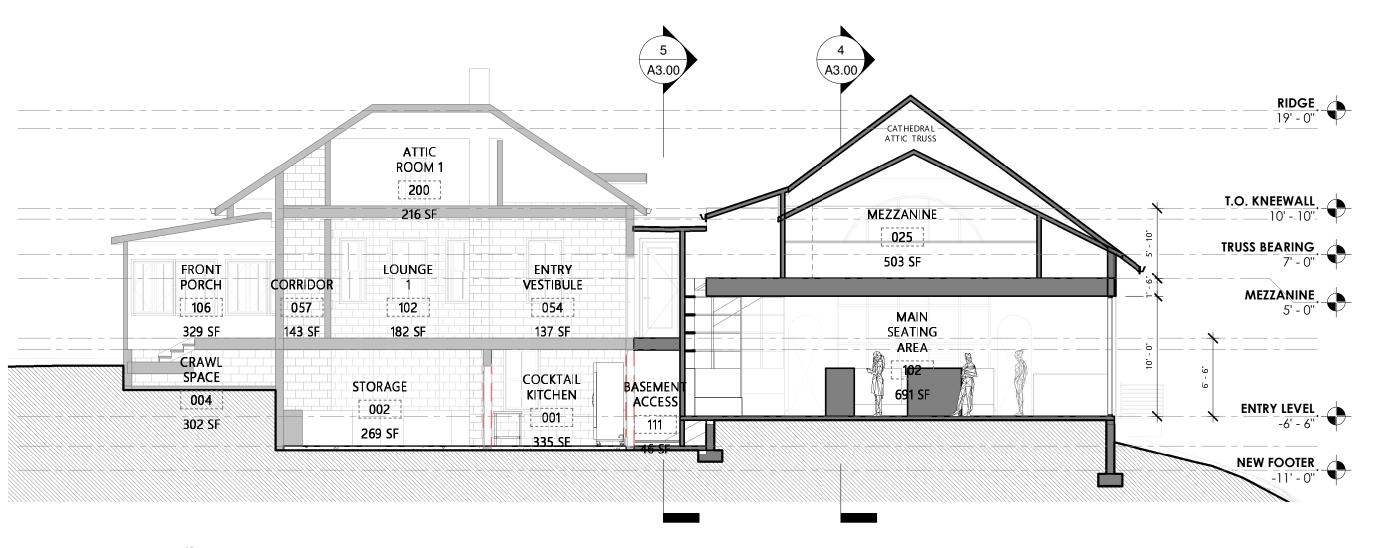

BUILDING SECTION - NORTH / SOUTH 4

1/8" = 1'-0"



March 5, 2021

Mr. and Mrs. Michael Bonasera 4200 Macduff Way Dublin, OH 43016

To Whom It May Concern,

Please be advised that FC Bank has approved Mr. and Mrs. Bonasera for financing to facilitate construction at 80 E. Olentangy St. in Powell. FC Bank has reviewed the personal financial qualifications of Mr. and Mrs. Bonasera, as well as all relative information related to the project at 80 E. Olentangy St. FC Bank views Mr. and Mrs. Bonasera as well qualified borrowers, and looks forward to partnering with them on this project.

Should any additional information relative to the qualifications of Mr. and Mrs. Bonasera be needed, please contact me directly.

Sincerely,

— DocuSigned by:

Bernic McGuinness

--- EC53F241CA9C4DD...

Bernie McGuinness Vice President Commercial Banking (614) 468-5589 ph. Bernard.McGuinness@FCBank.Bank