

# BOARD OF ZONING APPEALS (BZA) CONDITIONAL USE PERMIT APPLICATION

ALL ITEMS ON THIS APPLICATION MUST BE COMPLETED.

Application Fee: \$400.00\* Per Fee Ordinance 2019-49

\*Does not include transcript cost.

Applicant:		
Address/City/State/Zip:		
Email Address:		
Phone No:	Cell Phone No:	Fax No:
Property Owner:		
Address/City/State/Zip:		
Email Address:		
Phone No:	Cell Phone No:	Fax No:
Architect/Designer for Applicant:		
Email Address:		
Phone No:	Cell Phone No:	Fax No:
Property Address:		
Lot Number/Subdivision:	Existing Use:	Proposed Use:
Reason for Administrative Review (attac	h necessary documents):	
,		
Checklist:		
☐ Legal description of the property.		
☐ Vicinity Map and site/plot plan as req	uired.	
	sed use. Please be very detailed regarding th	e proposed use.
☐ A narrative statement regarding com	npatibility of the proposed use with adjoining	properties and the overall plans for the City, and the standards as
outlined in Section 1129.03 of the Powel	ll Zoning Code. Include pertinent subject matt	ers as required.
☐ Provide any other information that ma	ay useful to the Planning and Zoning Commis	sion or City Staff in the space below or attach additional pages.
☐ <b>5 copies</b> of all drawings, text, any oth	ner items, and application, as well as any othe	er drawings or written material that will help the Administration and
the Board understand the nature of the p	proposal.	
☐ 1 digital copy (CD, USB, Email) of the	ne complete application packet.	
$\ \square$ Attach the required fee - \$400.00*		
☐ Post a public notice sign at least (10)	days prior to a public hearing or public meeting	ng, pursuant to ordinance 1107.035
Public notice sign details found here		

## APPROVAL SHALL EXPIRE AND MAY BE REVOKED IF CONSTRUCTION DOES NOT BEGIN WITHIN TWO (2) YEARS FROM THE DATE OF ISSUANCE OF APPROVAL.

I agree to grant the City Staff, the Commission, Board or Council considering this application access to the property that is the subject of this application for the purposes of reviewing this application and posting public notice for this application.

ture of Appellant:	
Office Use	Office Use
	Type/Date:
	Base Fee: \$400.00
Received	Prepared by:
	Reviewed by:
	PAYOR:
	RECIEPT#

City of Powell · 47 Hall Street · Powell, Ohio 43065 · (614) 885-5380 · (614) 885-5339 fax· www.cityofpowell.us



### Horse Power Farms

Phase 2 – remaining site build out

February 10, 2021

City of Powell - Development 47 Hall Street Powell, OH 43065

Attn: Elise Schellin // Development Planner

Elise,

Please find the attached drawings to be considered for a Conditional Use BZA approval for Horse Power Farms. The submittal shows the proposed intent to build out the remainder of the site which we is referred to as Phase 2. The master site plan is essentially the same as what was previously approved. The remaining 5 additional buildings (buildings 3-7) that make up Phase 2 are all condominium structures similar to buildings 1 and 2 that were built in Phase 1. The foot print of these buildings have been modified slightly from the previous master plan to allow more development of the site. The new site plan reflects the shifted curb cut on Home Rd to align with the curb cut across the street, there is also a proposed entry gate that will be added to the west side of building 1. The essential character and spirit of the original Phase 1 design of a high finish architecture will be continued through Phase 2 by matching materials, design aesthetics, and lighting of the Phase 1 design.

The proposed continued conditional use is for the construction of a Sportsmans Club. This development was originally discussed to be built in phases, this application completes the remaining phases on site. The Sportsmans club shall consist of one Clubhouse building and several separate buildings, each subdivided into condominium units. These condominium units will be offered for sale.

The HorsePower Farms development fits in well in the existing area as it will be constructed to mimic a rural farm complete with fencing and pond. The parcel of land that was selected for the development is a leftover parcel with encroaching AEP easements and unusual shapes. The property has 345 kV High Tension power lines running diagonally through the entire property,



rendering residential development not feasible. Numerous residential developers considered the property for development but could not cost effectively subdivide the parcel.

The HorsePower Farms development will have minimal impact on traffic. Our traffic study indicates an average of 1 vehicle per hour to access the property. HorsePower Farms will have a nominal impact of sound to the adjoining properties. The owners of the condominiums shall be prohibited from running unmuffled engines in the Condominium Association bylaws. HorsePower Farms will be illuminated by LED "Tulip" style security lights positioned to shine away from neighboring properties. Once construction is complete, HorsePower Farms will not generate any objectionable odor, fumes or vibrations.

Legal description of the property; 319-230-02-001-000, 25001 Liberty S

#### 1129.03 - GENERAL STANDARDS FOR ALL CONDITIONAL USES.

The Board of Zoning Appeals, shall review the particular facts and circumstances of each proposed conditional use and shall approve the application for a Conditional Use Permit only when it has determined that there has been adequate evidence presented to show that such use at the proposed location:

(a) Is in fact a conditional use as listed in the Schedule of District Regulations in this Zoning Ordinance for the zoning district in which the site is located;

The proposed conditional use is for the creation of a Sportsman's Club in accordance with the existing FR-1 zoning. 8.04. E Public or Private Golf Courses, Country Clubs, Hunt Clubs, Sportsmen's Clubs, Fishing Lakes or Similar Recreational Uses with all buildings and club houses incident thereto, including restaurants to serve members and/or users of the facility, provided that sufficient land area is available to accommodate the proposed use. A Site Plan shall be prepared and submitted for consideration by the Board of Zoning Appeals and shall provide screening adjacent to residential area.

(b) Will be in accord with the general objectives, or with any specific objective, of the comprehensive plan and the Zoning Ordinance;

The comprehensive plan calls for this property to be single family residential. As described elsewhere in this application, this property is unsuitable for residential development. The Future Land Use Plan shows the area north of this site to be a conservation development. This development is essentially a hybrid; HorsePower Farms brings the pride and responsibility of property ownership, properly managed common areas and features of the preservation



development model including preserved open spaces, a developer funded public multi use path and naturalized greenspace.

(c) Will be designed, constructed, operated, and maintained so as to be harmonious and appropriate in appearance with the existing or intended character of the general vicinity, and that such use will not change the essential character of the same area;

The condominium buildings contained in HorsePower Farms will be constructed to a high finish and standard. The Clubhouse will function initially as a sales office for the condominiums, but will transition as units are purchased into a management office and Clubhouse for member use. The existing character of the property is vacant land. The adjacent property to the South is that of a horse farm and riding stable. HorsePower Farms will enhance the essential character of the area by adding to and improving the rural, farm like setting.

(d) Will not be hazardous or disturbing to existing or future neighboring uses;

HorsePower Farms will not be hazardous to or disturb any future neighboring use.

(e) Will be served adequately by essential public facilities and services, such as highways, streets, police and fire protection, drainage structures, refuse disposal, water and sewer, and schools; or that the persons or agencies responsible for the establishment of the proposed use shall be able to provide adequately for such services;

Based on our traffic study, HorsePower Farms will be adequately serviced by the highways and streets. This development should create nominal demand for police and fire services. Our water retention plan should more than adequately handle generated water runoff. This development will have no impact on schools or other public service agencies. A common dumpster is contained on this development for use by property owners.

(f) Will not create excessive additional requirements at public cost for public facilities and services, and will not be detrimental to the economic welfare of the community;

HorsePower Farms will not place any additional demands on public facilities or services.



(g) Will not involve uses, activities, processes, materials, equipment and/or conditions of operation that will be detrimental to any persons, property, or the general welfare by reason of excessive production of traffic, noise, smoke, fumes, glare, or odors;

The HorsePower Farms development will have minimal impact on traffic. Our traffic study indicates an average of 1 vehicle per hour to access the property. HorsePower Farms will have a nominal impact of sound to the adjoining properties. The owners of the condominiums shall be prohibited from running unmuffled engines in the condominium association bylaws. HorsePower Farms will be illuminated by LED "Tulip" style security lights positioned to shine away from neighboring properties. Once construction is complete, HorsePower Farms will not generate any objectionable odor, noise, fumes or vibrations.

(h) Will have vehicular approaches to the property which shall be so designed as not to create an interference with traffic on surrounding public thoroughfares; and

The developer of HorsePower Farms has secured approval from the Delaware County Engineer's Office for final approval of the shape and size of the access driveway for the development.

(i) Will not result in the destruction, loss, or damage of a natural, scenic, or historic feature of major importance


The property where HorsePower Farms is located previously was pasture and was not scenic by most definitions. The introduction of fencing, naturalization of pasture and the pond will reintroduce natural and scenic views to the area.


Thank you for your consideration, I look forward to working with you on this project.

Dave Kaldy


President

archall architects

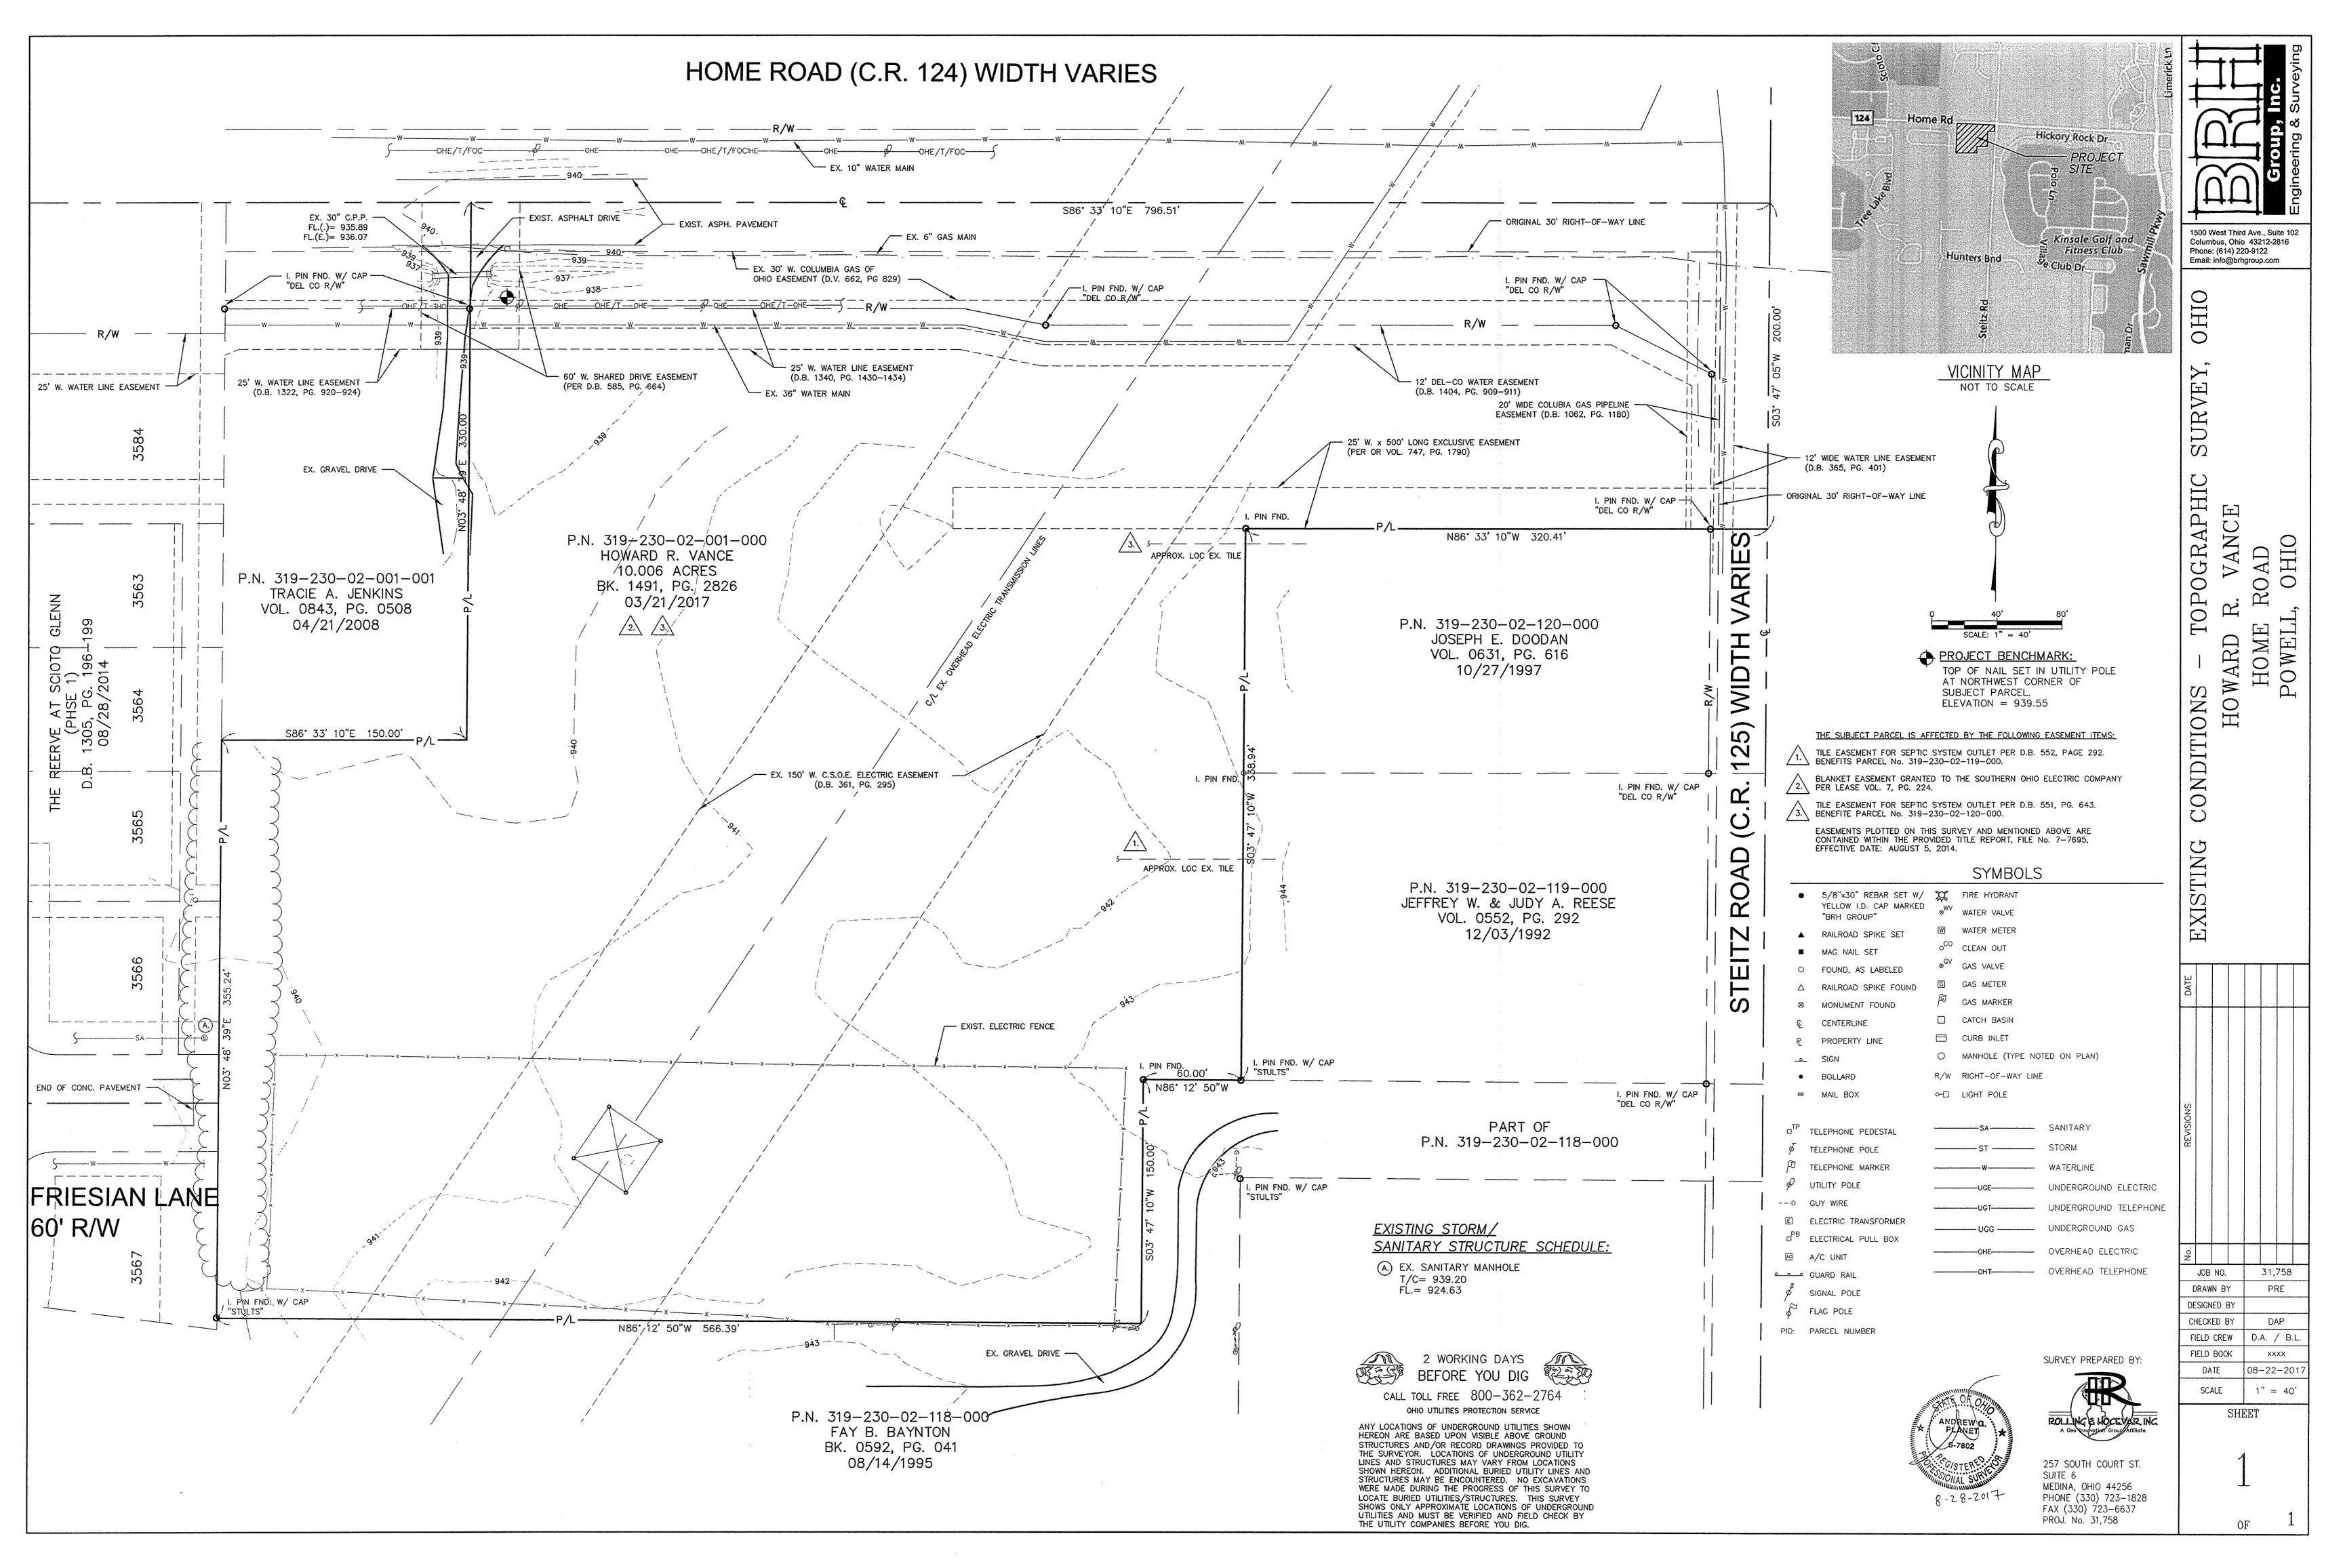

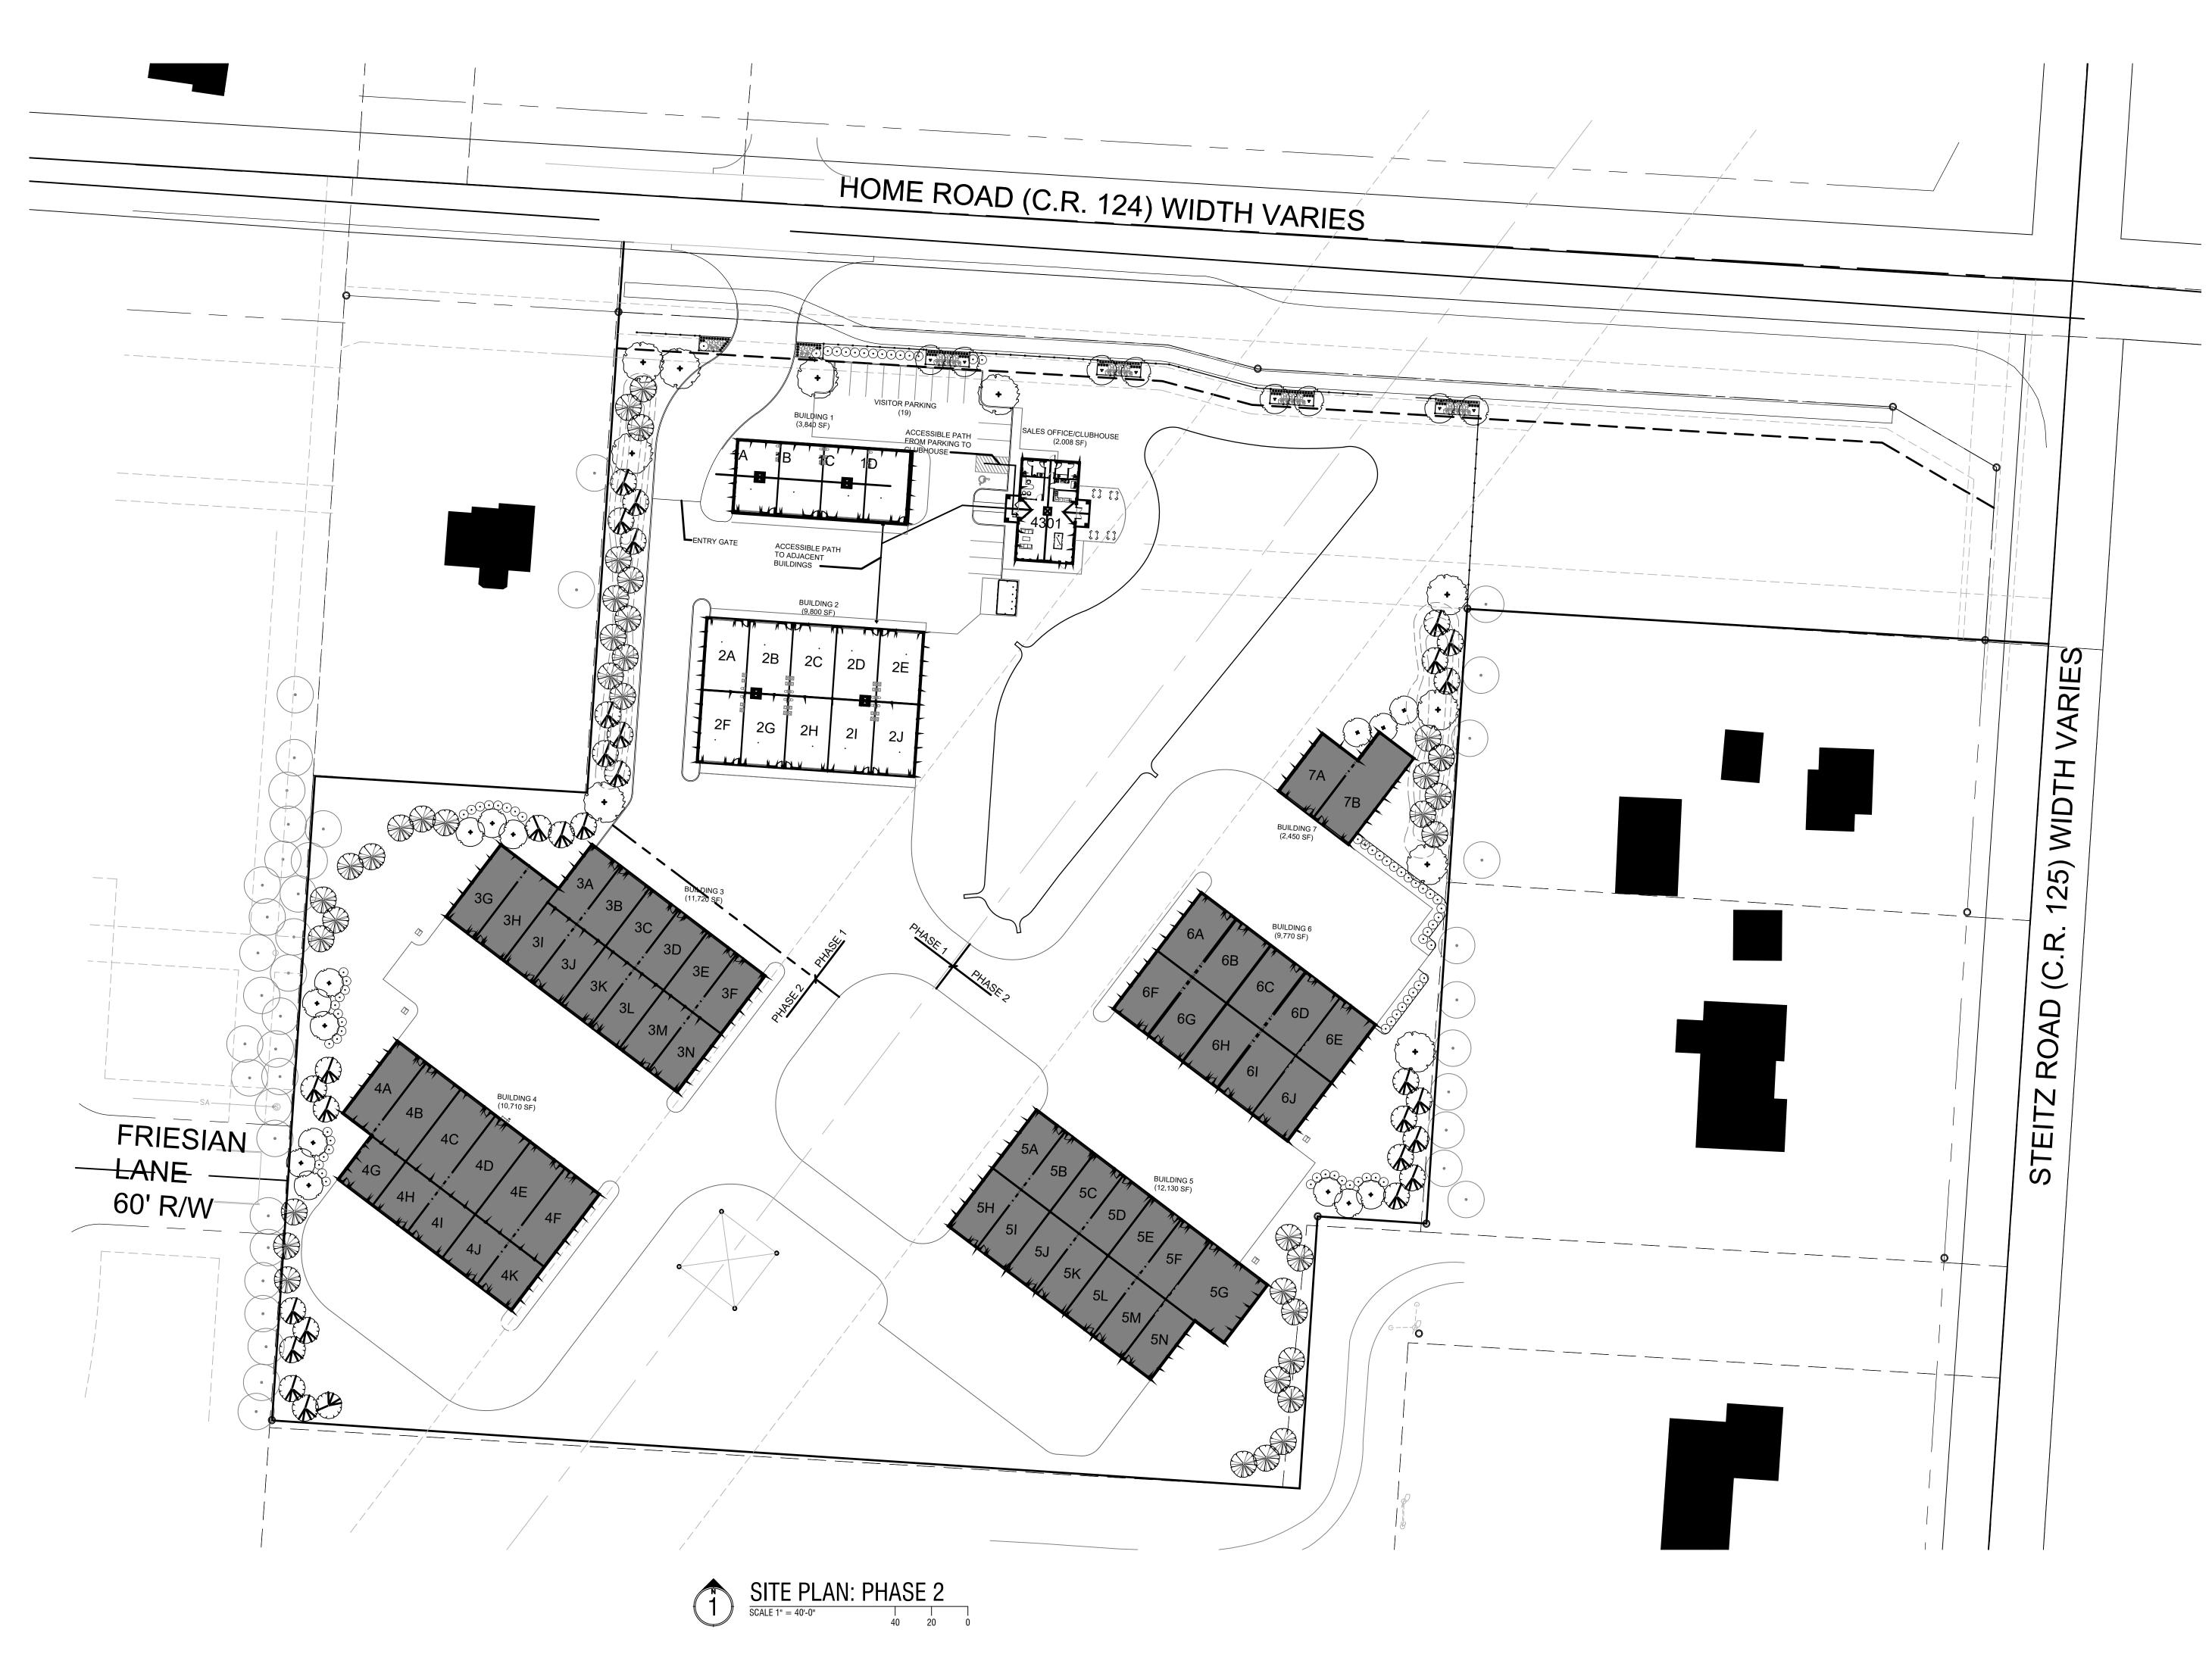



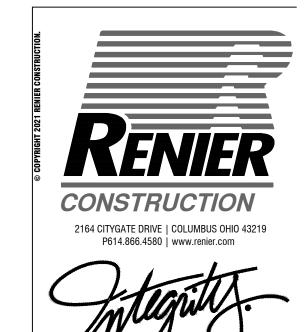

FARMS

HORSE POWER PHASE 2



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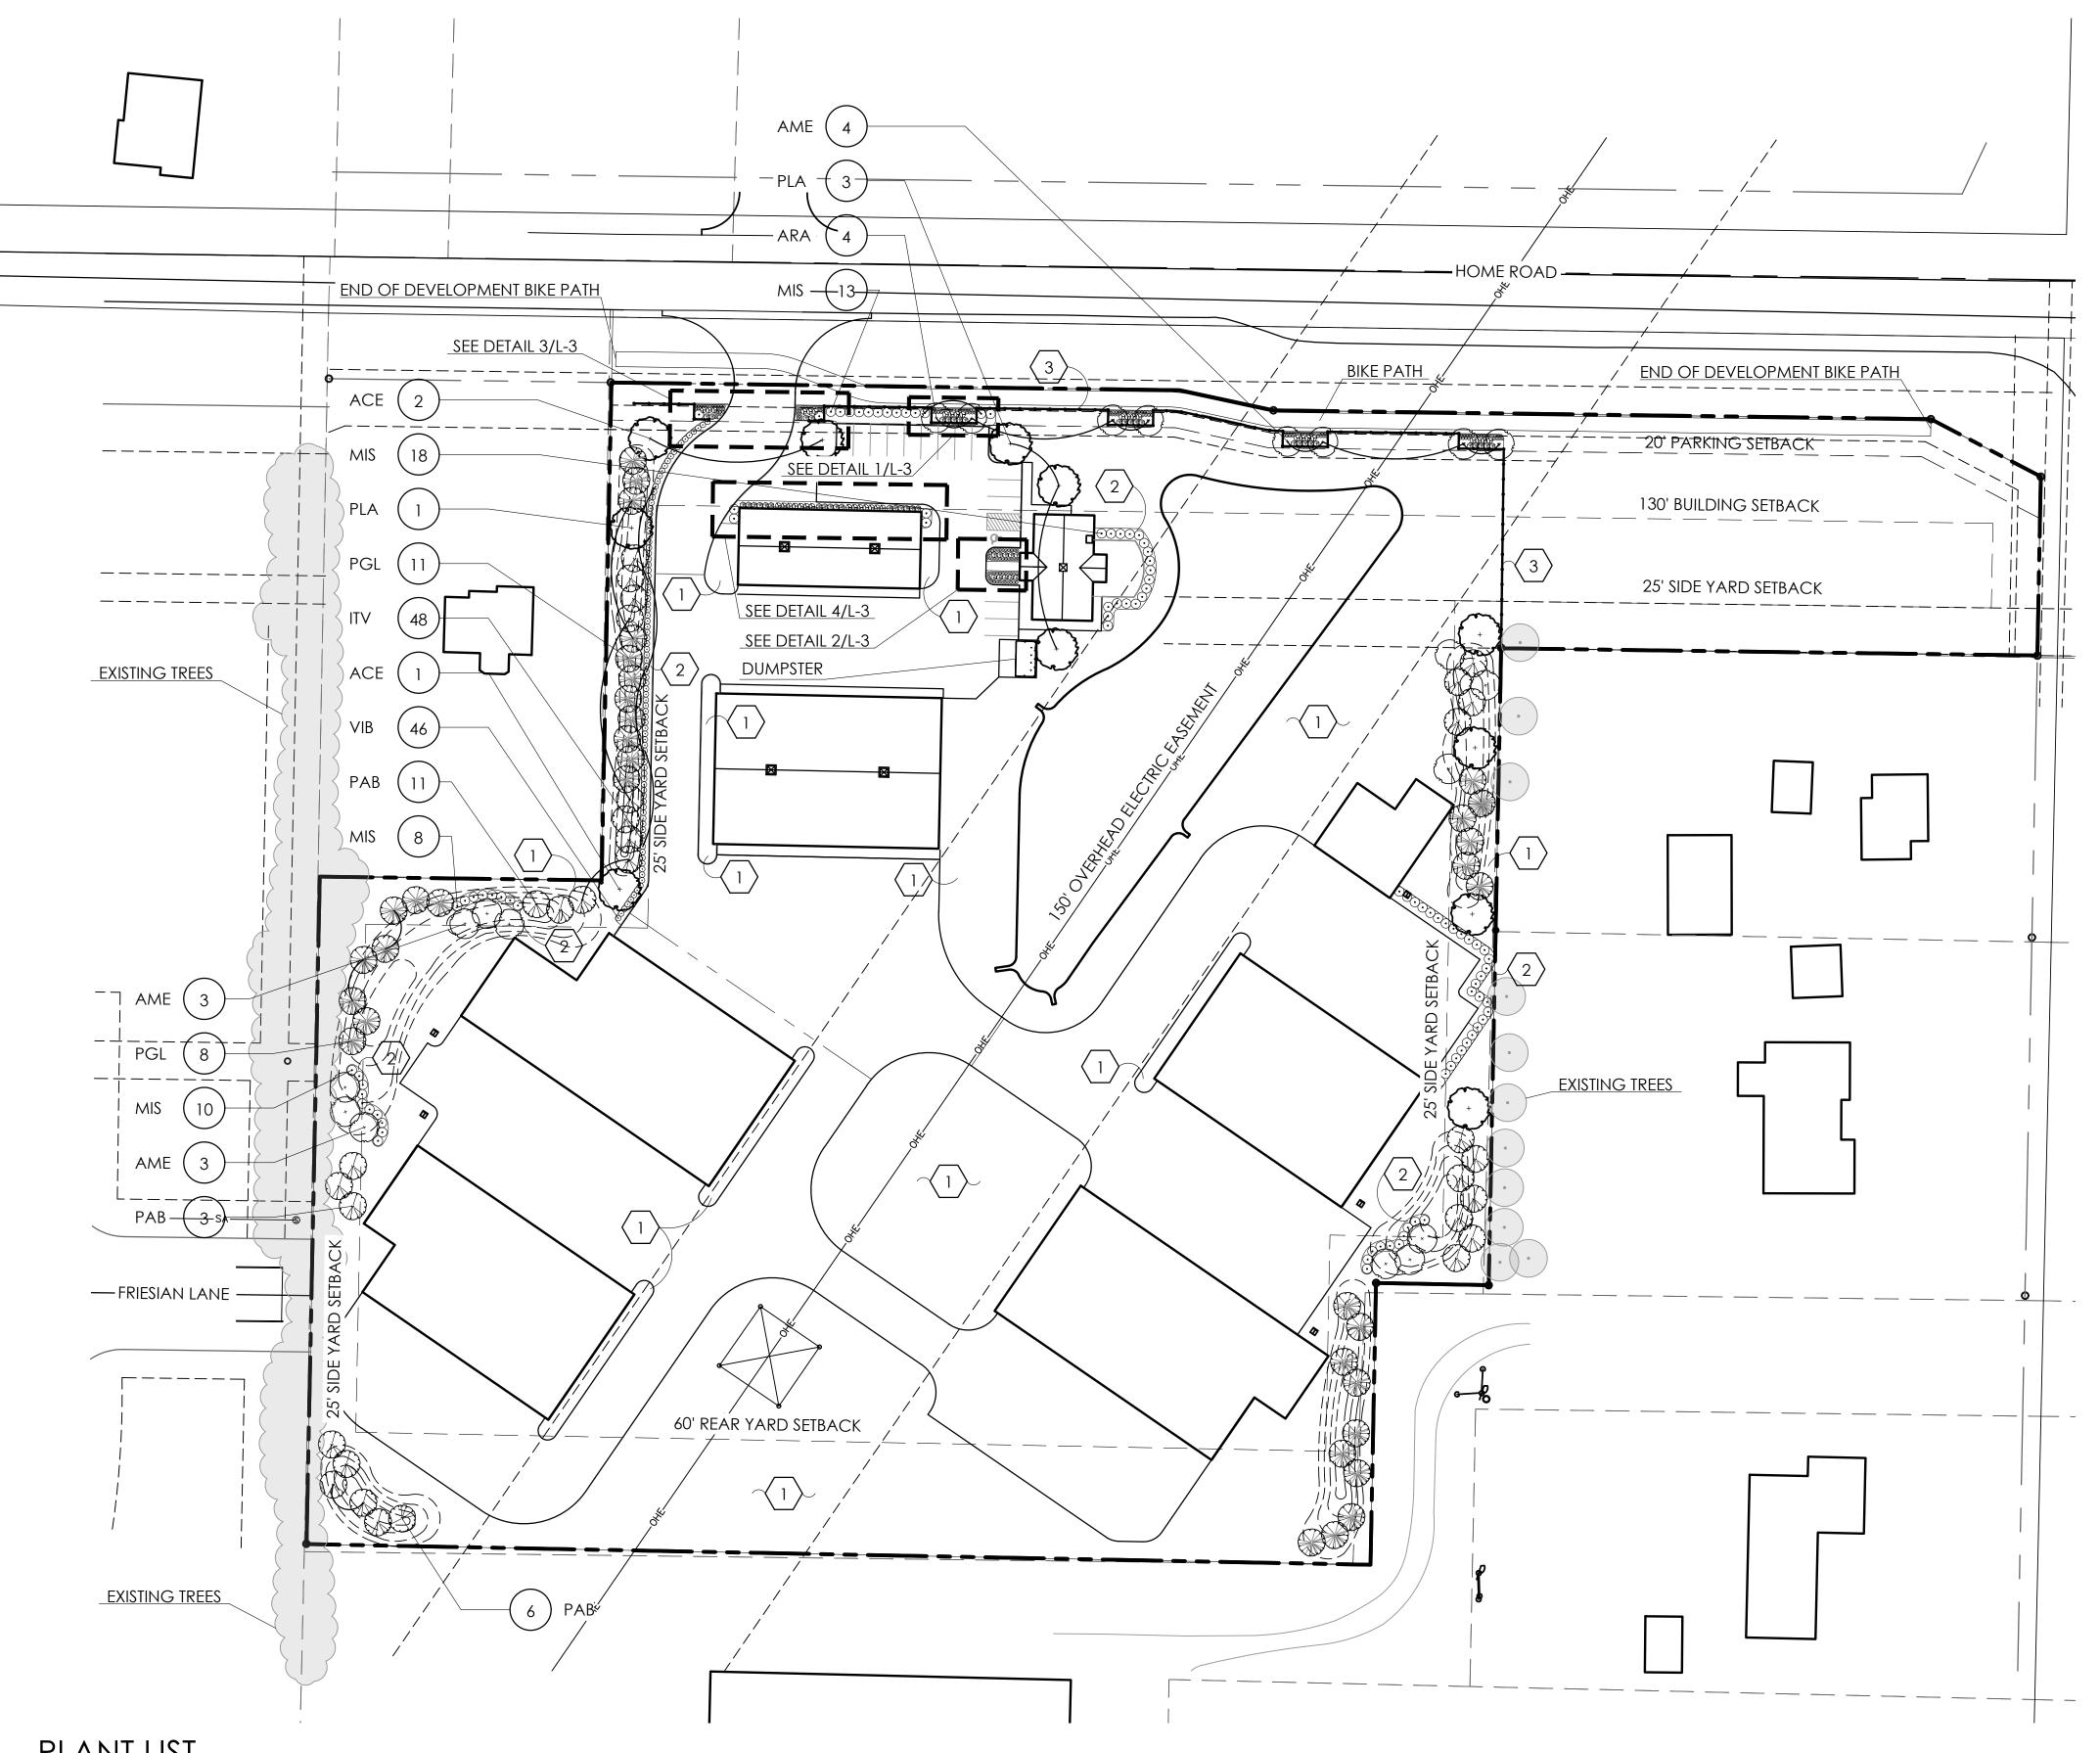
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SHEET TITLE

ARCHITECTURAL SITE PLAN

SHEET NUMBER

A1.01



PLANT LIST

(CONTRACTOR RESPONSIBLE FOR ALL PLANTS SHOWN ON PLAN) QTY KEY BOTANICAL NAME COND. REMARKS **COMMON NAME** SIZE TREES 20 PAB PICEA ABIES 6'-7' HGT. B&B NORWAY SPRUCE 19 | PGL | PICEA GLAUCA WHITE SPRUCE 6'-7' HGT. B&B PLATANUS X ACERIFOLIA 'BLOODGOOD' B&B BLOODGOOD LONDON PLANE TREE ACER X FREEMANII 'SIENNA' SIENNA GLEN MAPLE 2" CAL. B&B AMELANCHIER × GRANDIFLORA 'AUTUMN BRILLIANCE' AUTUMN BRILLIANCE SERVICEBERRY 6'-7' HGT. B&B 4 ARA ACER RUBRUM 'ARMSTRONG' ARMSTRONG RED MAPLE 6'-7' HGT. B&B SHRUBS 48 | ITV | ITEA VIRGINICA 'HENRY'S GARNET' HENRY'S GARNET SWEETSPIRE 1 GAL. CONT. 46 VIB VIBURNUM DENTATUM 'CHRISTOM' 18" HGT. B&B BLUE MUFFIN VIBURNUM PERENNIALS/ORNAMENTAL GRASSES CONT. GRACILLIMUS MAIDEN GRASS 49 MIS MISCANTHUS SINENSIS 'GRACILLIMUS' 1 GAL.

\*NOTE: ALL ENLARGEMENTS ON SHEET L-3 ARE INCLUDED IN PHASE 1 LANDSCAPING

# GENERAL PLANTING NOTES:


- 1. ALL PLANTS SHALL MEET OR EXCEED STANDARDS SET IN THE USA STANDARD FOR NURSERY STOCK.
- 2. ALL PLANTING OPERATIONS SHALL ADHERE TO THE AMERICAN ASSOCIATION OF NURSERYMEN STANDARDS.
- 3. PLANT LOCATIONS AND BEDS SHALL BE LOCATED BY CONTRACTOR AND APPROVED BY LANDSCAPE ARCHITECT PRIOR TO INSTALLATION.
- 4. PLANTING BEDS SHALL HAVE A MINIMUM 3" DEEP SHREDDED HARDWOOD BARK MULCH. MULCH HEDGES IN A CONTINUOUS BED.
- 5. ALL PLANTING BEDS TO BE TILLED TO A MINIMUM DEPTH OF 12".
- 6. ALL PLANTING BEDS TO BE FERTILIZED WITH 10-10-10 OR APPROVED EQUAL.
- 7. SODDING / SEEDING BY LANDSCAPE CONTRACTOR.
- 8. THE LOCATION OF THE EXISTING UNDERGROUND UTILITIES ARE SHOWN IN AN APPROXIMATE WAY ONLY AND HAVE NOT BEEN INDEPENDENTLY VERIFIED BY THE OWNER OR ITS REPRESENTATIVE. THE CONTRACTOR SHALL DETERMINE THE EXACT LOCATION OF ALL EXISTING UTILITIES PRIOR TO COMMENCING WORK AND AGREES TO BE FULLY RESPONSIBLE FOR ANY AND ALL DAMAGES WHICH MIGHT BE OCCASIONED BY THE CONTRACTOR'S FAILURE TO EXACTLY LOCATE AND PRESERVE ANY AND ALL UNDERGROUND UTILITIES.
- 9. ALL AREAS DISTURBED BY CONSTRUCTION ARE TO BE RESTORED, FINE GRADED AND SEEDED/ SODDED.
- 10. ALL EXISTING PLANT MATERIAL SHOWN ON THIS PLAN IS TO BE PRESERVED UNLESS SPECIFICALLY NOTED OTHERWISE.

# **CONSTRUCTION NOTES:**

- LAWN AREA, PROVIDE POSITIVE DRAINAGE ACROSS ALL SURFACES.
- 2 LANDSCAPE AREA, PROVIDE POSITIVE DRAINAGE ACROSS ALL SURFACES.
- 3 3 RAIL BLACK HORSE FENCE SEE SHEET L-4/DETAIL 4

# PLANT KEY TYPICALS


SEE PLANT LIST FOR SPECIFIC PLANT SPECIES - ORNAMENTAL TREE - LARGE DECIDUOUS SHRUB - EXISTING TREE - EVERGREEN SHRUB - DECIDUOUS SHRUB - EVERGREEN TREE PERENNIALS GROUNDCOVER SHADE TREE

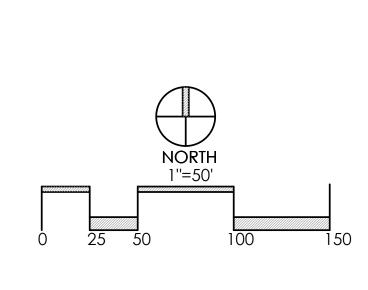

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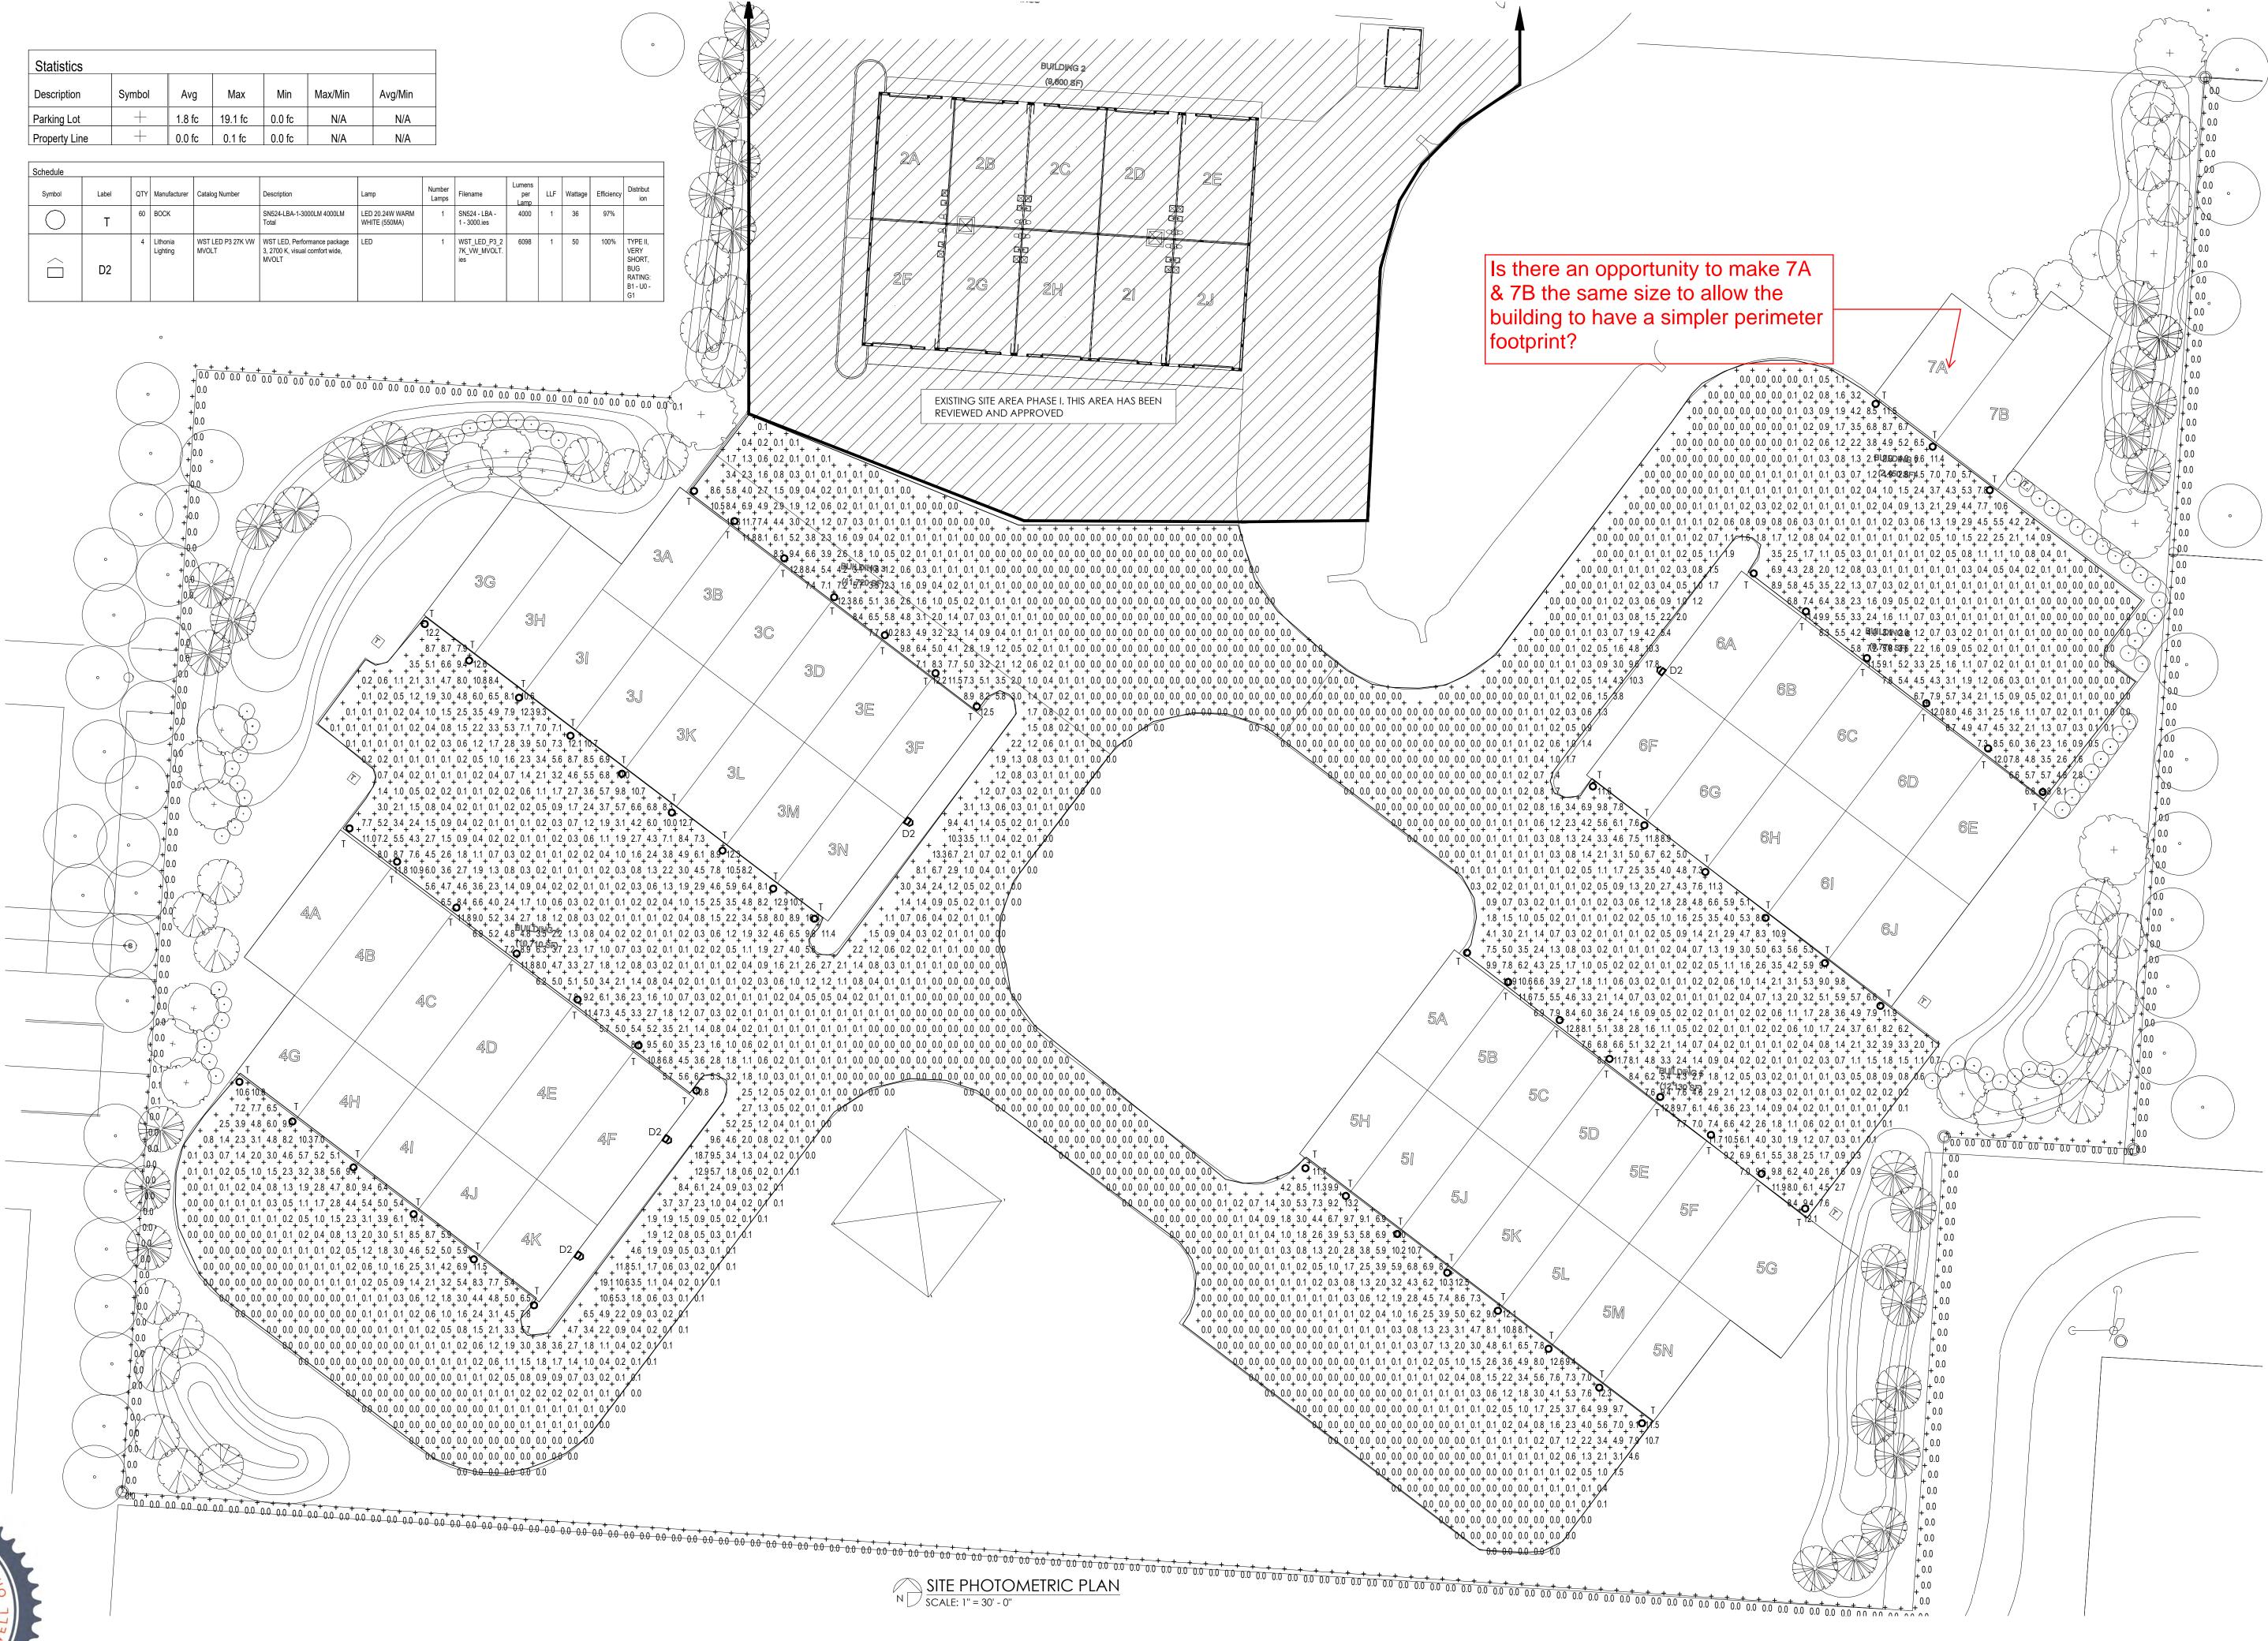
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2/10/21 PROJECT 18160 SHEET

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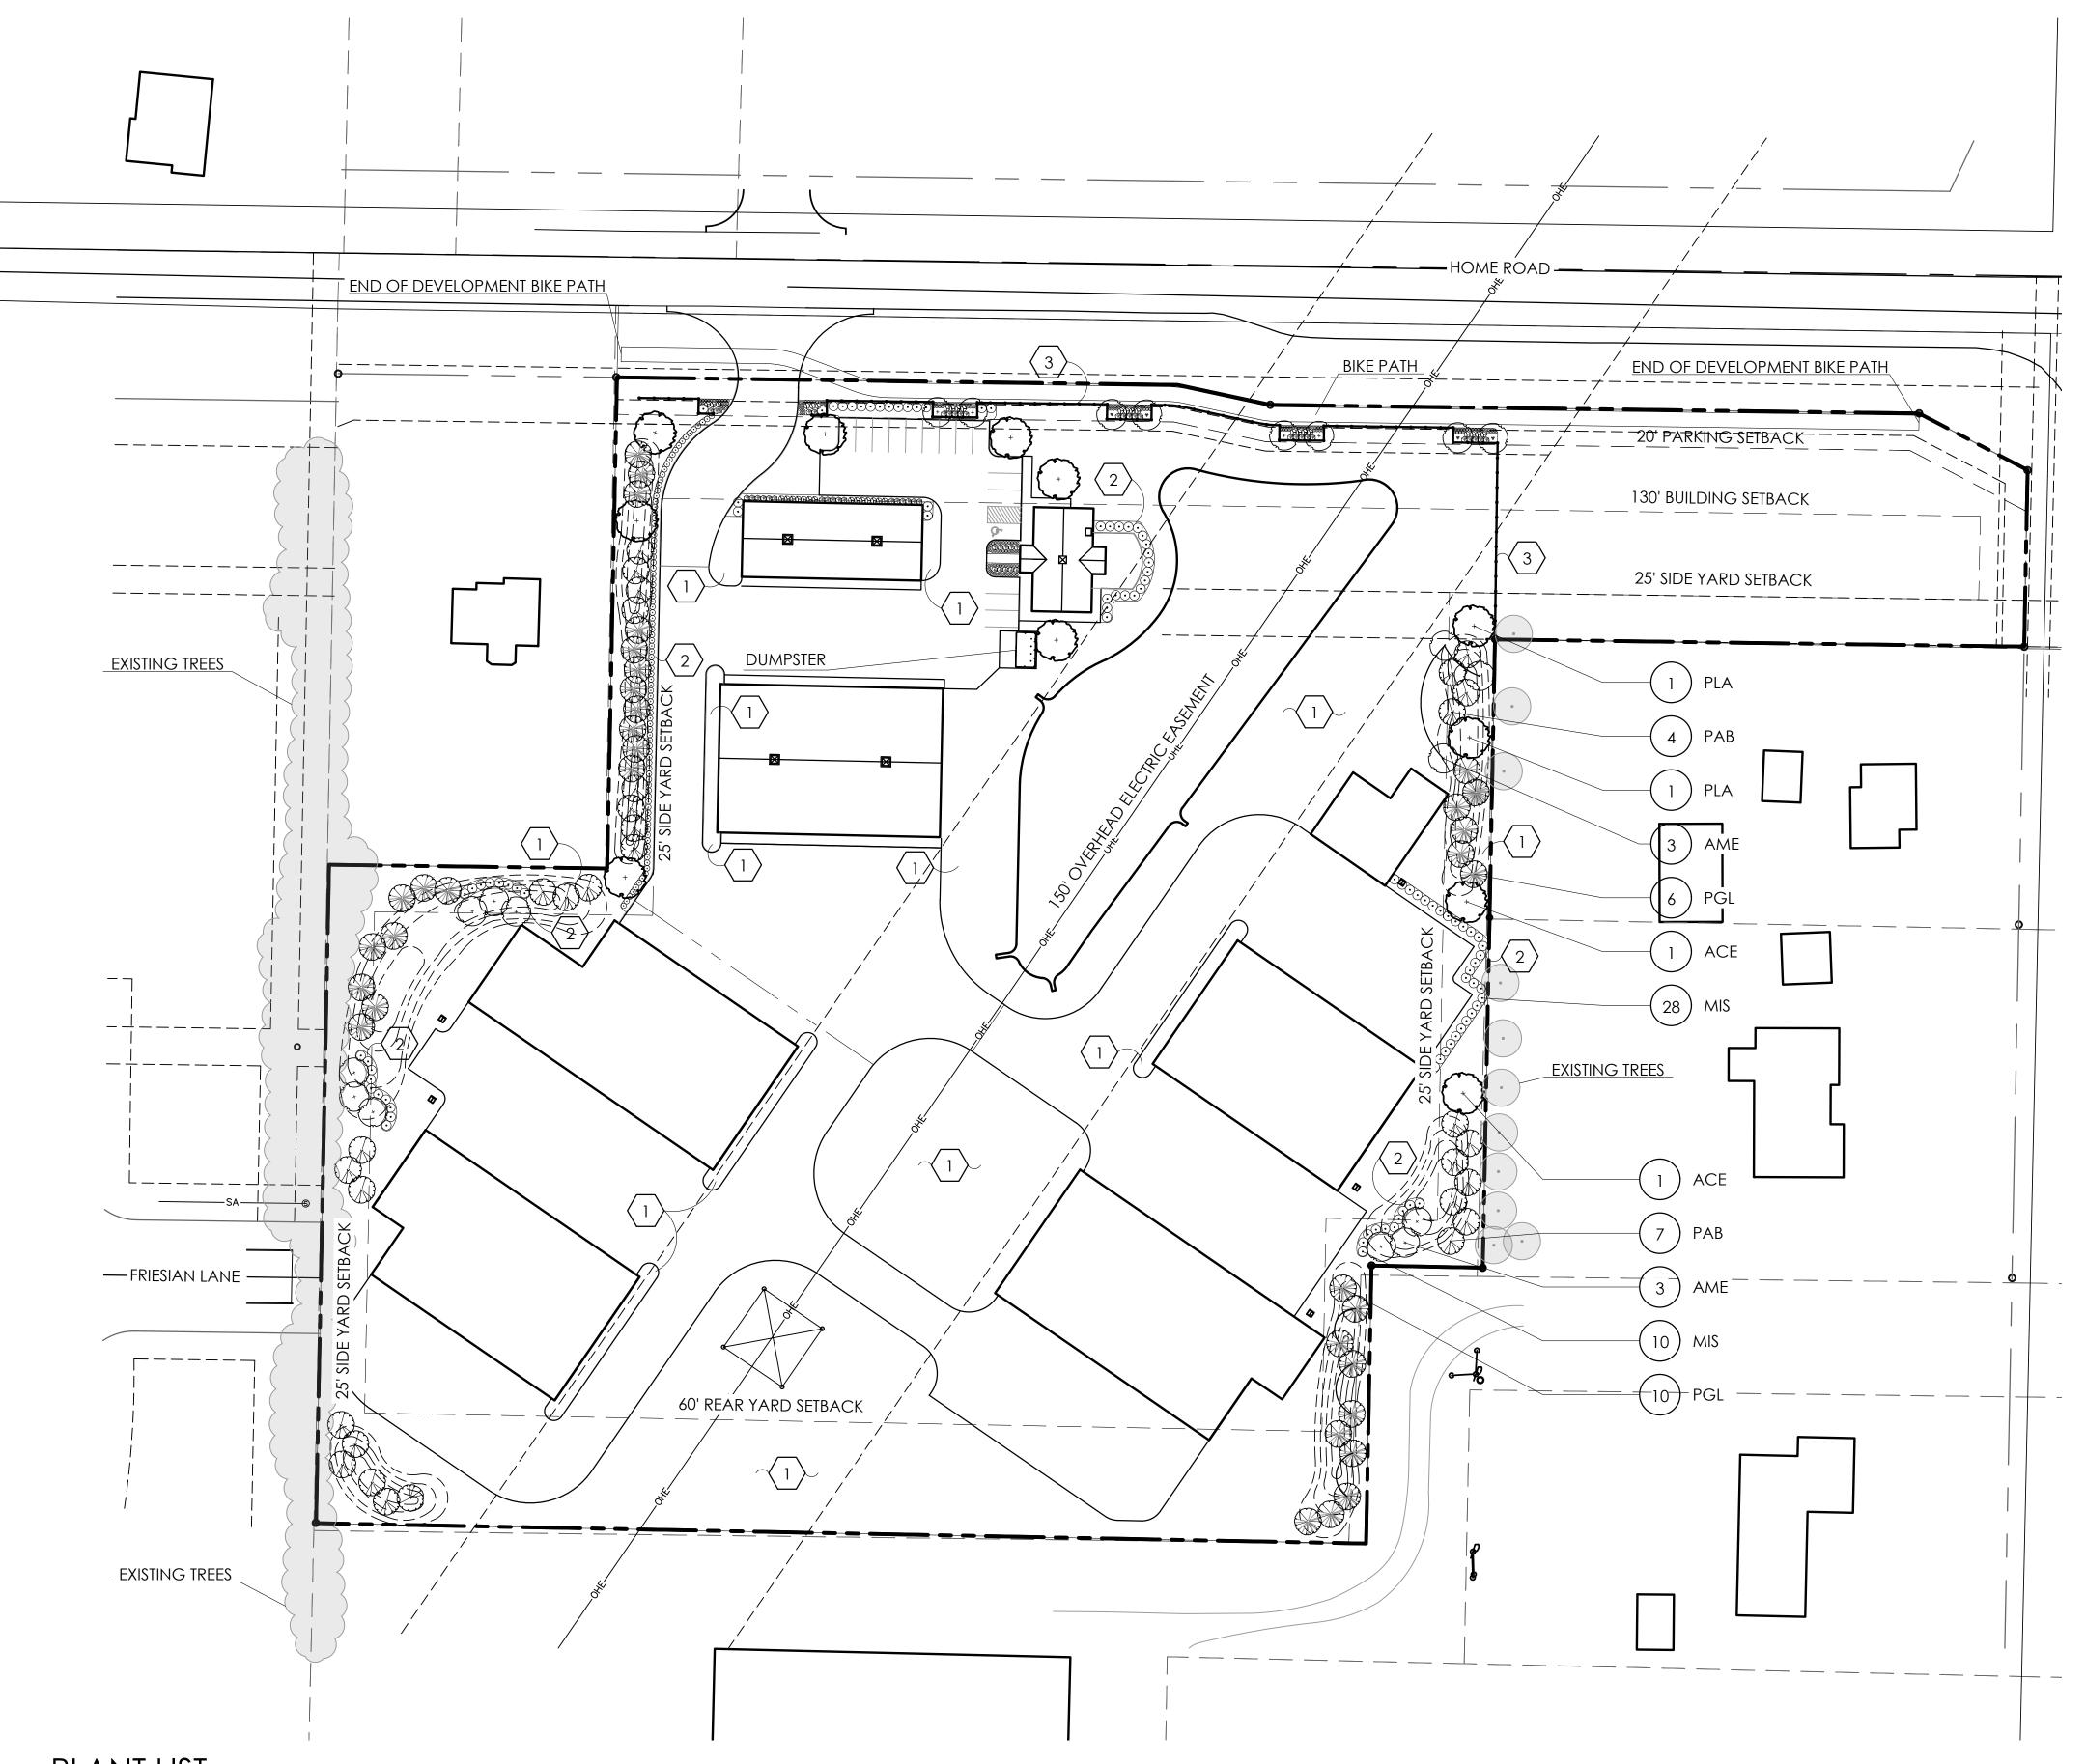


HORSE POWER FARMS PHASE 2

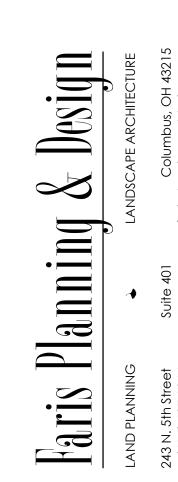ENGINEERINGGROUP, LTD.
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PLANT LIST (CONTRACTOR RESPONSIBLE FOR ALL PLANTS SHOWN ON PLAN)

QTY	KEY	BOTANICAL NAME	COMMON NAME	SIZE	COND.	REMARKS
TREES						
11	PAB	PICEA ABIES	NORWAY SPRUCE	6'-7' HGT.	B&B	
16	PGL	PICEA GLAUCA	WHITE SPRUCE	6'-7' HGT.	B&B	
2	PLA	PLATANUS X ACERIFOLIA 'BLOODGOOD'	BLOODGOOD LONDON PLANE TREE	2" CAL.	B&B	
2	ACE	ACER X FREEMANII 'SIENNA'	SIENNA GLEN MAPLE	2" CAL.	B&B	
6	AME	AMELANCHIER × GRANDIFLORA 'AUTUMN BRILLIANCE'	AUTUMN BRILLIANCE SERVICEBERRY	6'-7' HGT.	B&B	
PERENNIALS/ORNAMENTAL GRASSES						
38	MIS	MISCANTHUS SINENSIS 'GRACILLIMUS'	GRACILLIMUS MAIDEN GRASS	1 GAL.	CONT.	

# GENERAL PLANTING NOTES:


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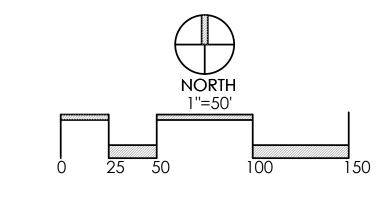
# **CONSTRUCTION NOTES:**

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- 2 LANDSCAPE AREA, PROVIDE POSITIVE DRAINAGE ACROSS ALL SURFACES.
- 3 3 RAIL BLACK HORSE FENCE SEE SHEET L-4/DETAIL 4



SEE PLANT LIST FOR SPECIFIC PLANT SPECIES - ORNAMENTAL TREE - LARGE DECIDUOUS SHRUB - EXISTING TREE - EVERGREEN SHRUB - DECIDUOUS SHRUB - EVERGREEN TREE PERENNIALS - GROUNDCOVER SHADE TREE



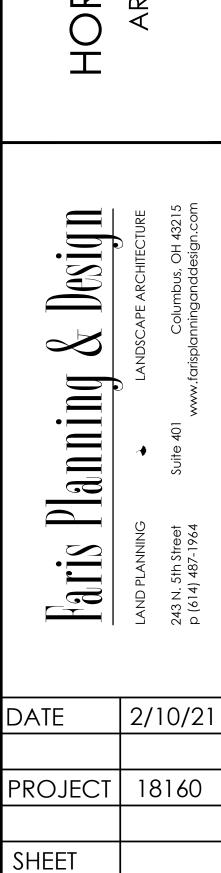

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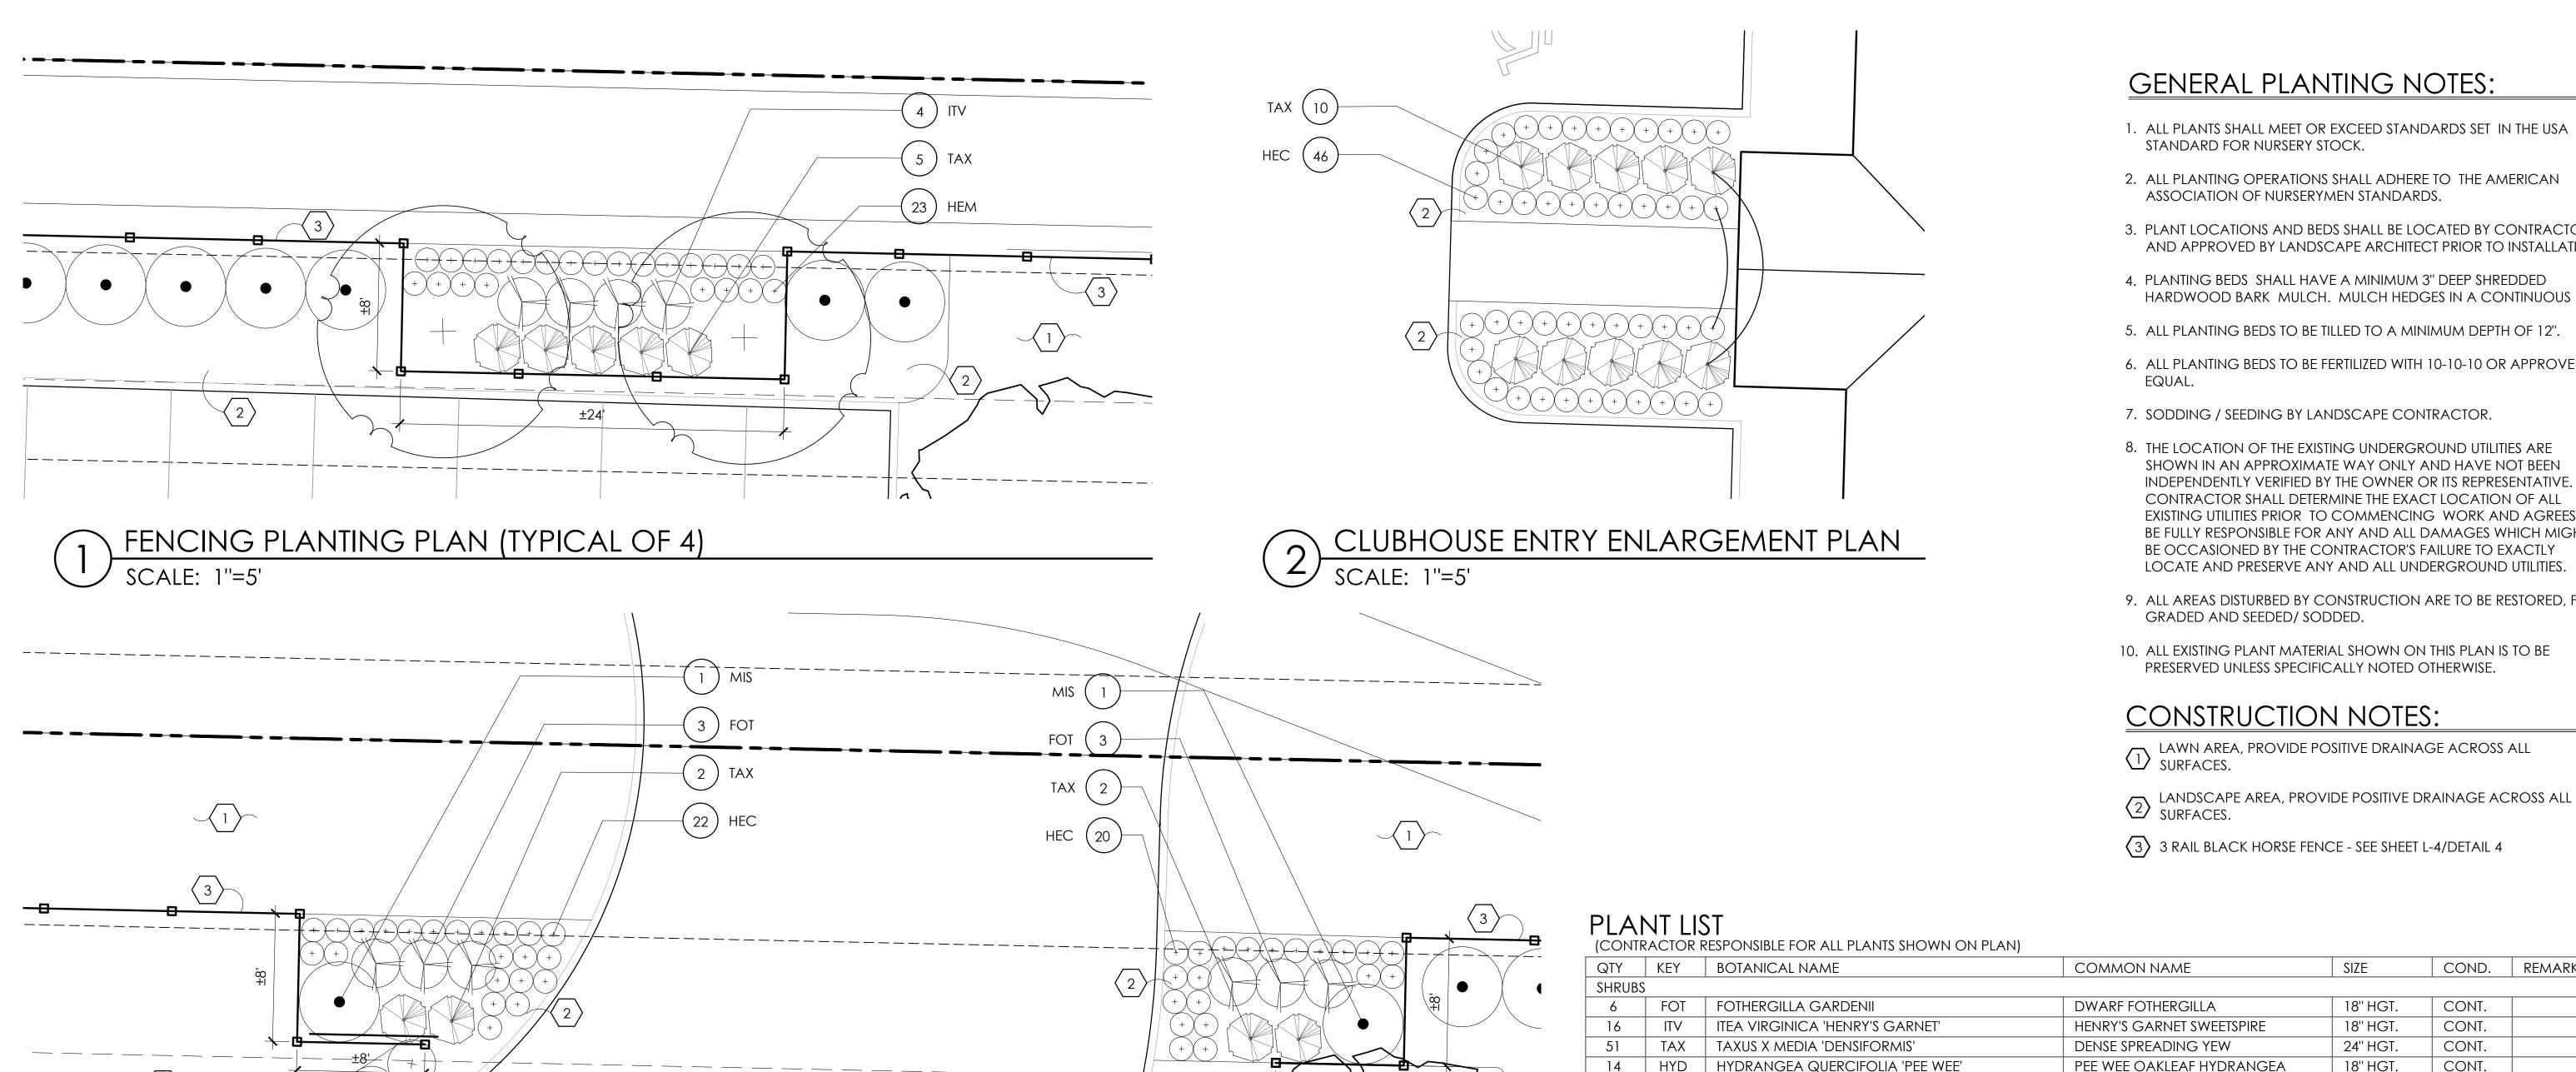
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PROJECT 18160



# GENERAL PLANTING NOTES:

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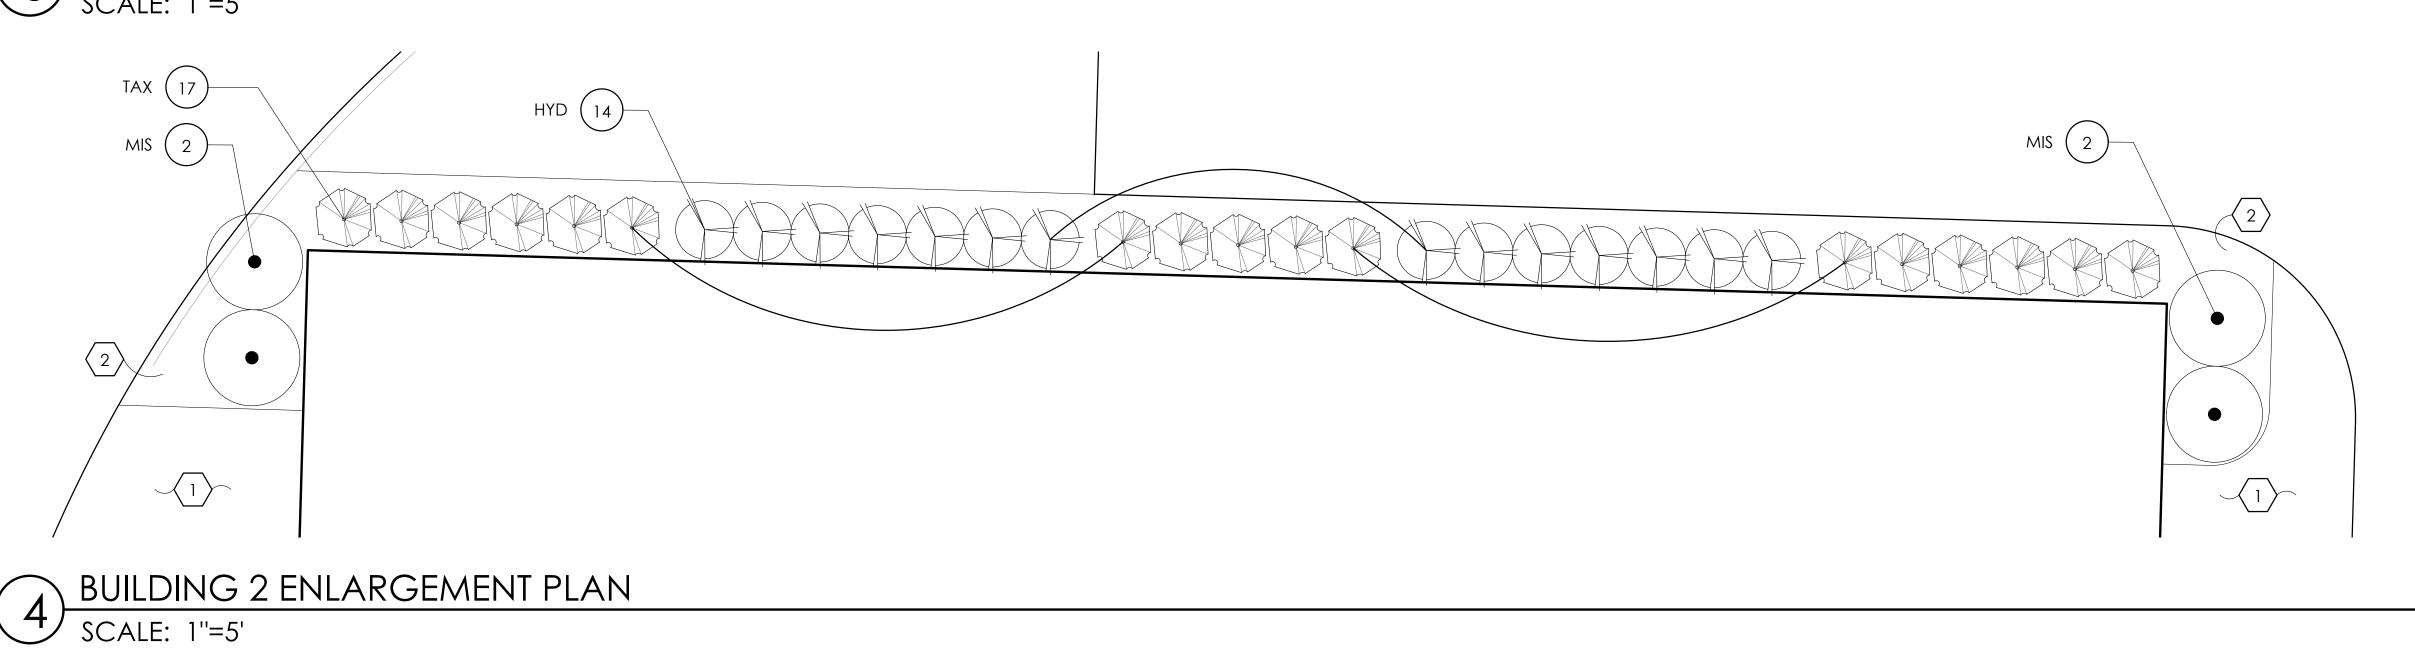
# **CONSTRUCTION NOTES:**


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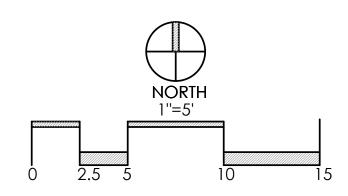
QTY	KEY	BOTANICAL NAME	COMMON NAME	SIZE	COND.	REMARKS
SHRUBS	S					
6	FOT	FOTHERGILLA GARDENII	DWARF FOTHERGILLA	18" HGT.	CONT.	
16	ITV	ITEA VIRGINICA 'HENRY'S GARNET'	HENRY'S GARNET SWEETSPIRE	18" HGT.	CONT.	
51	TAX	TAXUS X MEDIA 'DENSIFORMIS'	DENSE SPREADING YEW	24" HGT.	CONT.	
14	HYD	HYDRANGEA QUERCIFOLIA 'PEE WEE'	PEE WEE OAKLEAF HYDRANGEA	18" HGT.	CONT.	
PERENI	VIALS/OR	NAMENTAL GRASSES			-	
88	HEC	HEMEROCALLIS 'EARLYBIRD CARDINAL'	EARLYBIRD CARDINAL DAYLILY	1 GAL.	CONT.	
92	HEM	HEMEROCALLIS 'STELLA D'ORO'	STELLA D'ORO DAYLILY	1 GAL.	CONT.	
6	MIS	MISCANTHUS SINENSIS 'GRACILLIMUS'	GRACILLIMUS MAIDEN GRASS	2 GAL.	CONT.	

\*NOTE: ALL ENLARGEMENTS ON SHEET L-3 ARE INCLUDED IN PHASE 1 LANDSCAPING

# 3 ENTRY ENLARGEMENT PLAN SCALE: 1"=5"





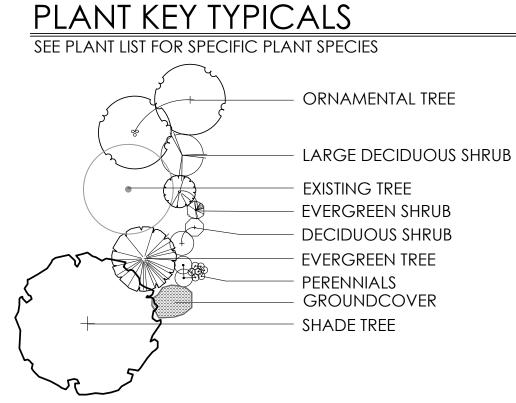

SHEET

2/10/21 PROJECT 18160


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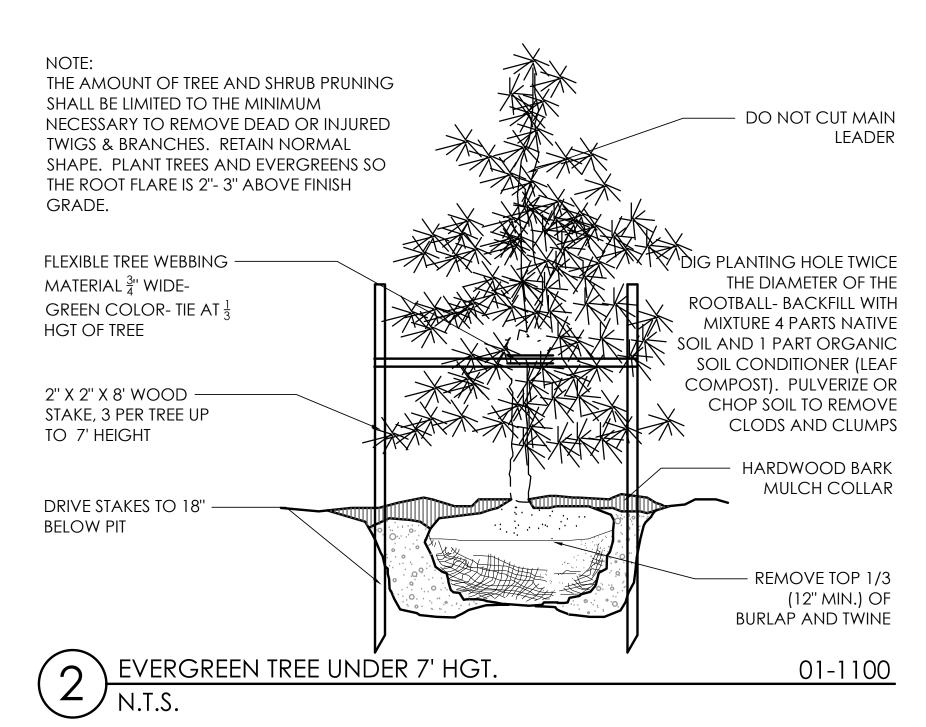
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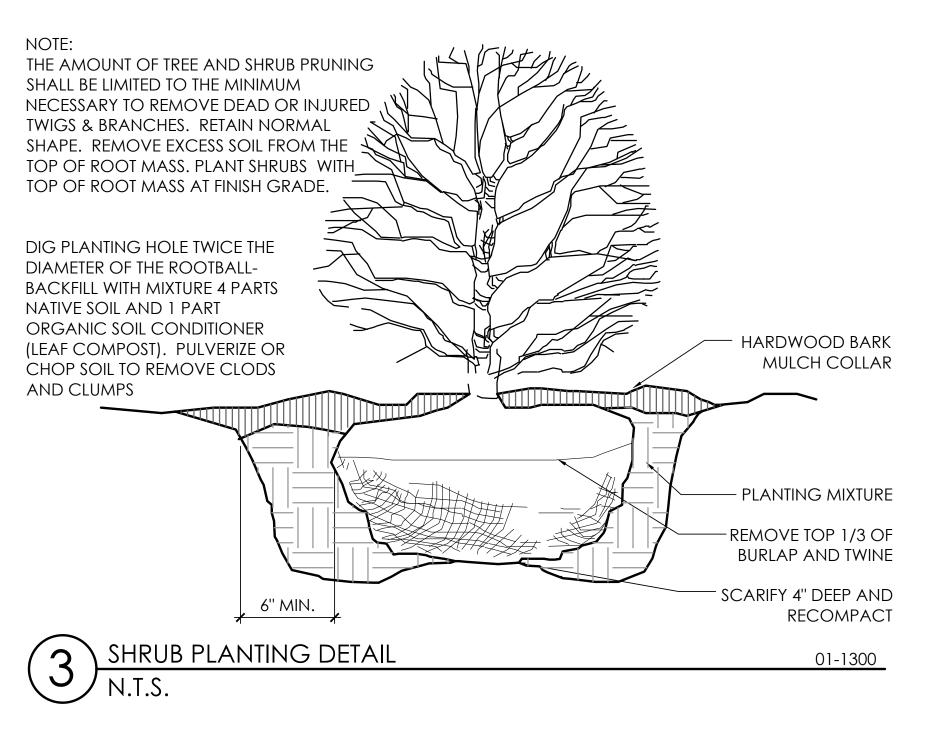
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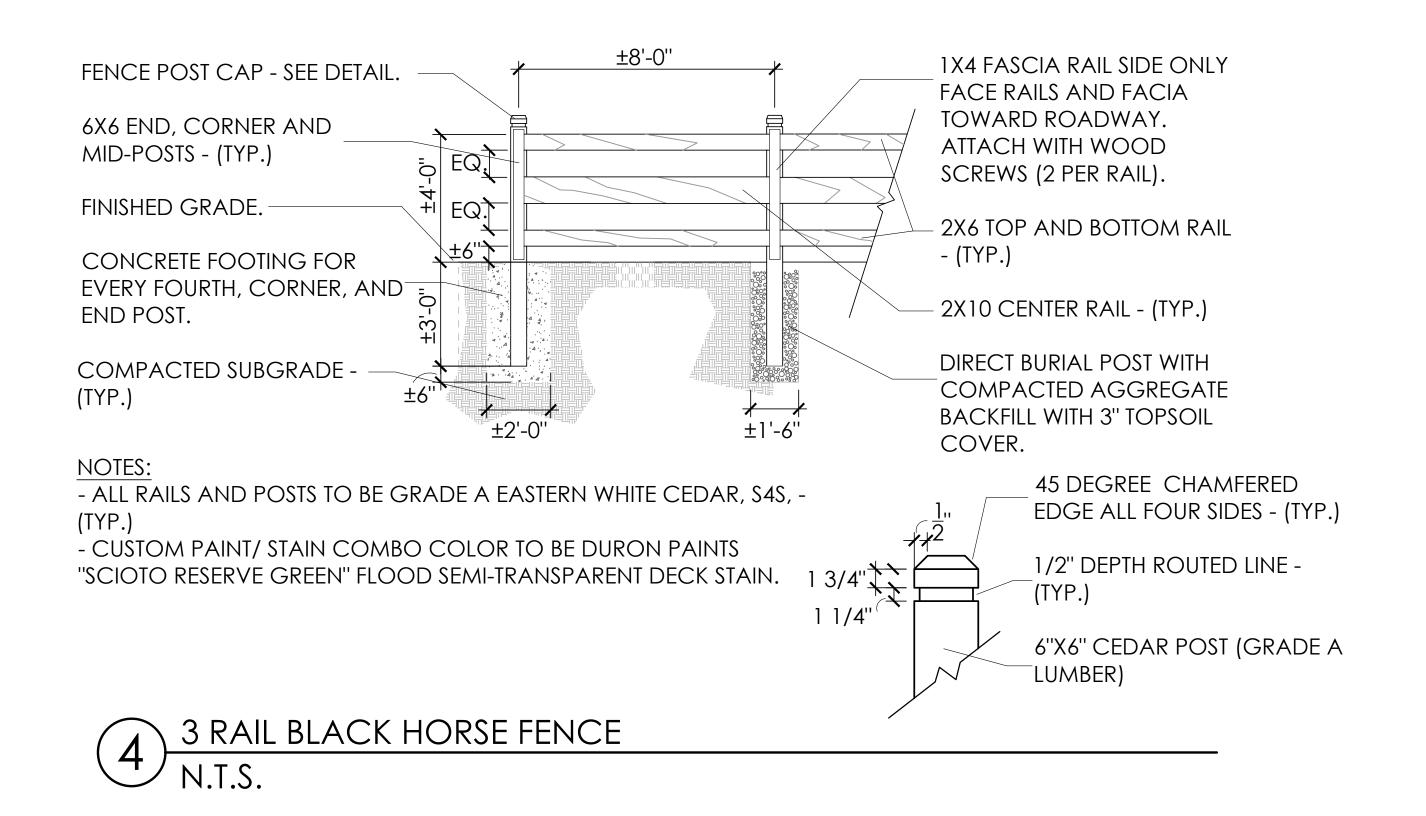
Design

Planning








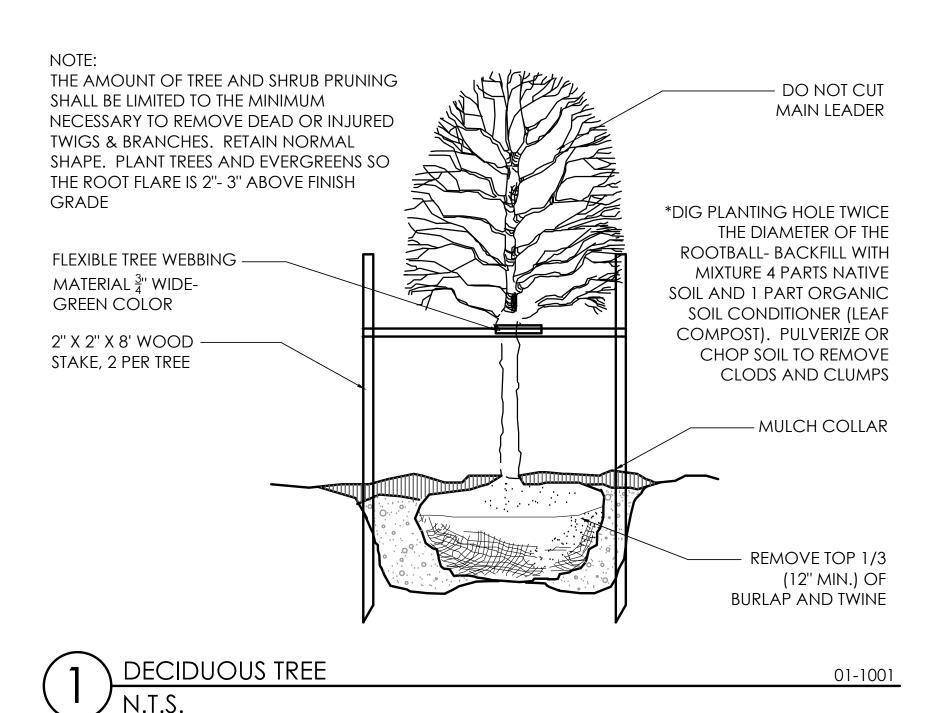

**DETAIL**( SITE RX OWER TURAL THIRD AVE SE Design Paris Planning 2/10/21 DATE PROJECT 18160 SHEET

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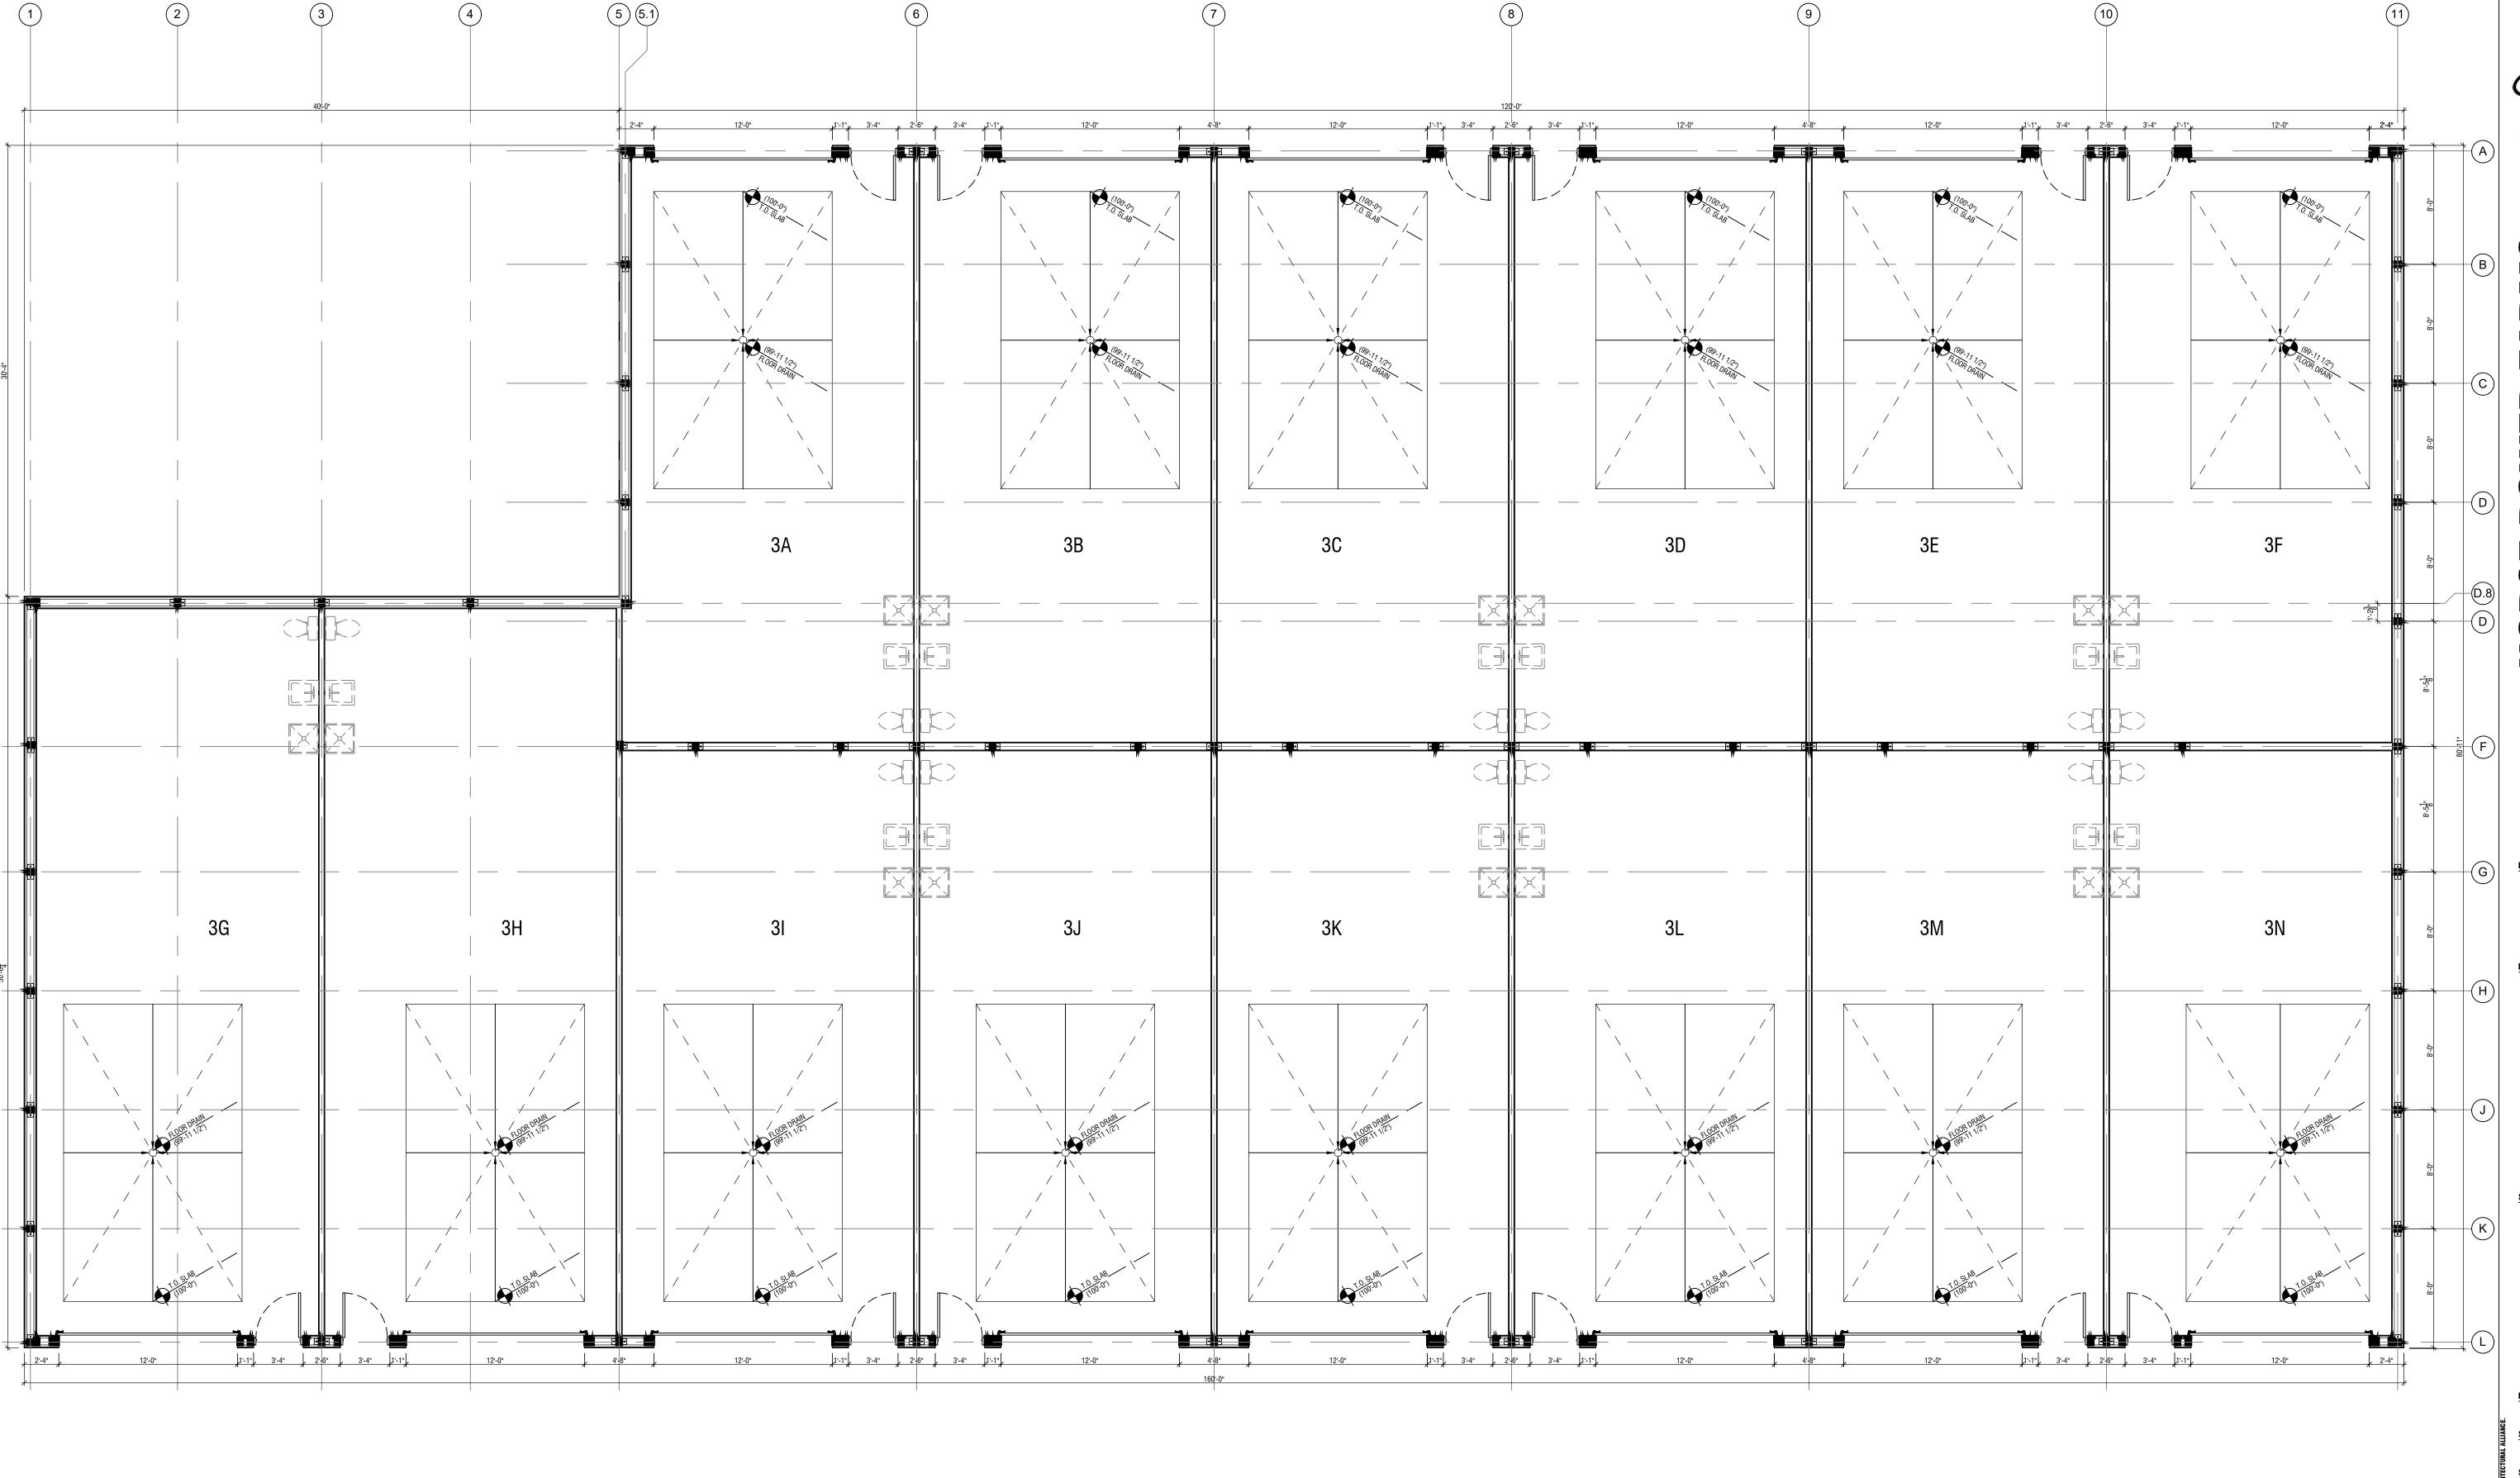





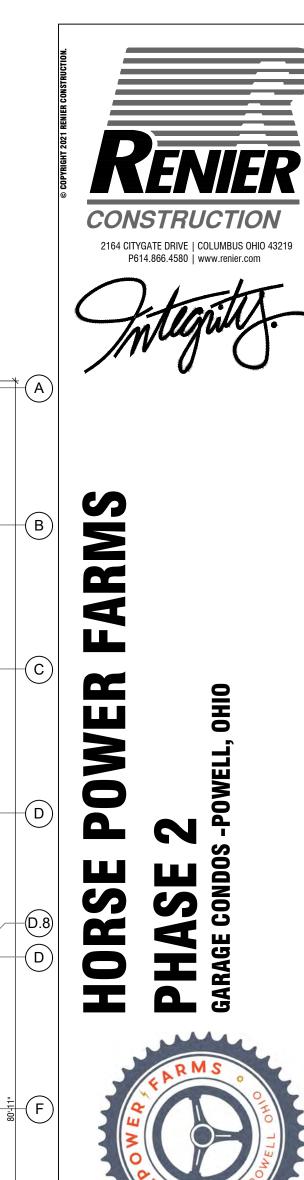


FLOOR PLAN - BUILDING 3

A3.01



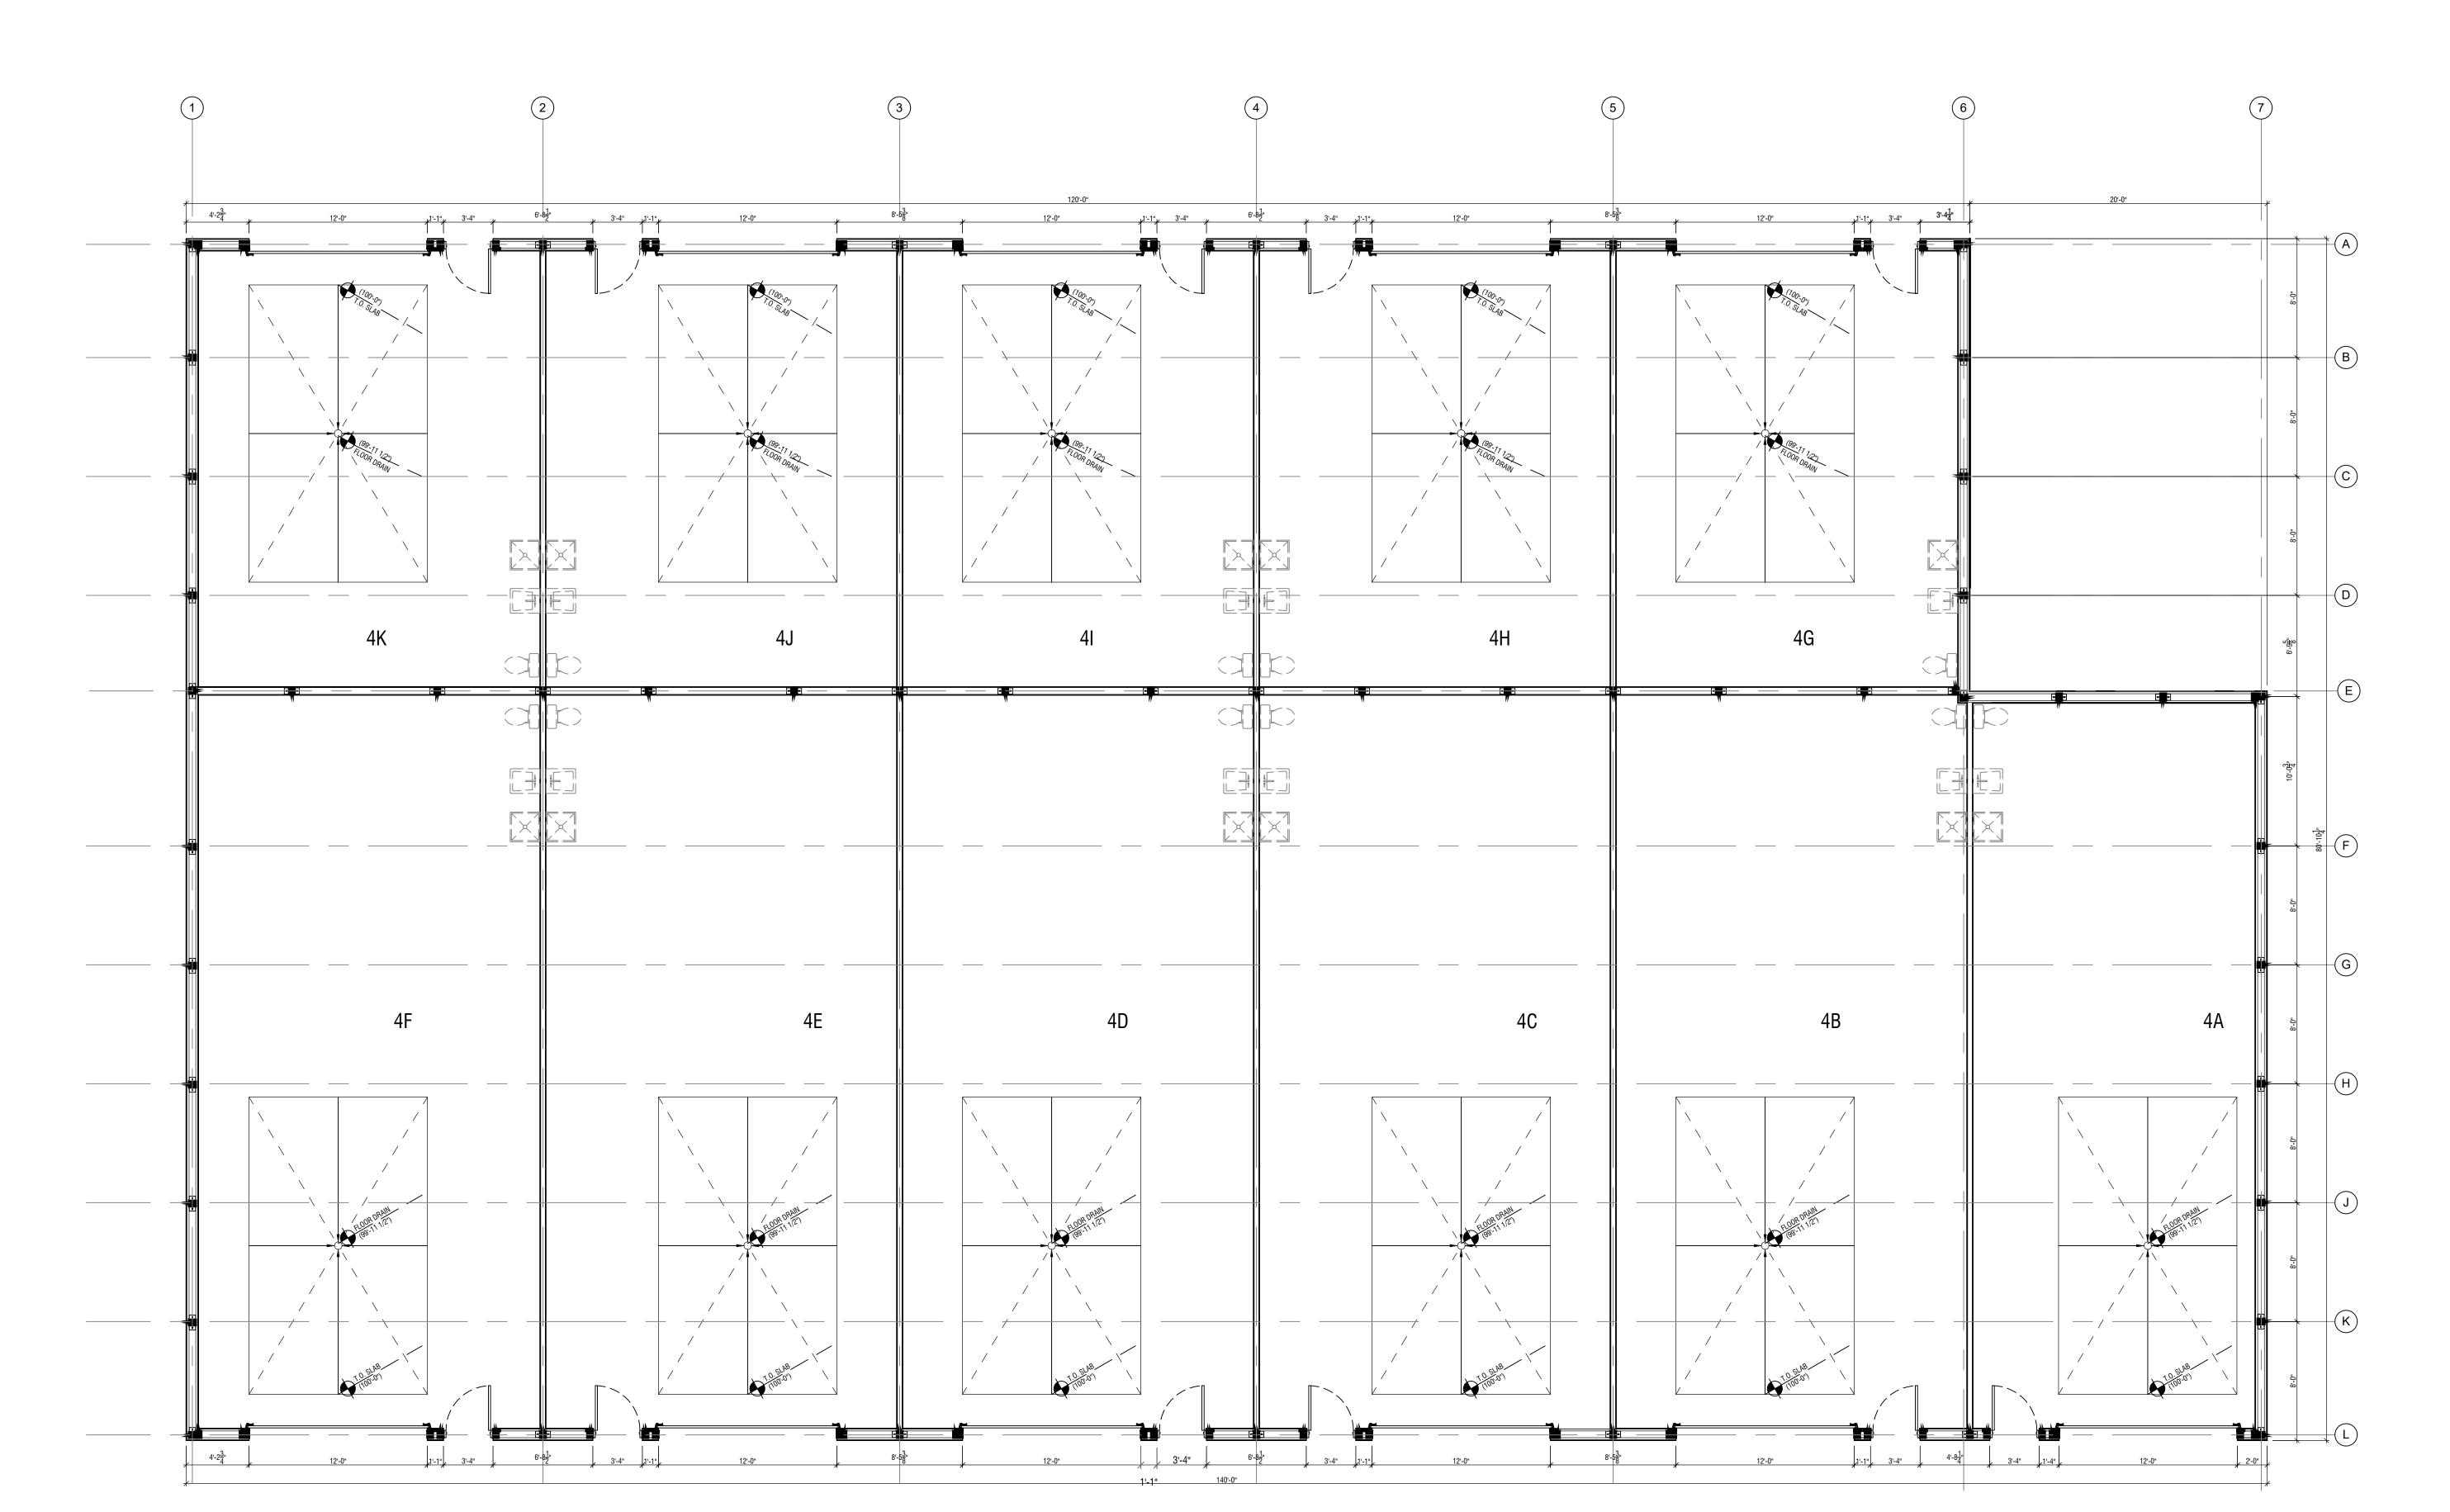



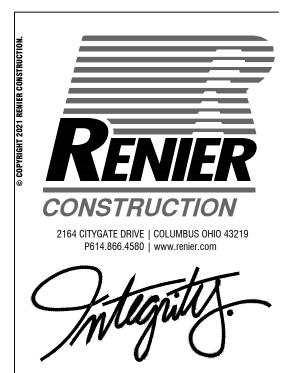

POWER FARMS

HORSE PO PHASE 2



02 | 10 | 2021 | preliminary check set bid permit construction



PROJECT NUMBER


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FLOOR PLAN - BUILDING 4

SHEET NUMBER






2164 CITYGATE DRIVE | COLUMBUS OHIO 43219 P614.866.4580 | www.renier.com

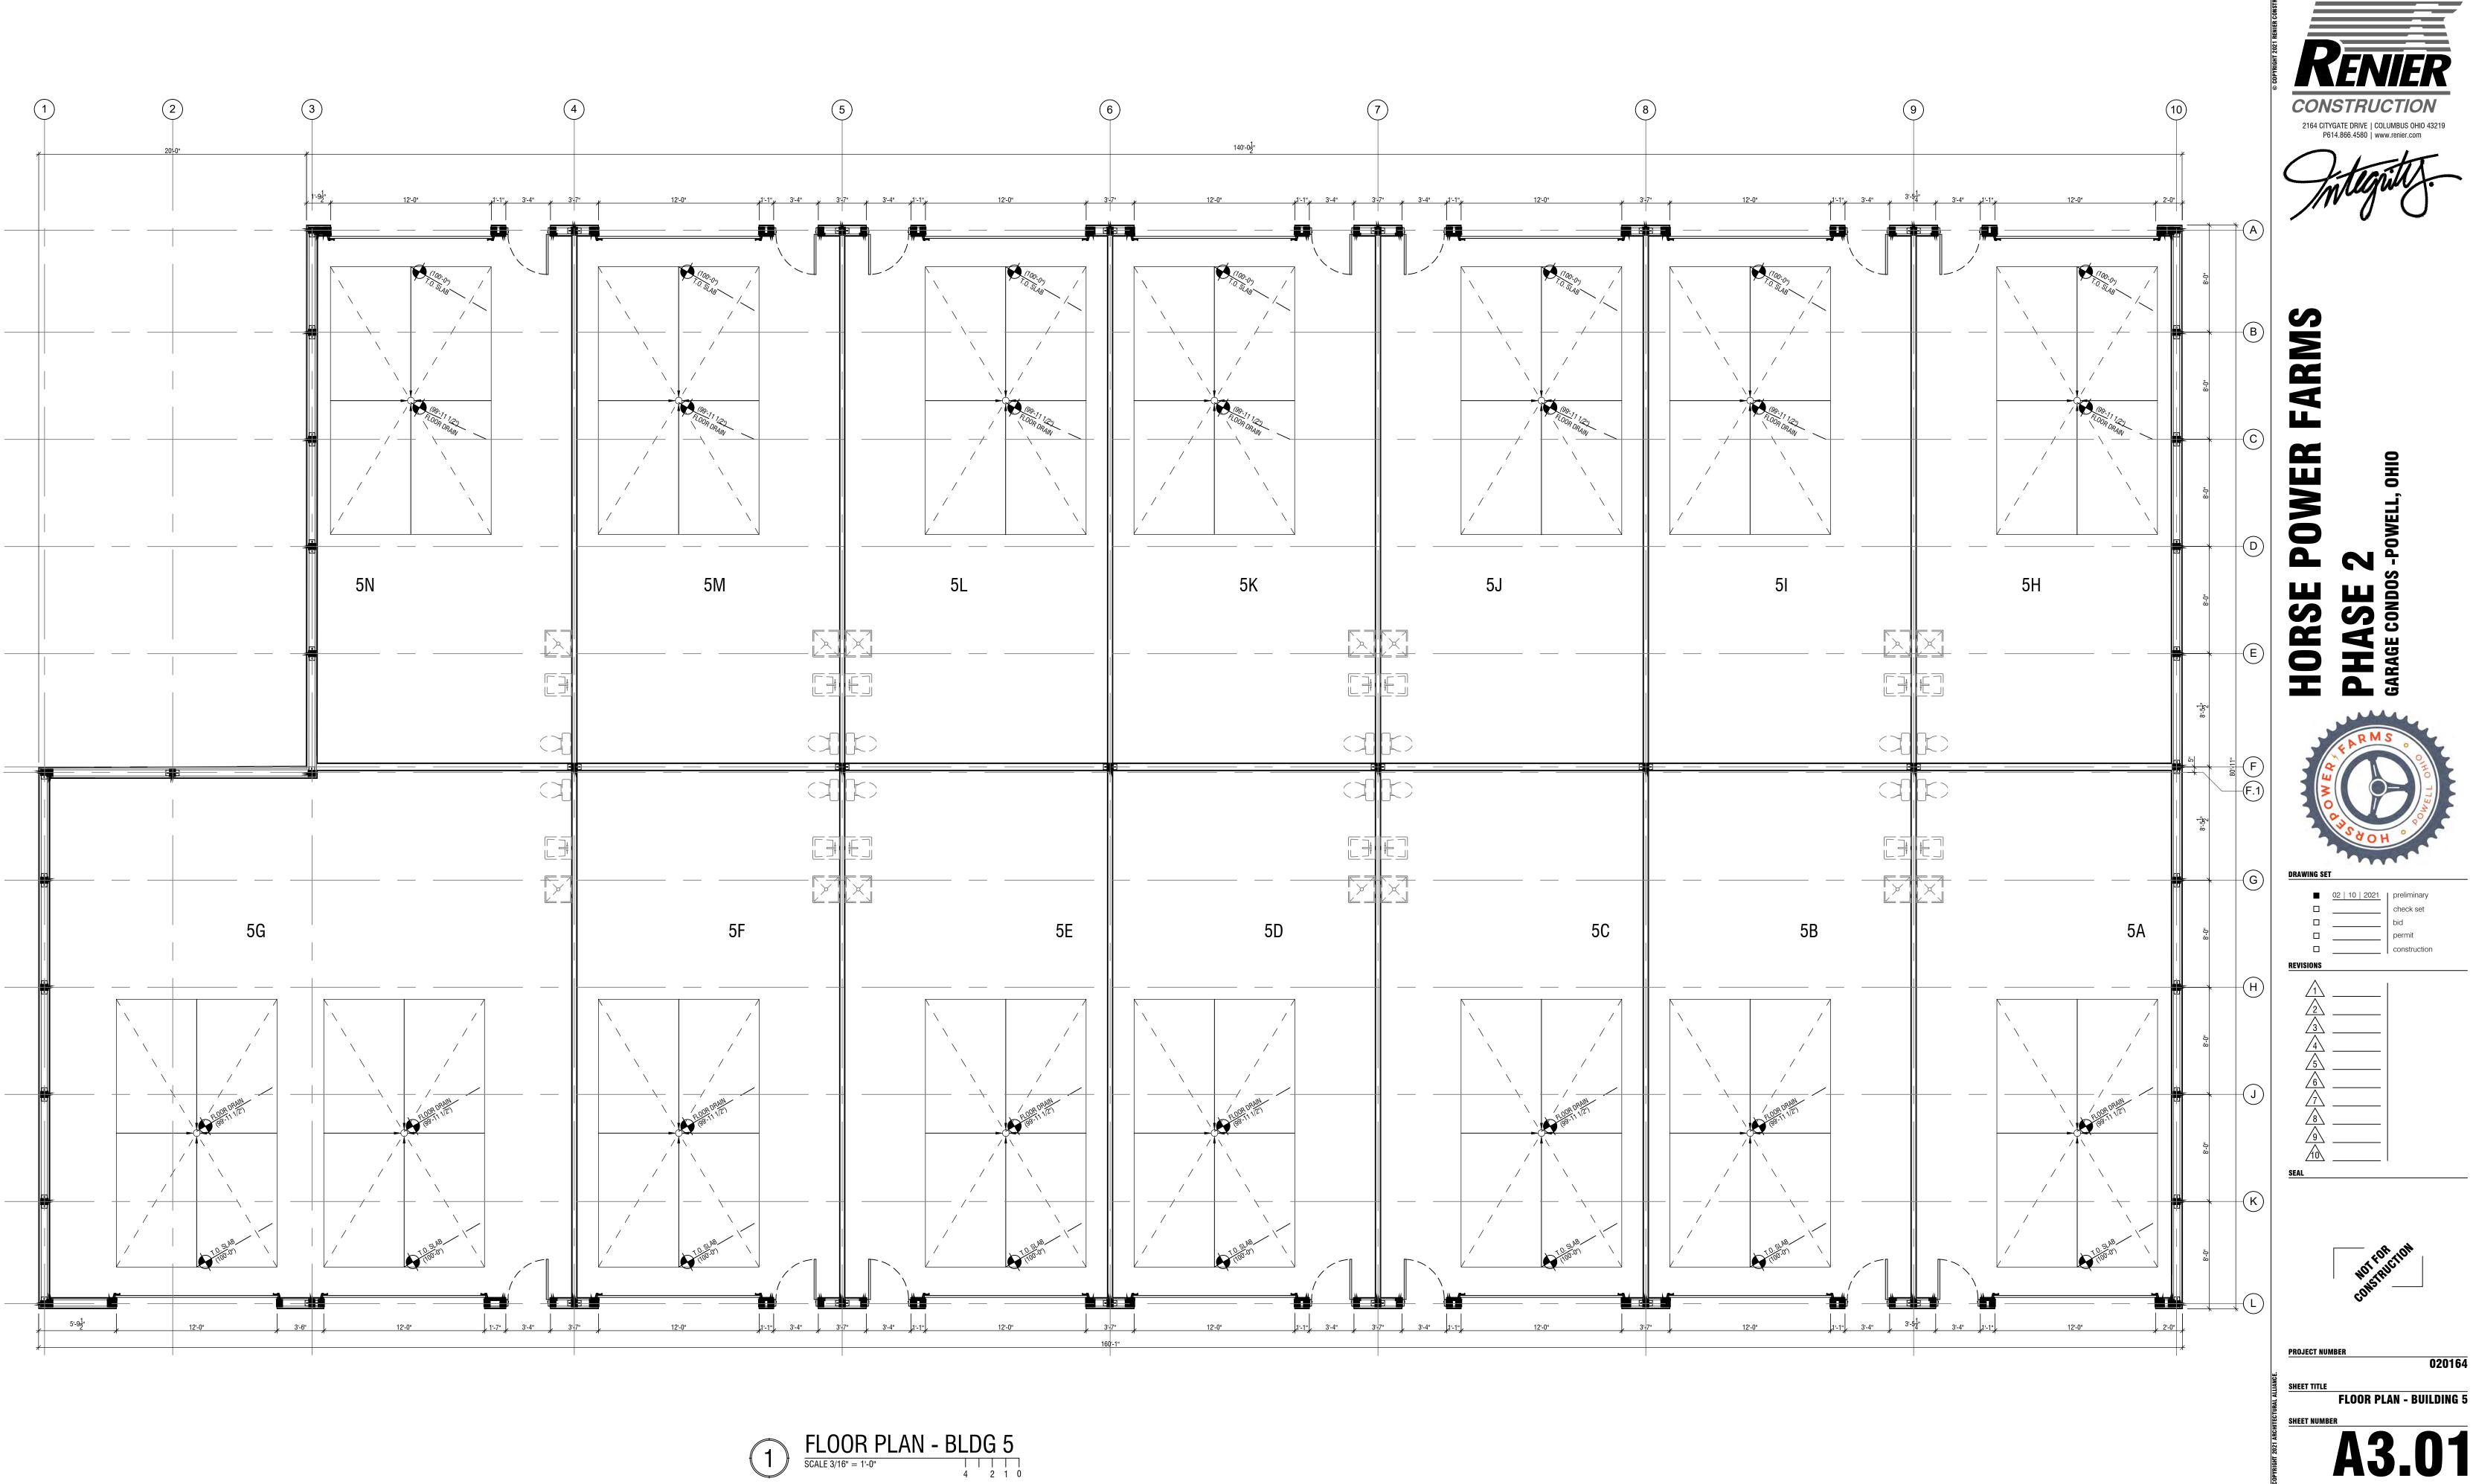



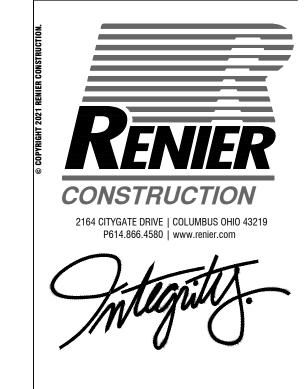


POWER FARMS

HORSE POV PHASE 2



■ 02 | 10 | 2021 | preliminary | check set | bid | permit | construction

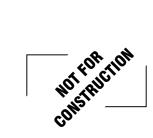

PROJECT NUMBER


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SHEET TITLE


FLOOR PLAN - BUILDING 6

SHEET NUMBER

A3.01



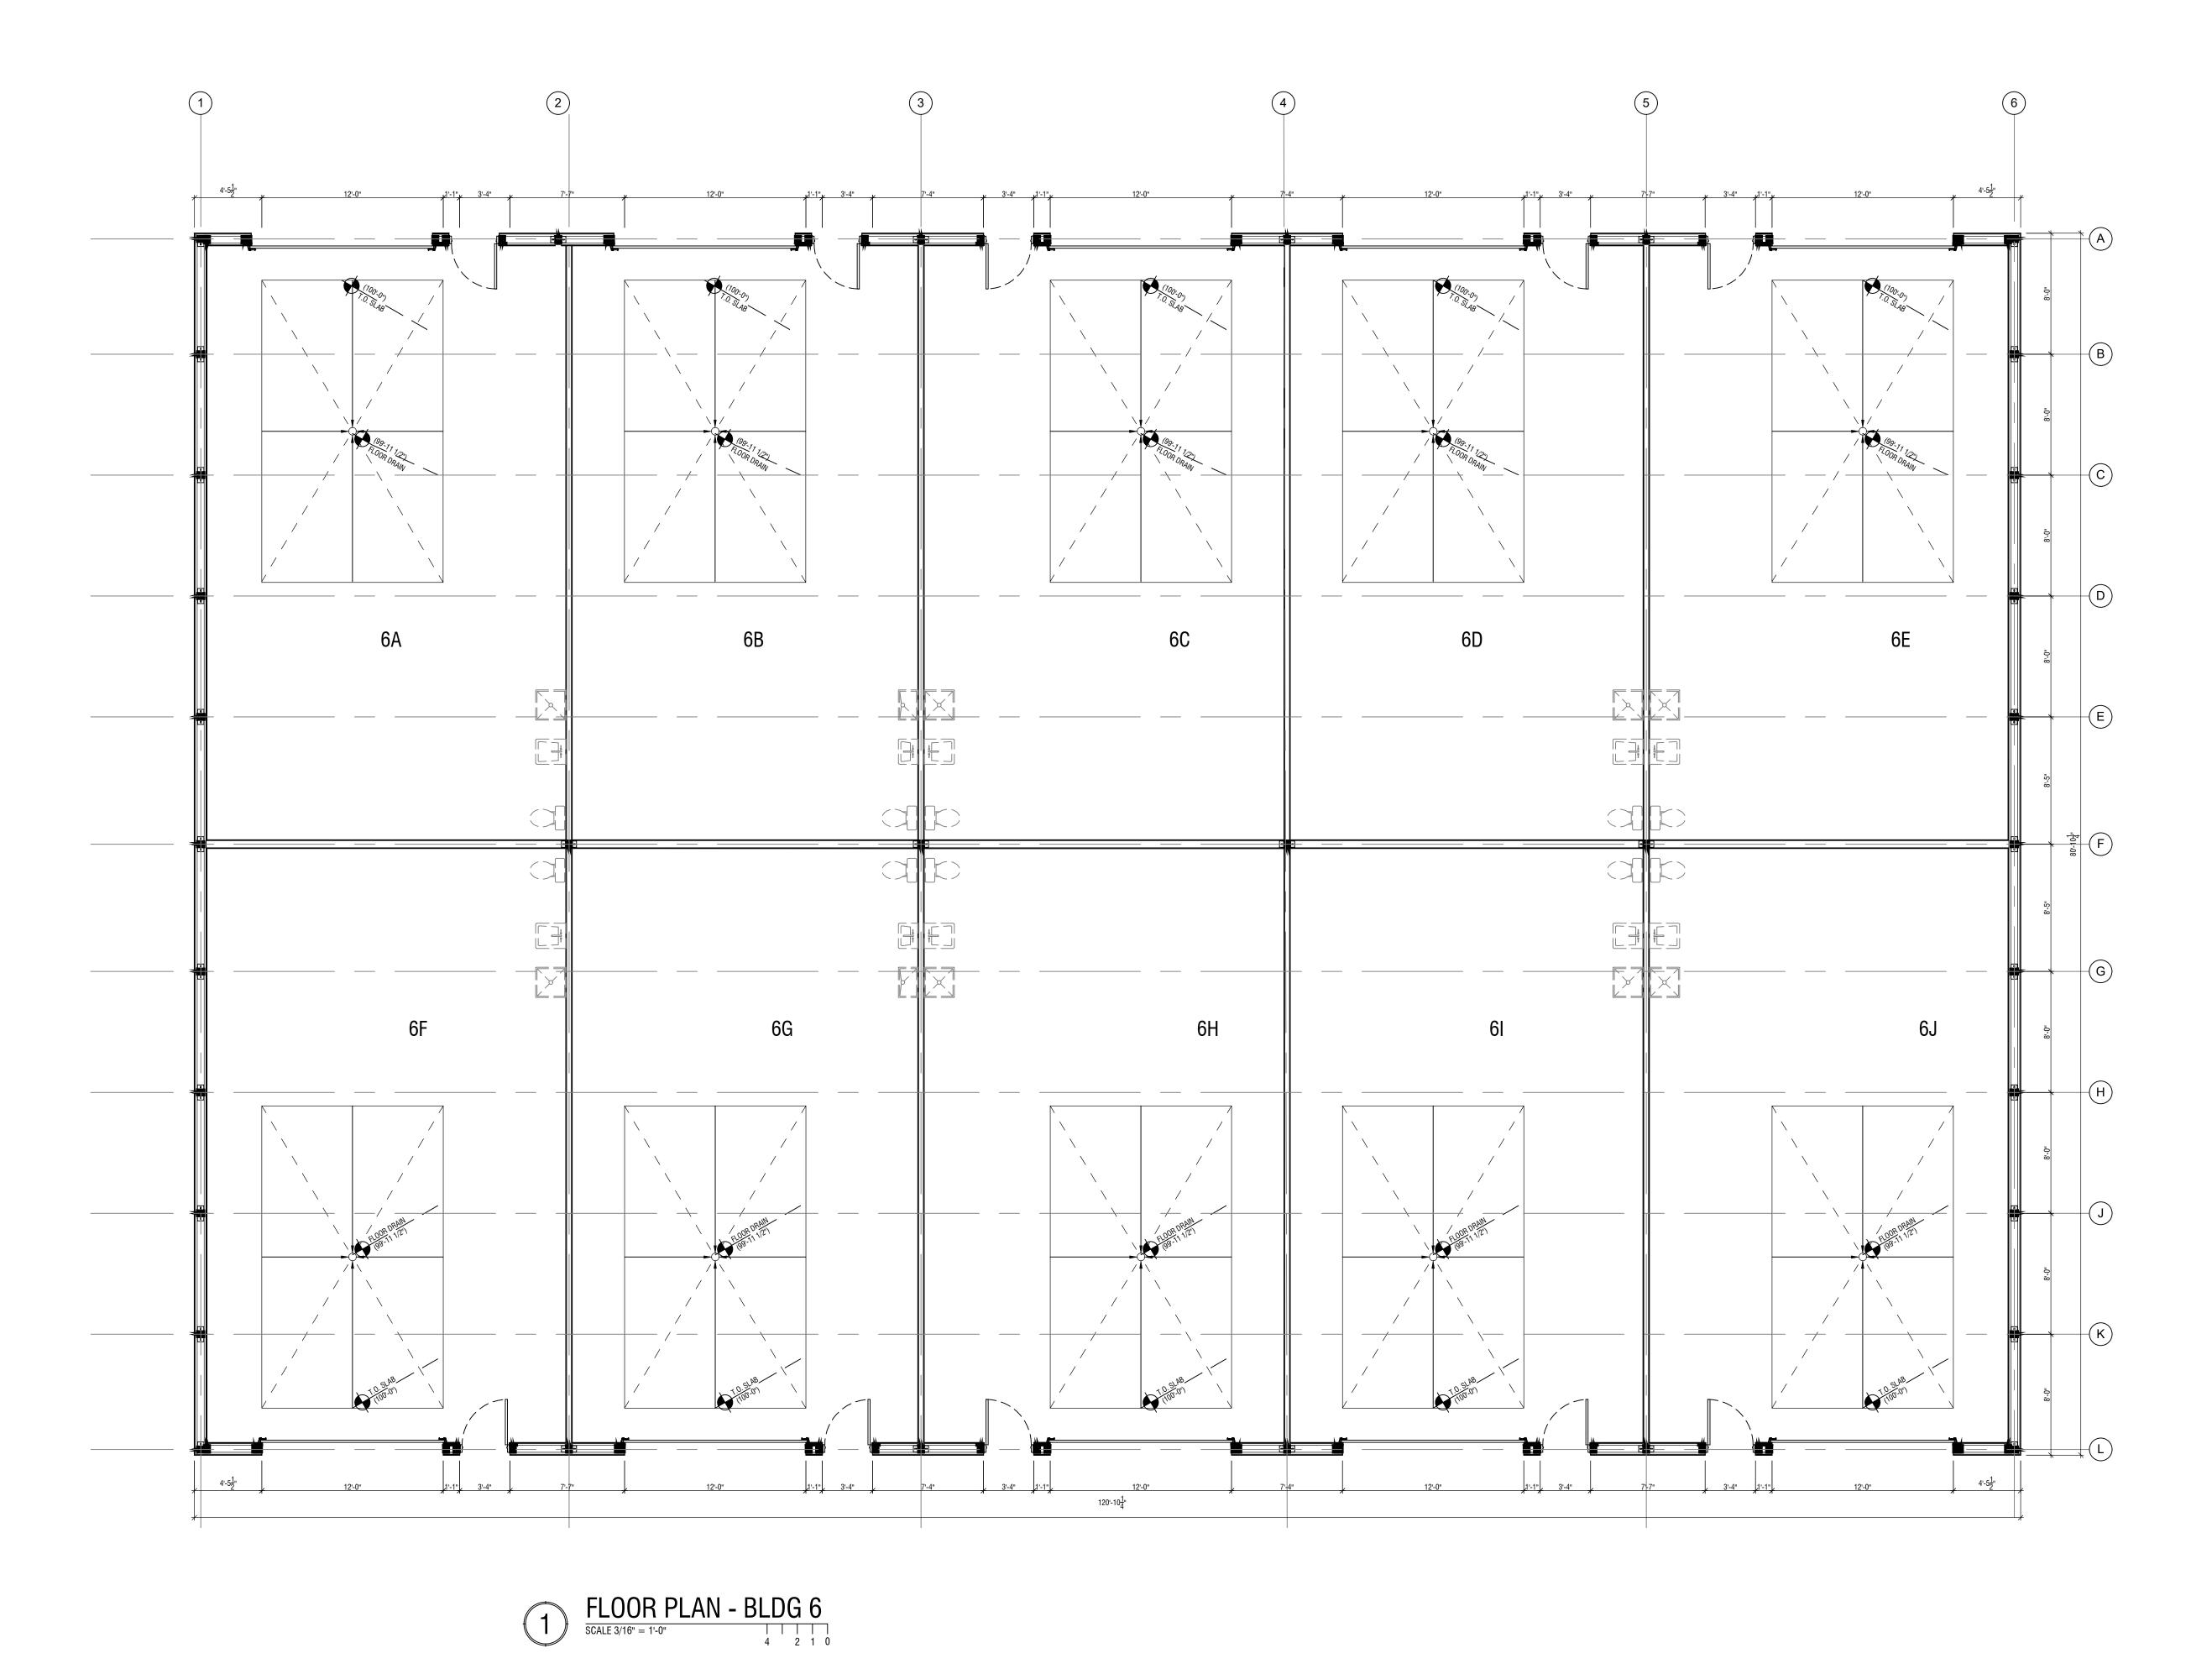

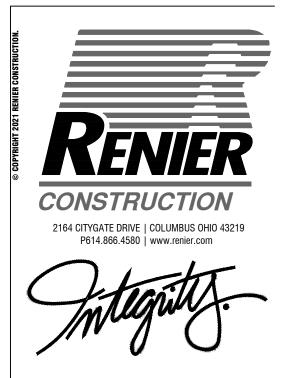

# POWER FARMS




| 02 | 10 | 2021 | preliminary | check set | bid | permit | construction |




PROJECT NUMBER

FLOOR PLAN - BUILDING 7
SHEET NUMBER

A3.01

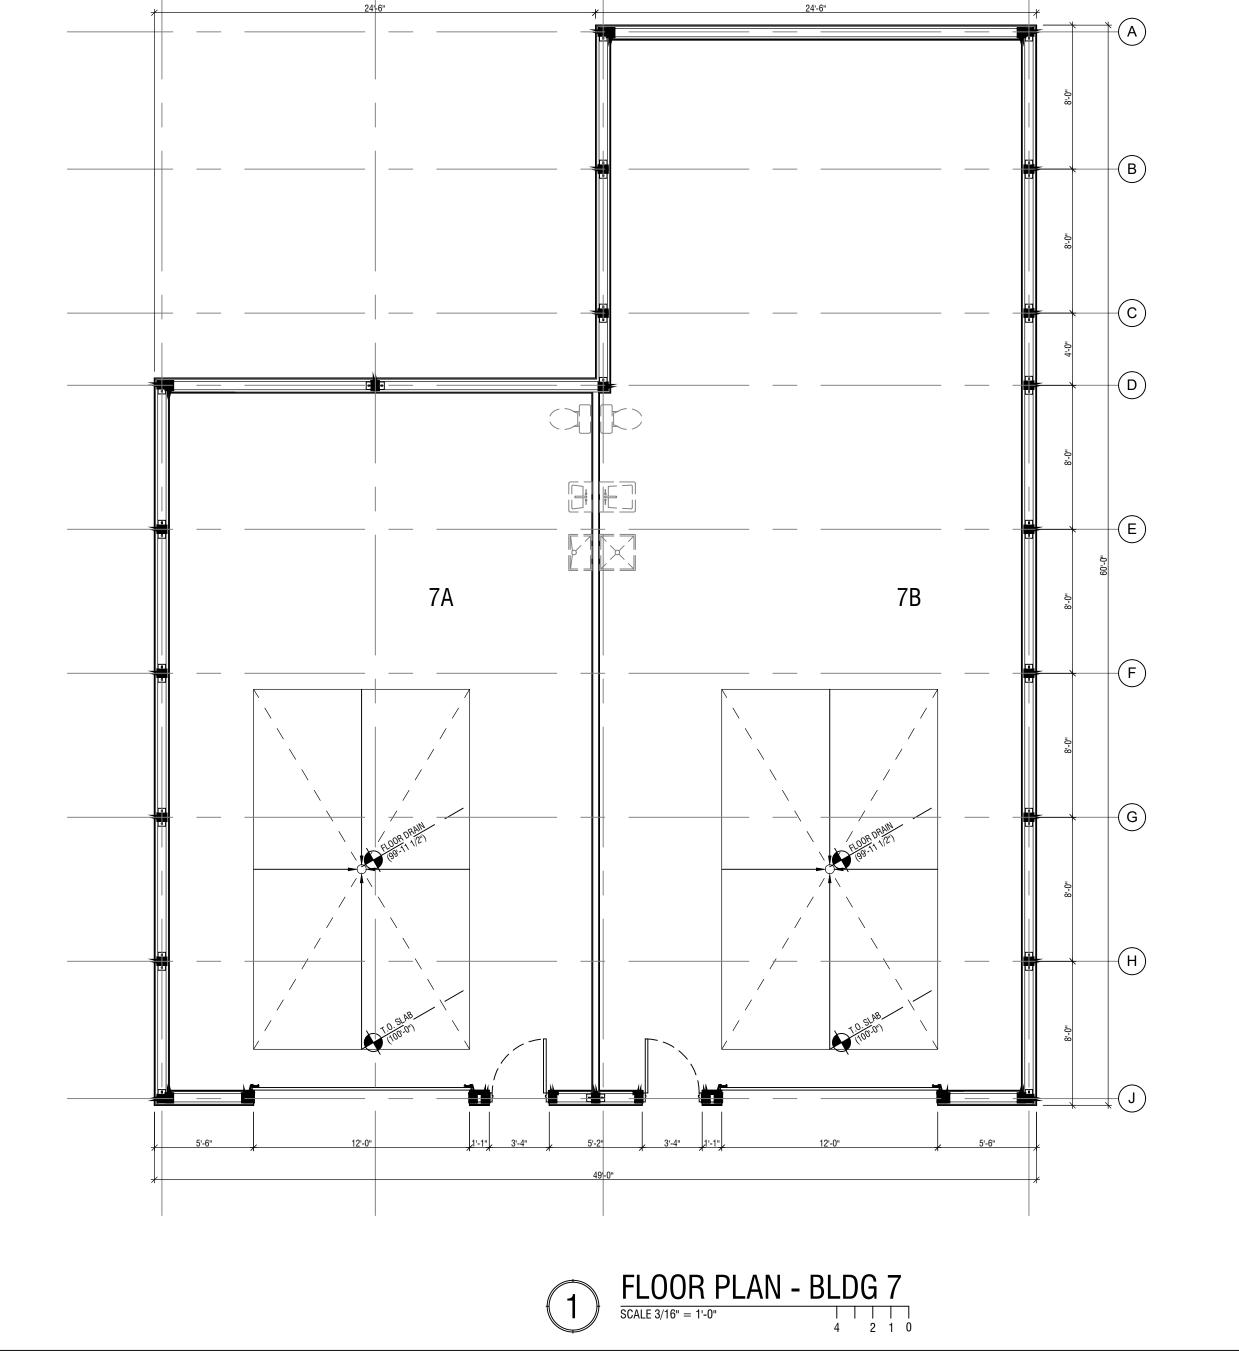



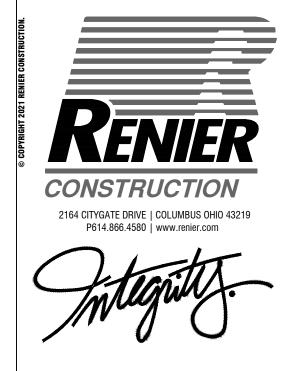


HORSE POWER FARMS



| 02 | 10 | 2021 | preliminary | check set | bid | permit | construction

\_\_\_\_ROOF RIDGE (129'-2 3/8")

T.O<u>. OVERHEAD DOOR</u> (114'-0")

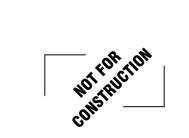

PROJECT NUMBER 020164

SHEET TITLE
EXTERIOR ELEVATIONS - BUILDING 3
SHEET NUMBER

SOUTH ELEVATION BLDG 3

SOUTH FLEVATION BLDG 3


EAST ELEVATION BLDG 3

SCALE 3/16" = 1'-0"

4 2 1 0

think. create. do.



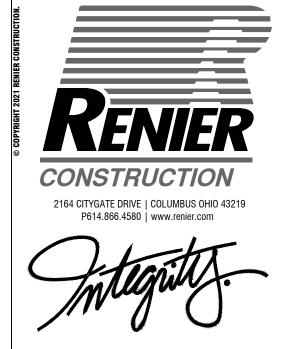


**FARMS** POWER



020164 SHEET TITLE
EXTERIOR ELEVATIONS - BUILDING 3

A4.02

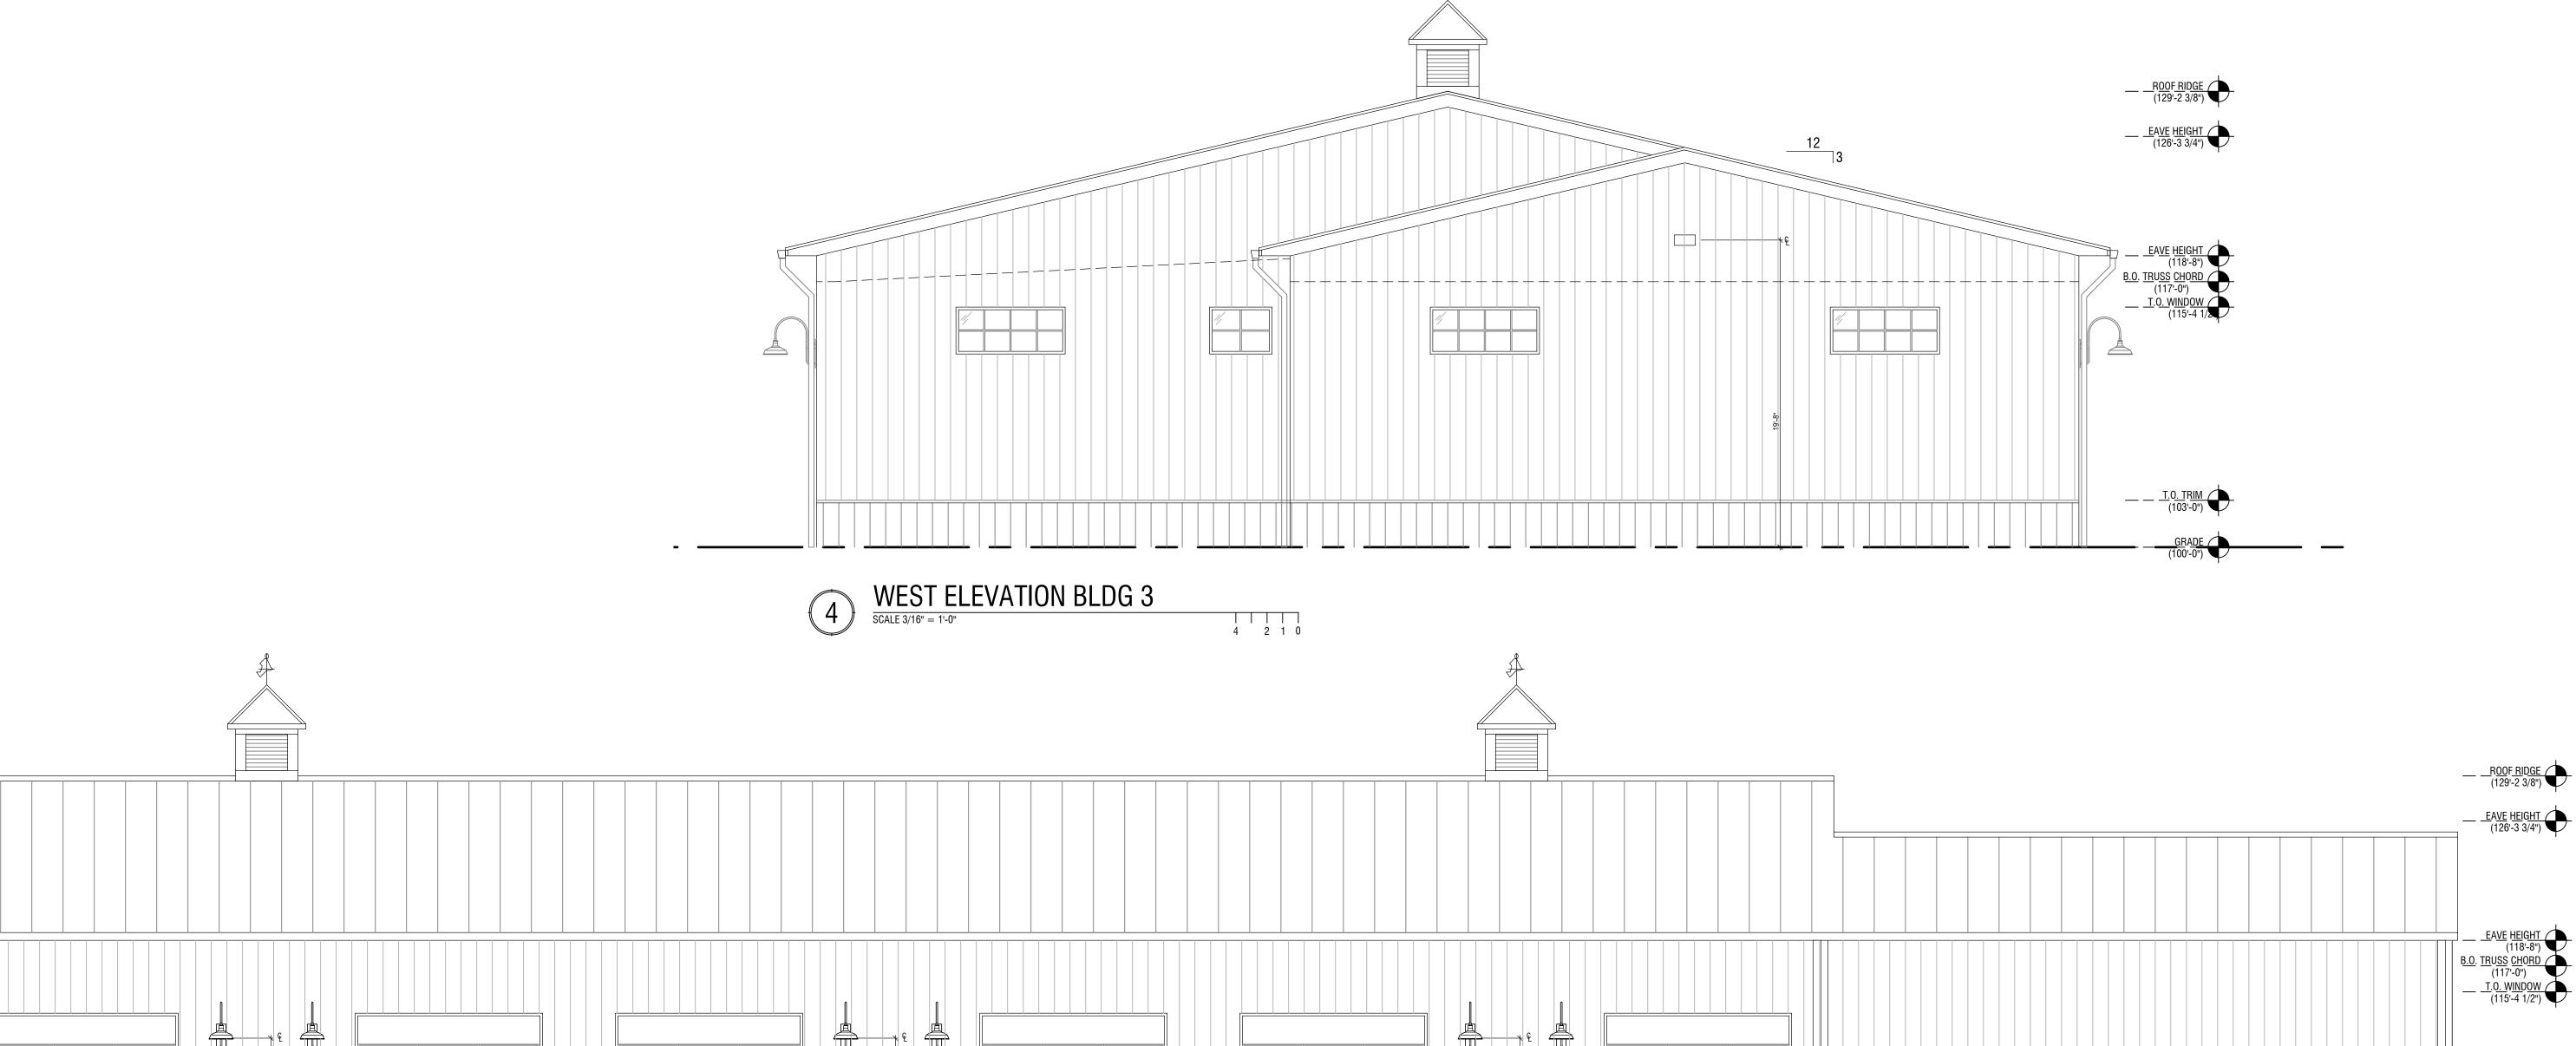


4 2 1 0

NORTH ELEVATION BLDG 3


SCALE 3/16" = 1'-0"



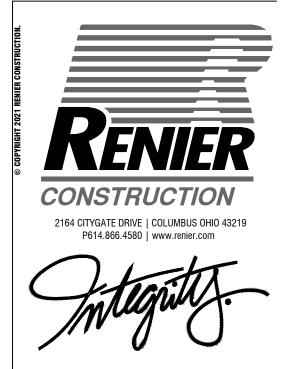

POWER FARMS

PHASE GARAGE CONDOS-

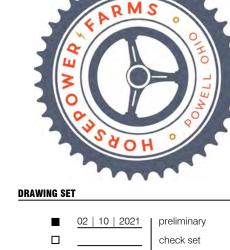


\$\frac{1}{2}\$
\$\frac{1}{3}\$
\$\frac{4}{4}\$
\$\frac{5}{5}\$
\$\frac{6}{4}\$
\$\frac{7}{1}\$
\$\frac{8}{1}\$
\$\frac{9}{9}\$
\$\frac{9}{1}\$
\$\frac{1}{1}\$
\$\frac{1}{2}\$
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NOT FOR THUS TON

PROJECT NUMBER
020164

EXTERIOR ELEVATIONS - BUILDING 4


SHEET NUMBER

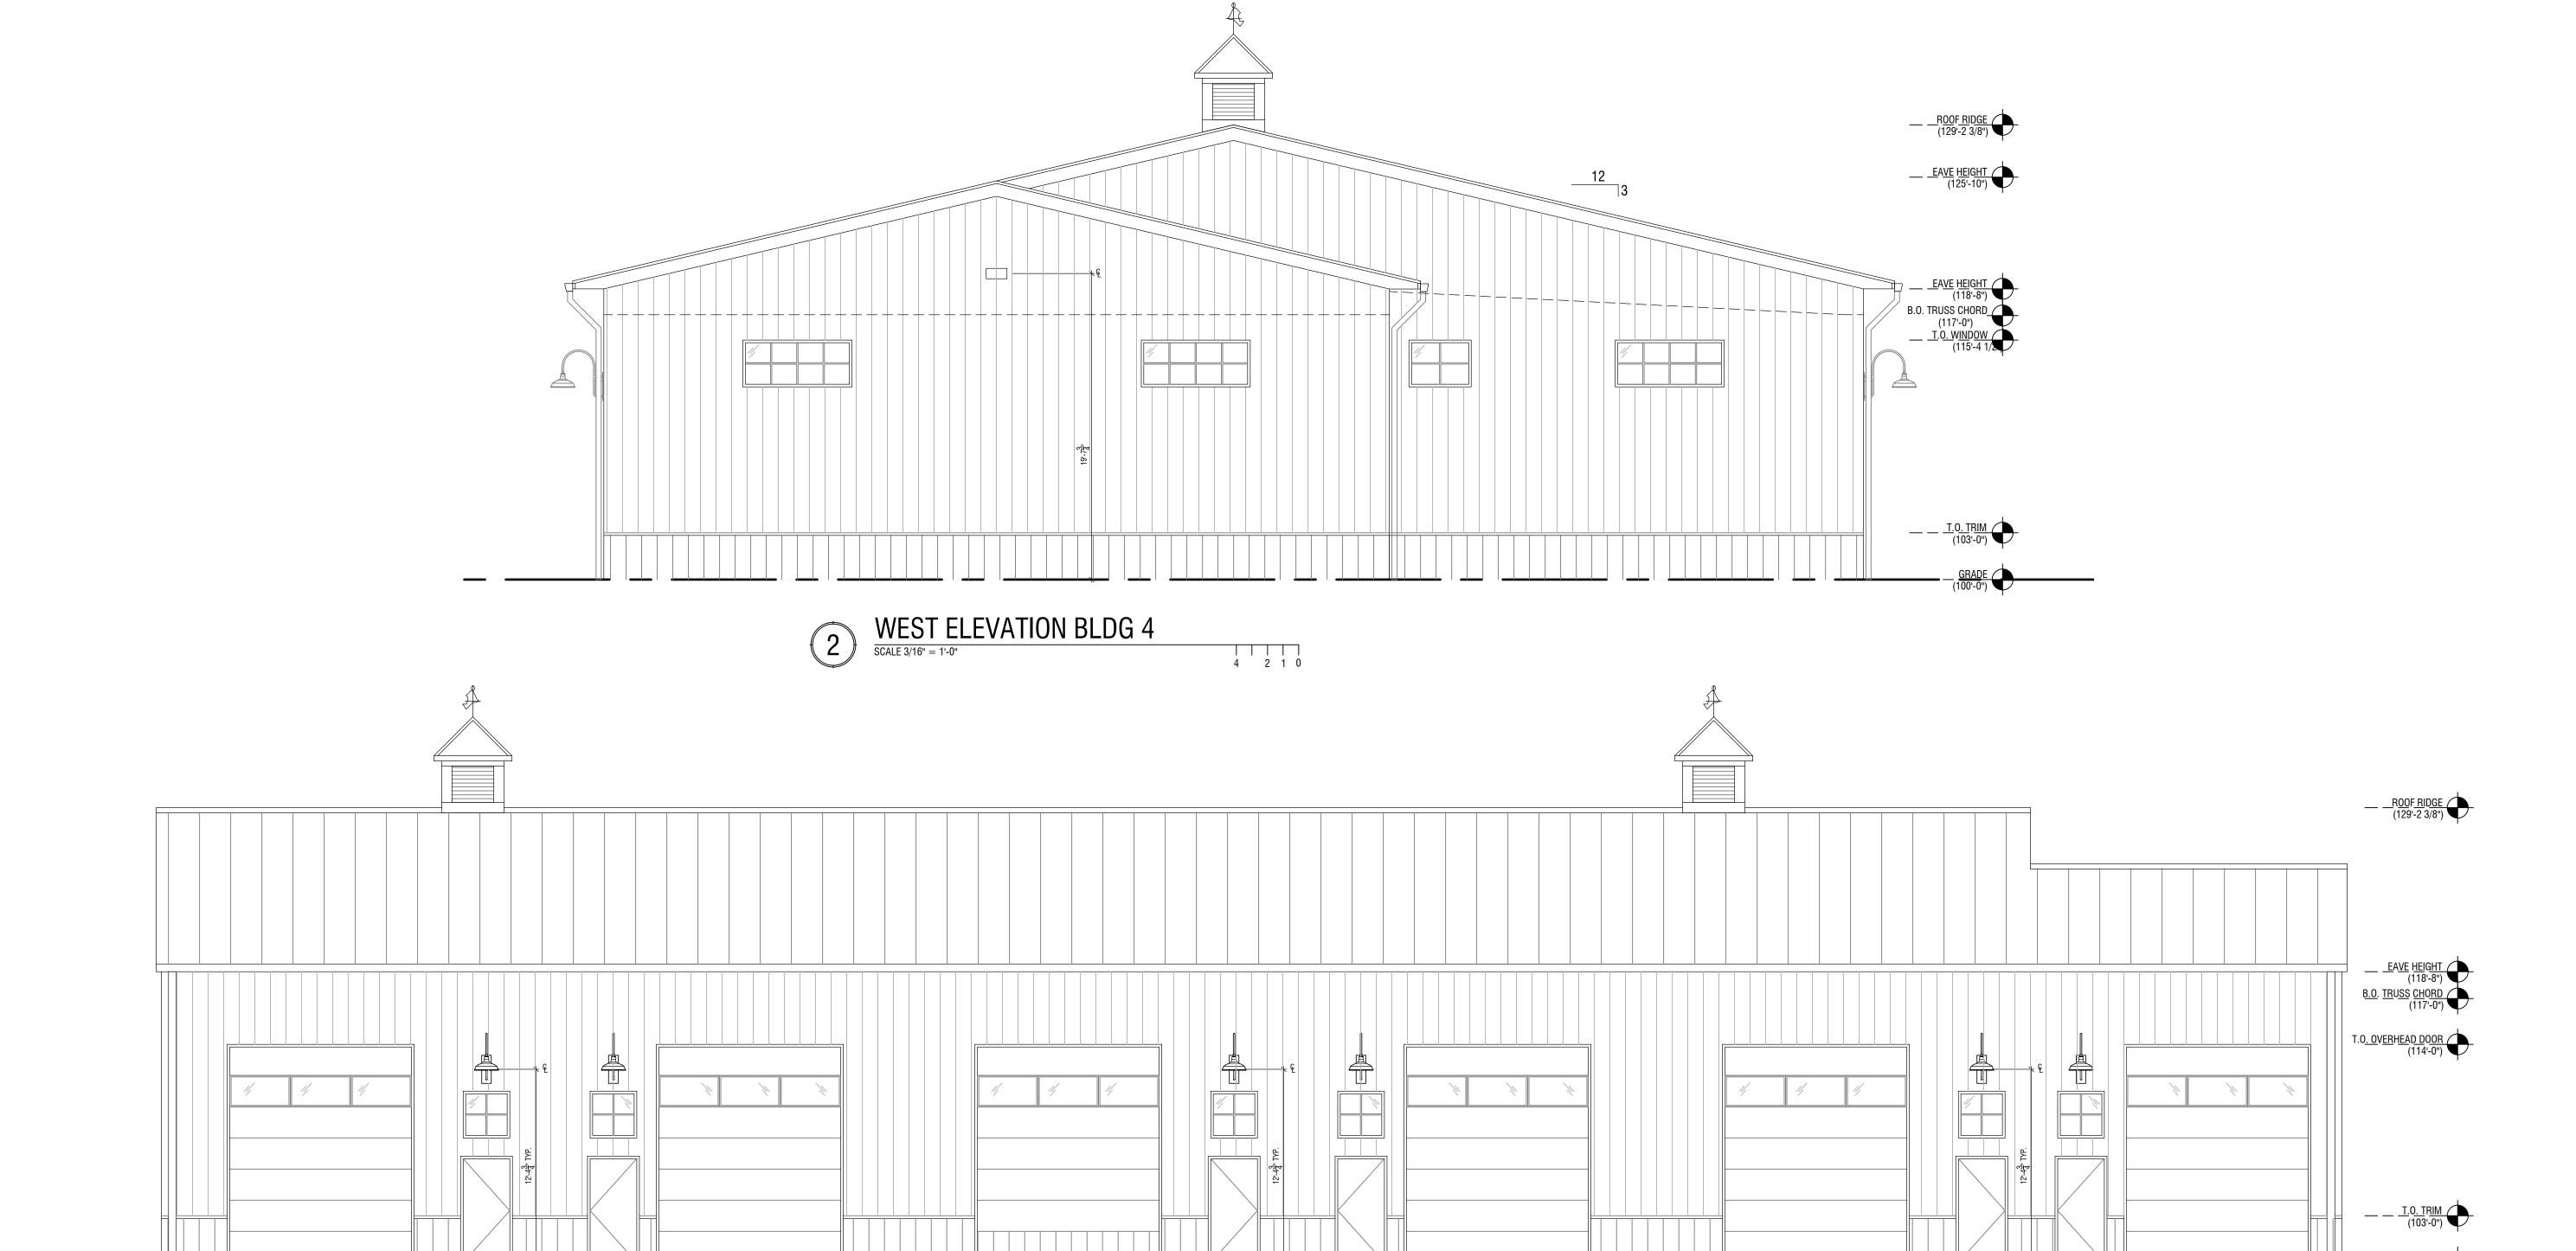


4 2 1 0

NORTH ELEVATION BLDG 4
SCALE 3/16" = 1'-0"



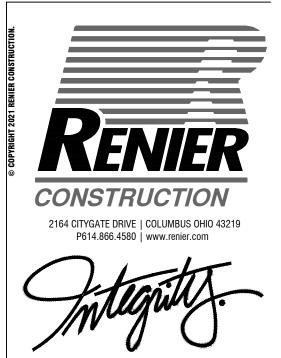

HORSE POWER FARMS PHASE 2

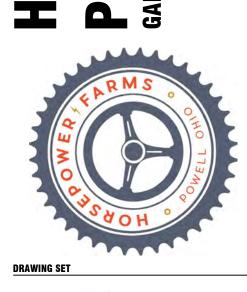




PROJECT NUMBER

020164

SHEET TITLE

EXTERIOR ELEVATIONS - BUILDING 4


A4.02

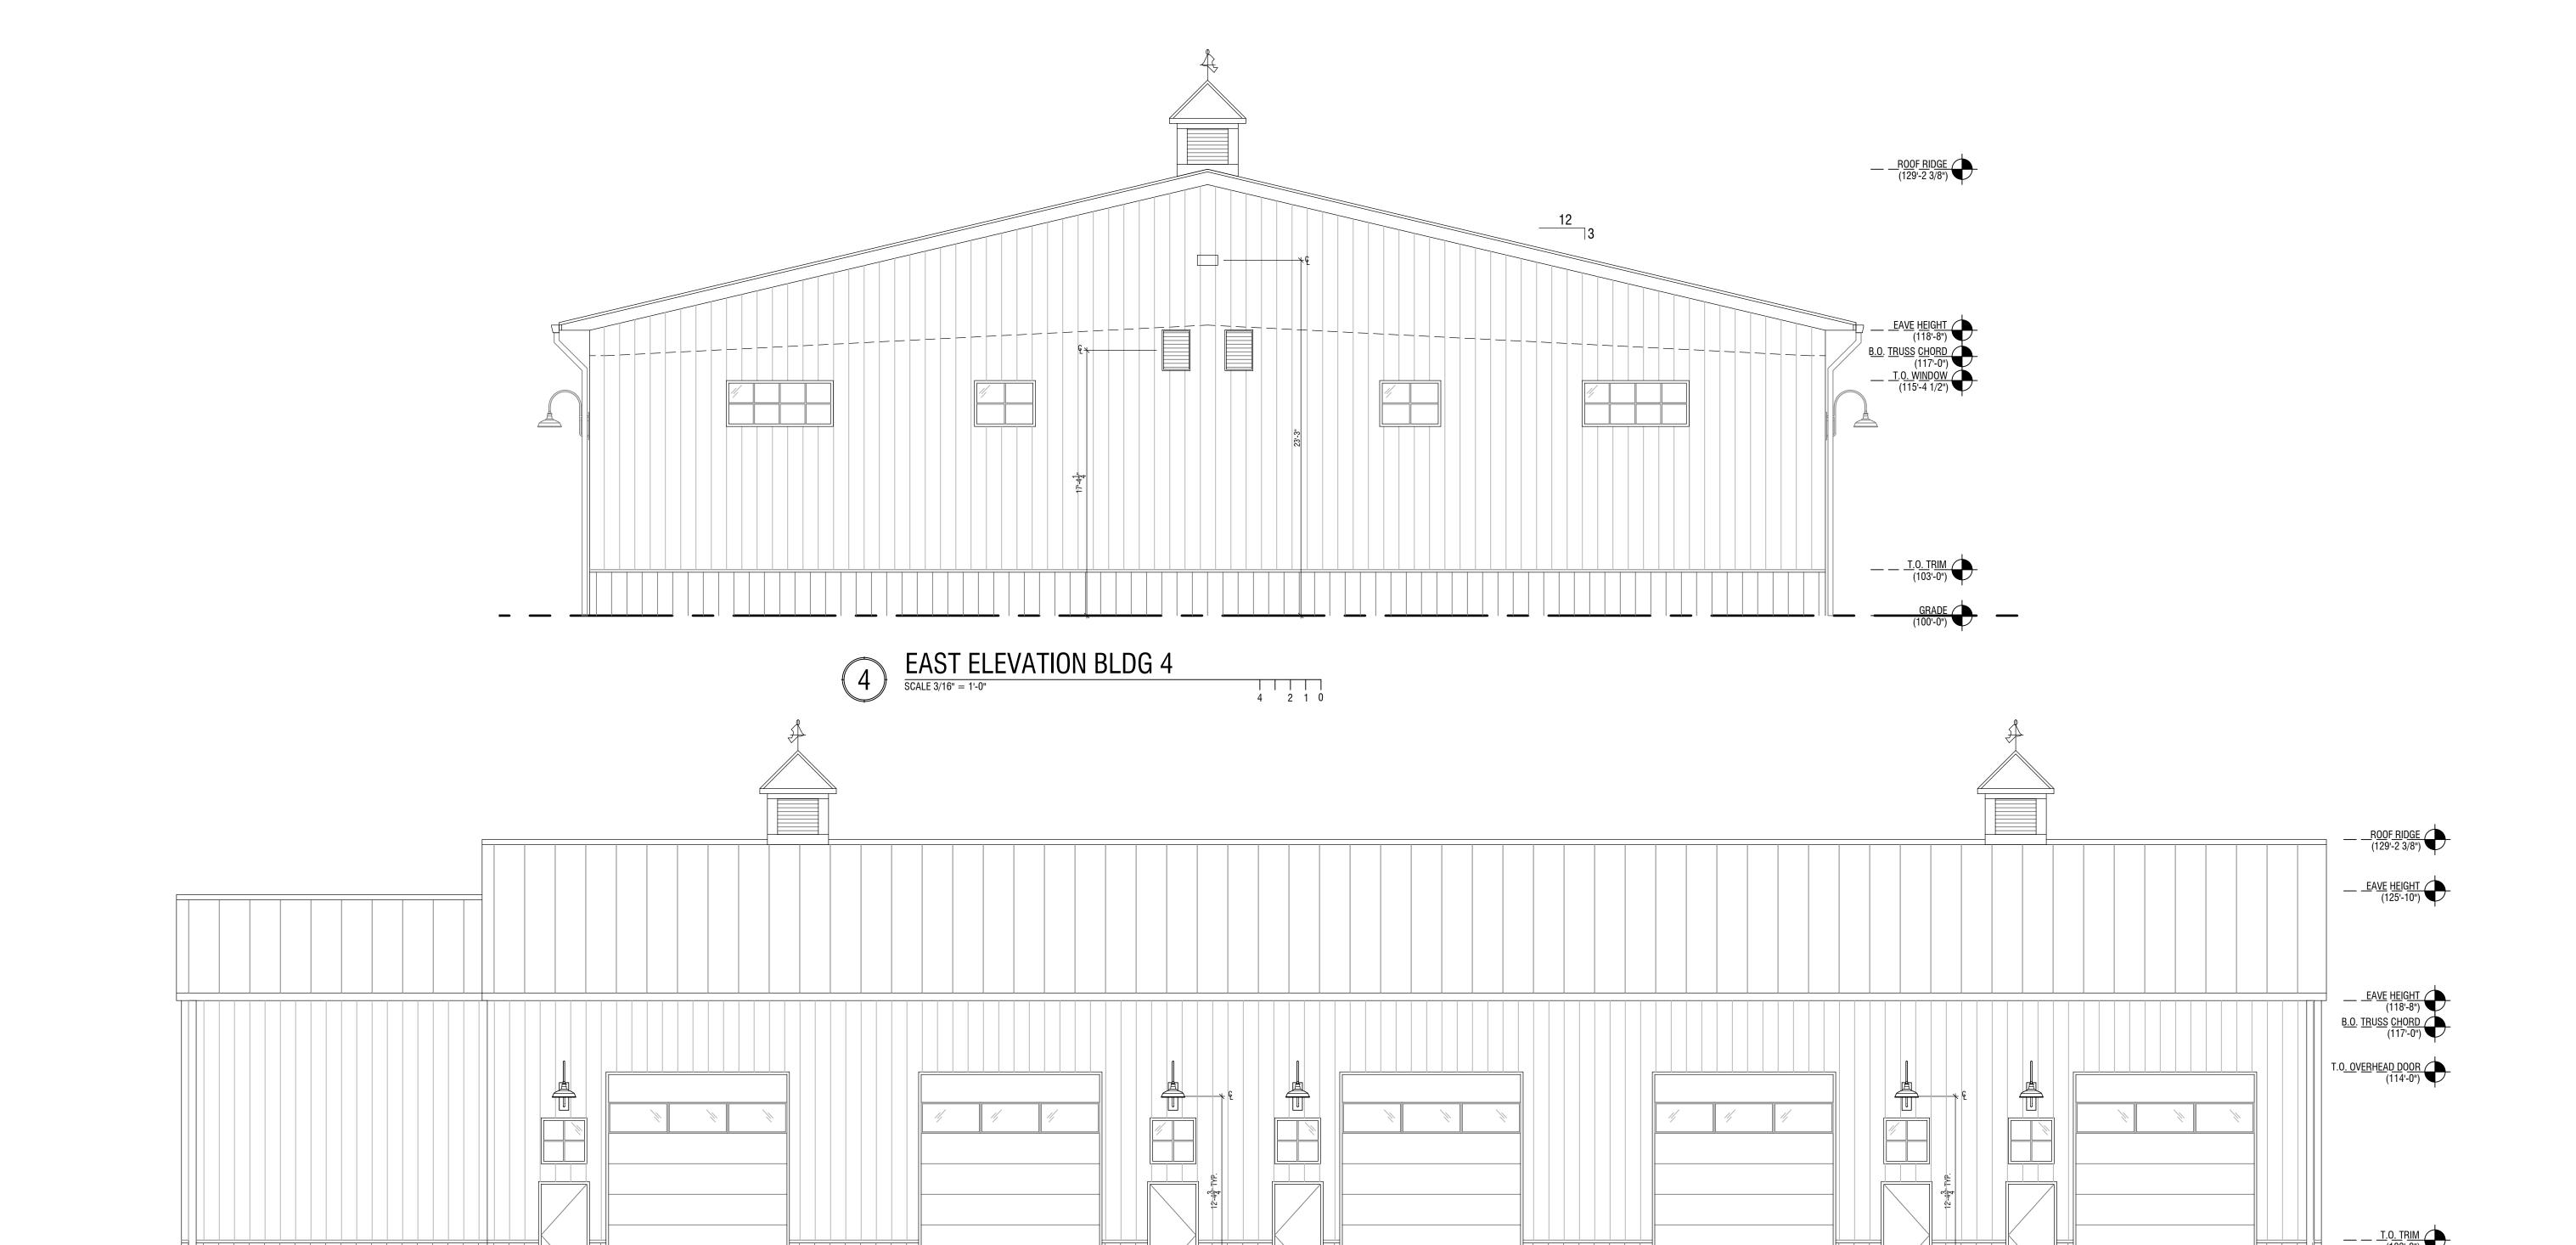

4 2 1 0

3 SOUTH ELEVATION BLDG 4
SCALE 3/16" = 1'-0"



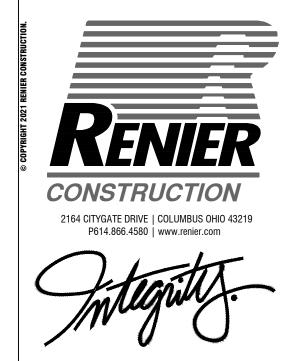

**FARMS** POWER



\_\_\_\_<u>EAVE HEIGHT</u> (124'-5")


EAVE HEIGHT (118'-8")

B.O. TRUSS CHORD (117'-0")

T.<u>O. OVERHEAD DOOR</u> (114'-0")

020164


SHEET TITLE
EXTERIOR ELEVATIONS - BUILDING 5

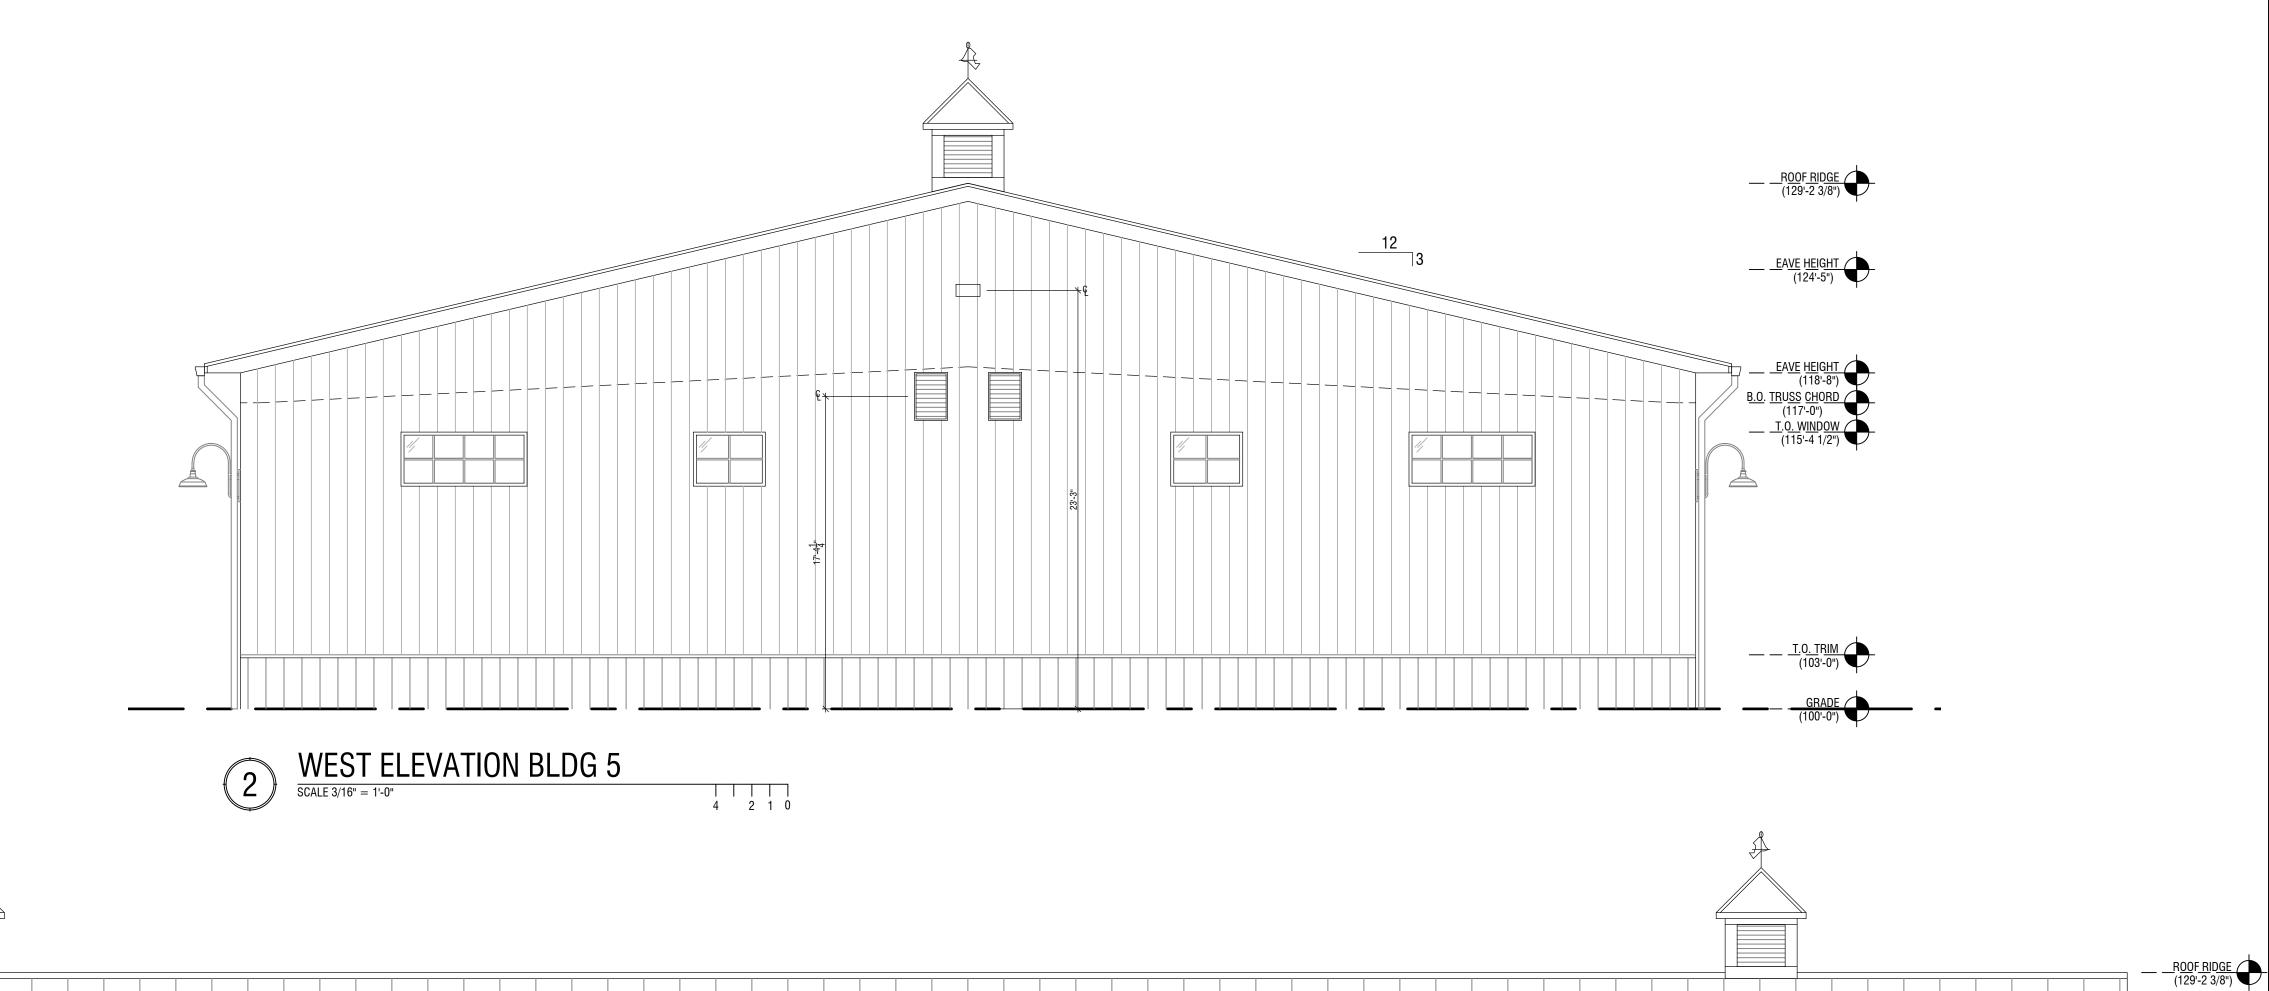

NORTH ELEVATION BLDG 5
SCALE 3/16" = 1'-0"

4 2 1 0



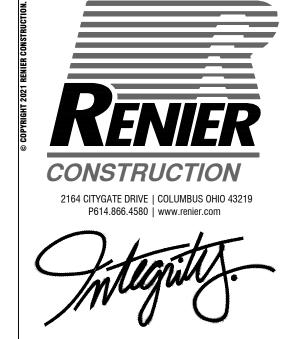

POWER FARMS

HORSE POWE PHASE 2



| 02 | 10 | 2021 | preliminary check set | bid | permit | construction

permit construction

WOI FOR COME TRUE TO THE


PROJECT NUMBER

O20164


SHEET TITLE

EXTERIOR ELEVATIONS - BUILDING 5

A4.02

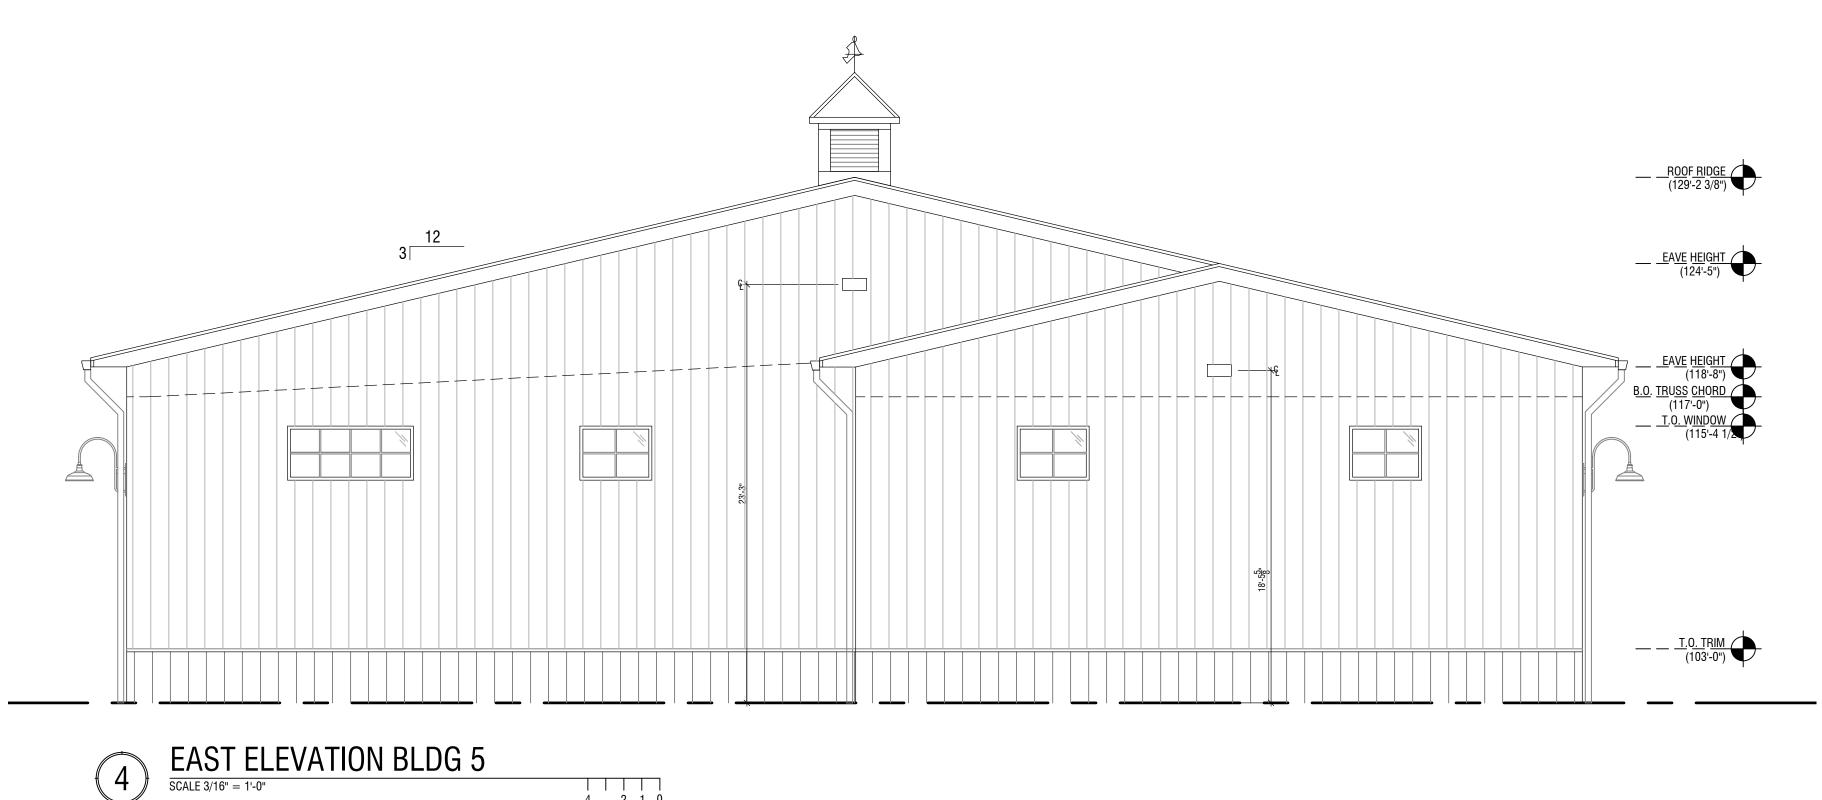


Could there be an opportunity to introduce a shed dormer on the elevations that face each other? This could provide additional daylighting and help break up the extensive roof.

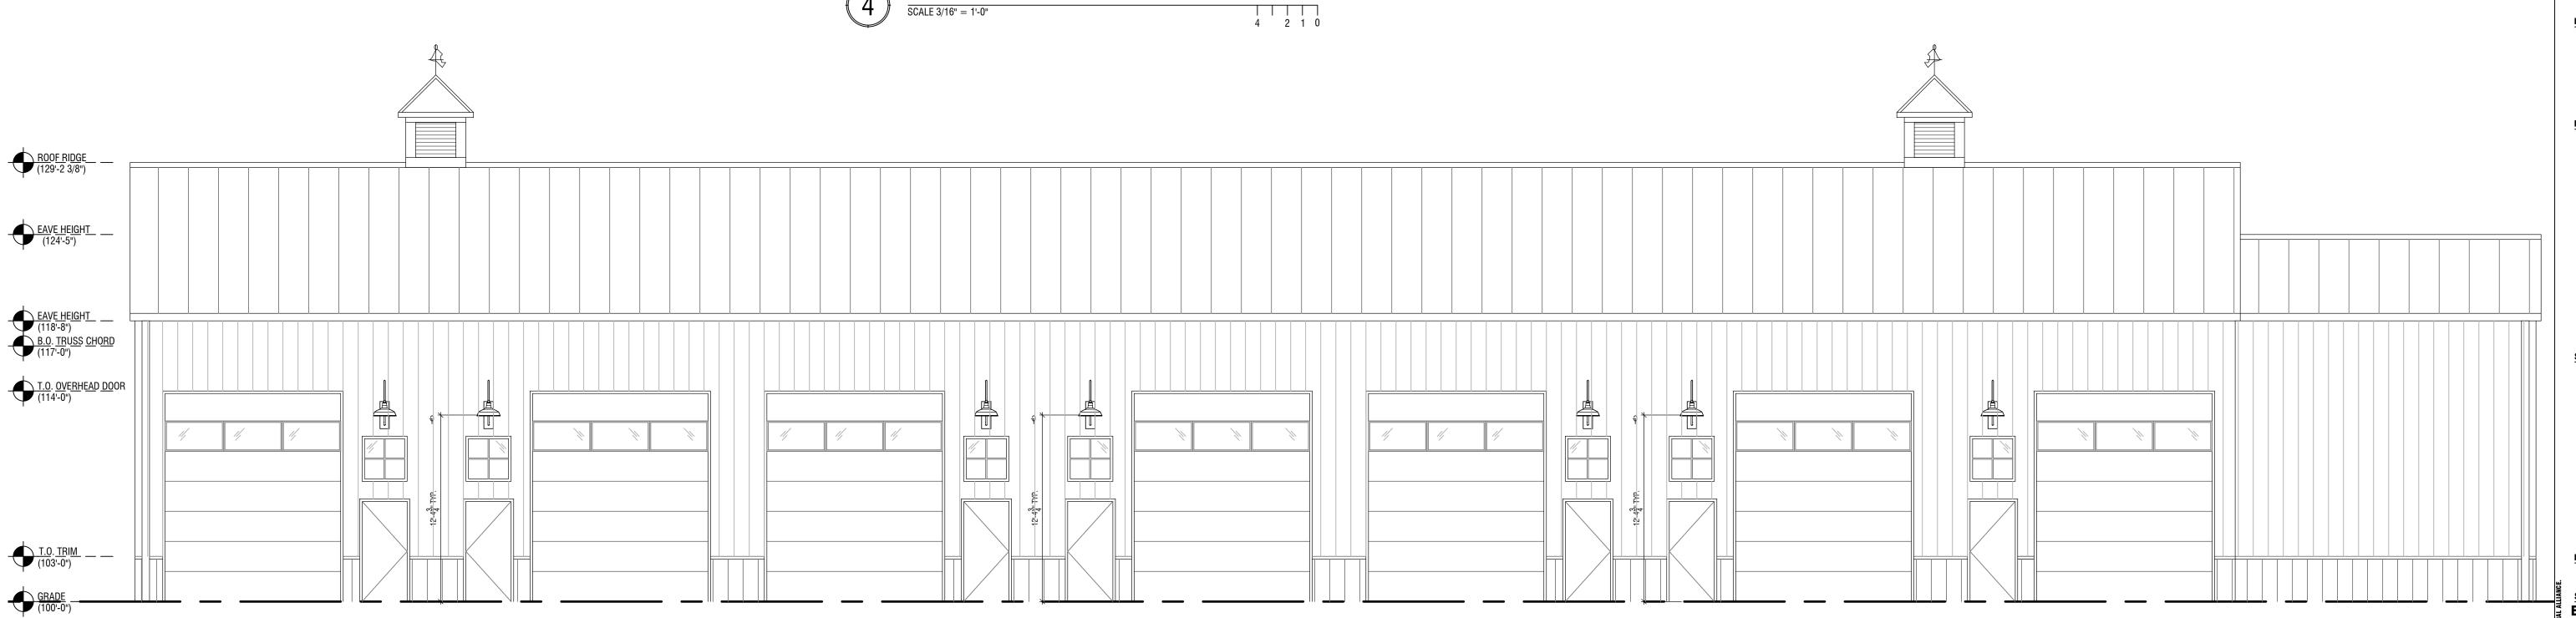

4 2 1 0



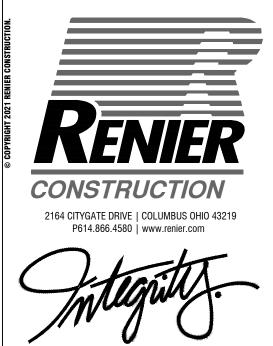

FARMS

HORSE POWER PHASE 2



O2 | 10 | 2021 | preliminary check set bid permit construction

WOT FOR THUS TON


PROJECT NUMBER


020164


SHEET TITLE

EXTERIOR ELEVATIONS - BUILDING 6

**A4.01** 

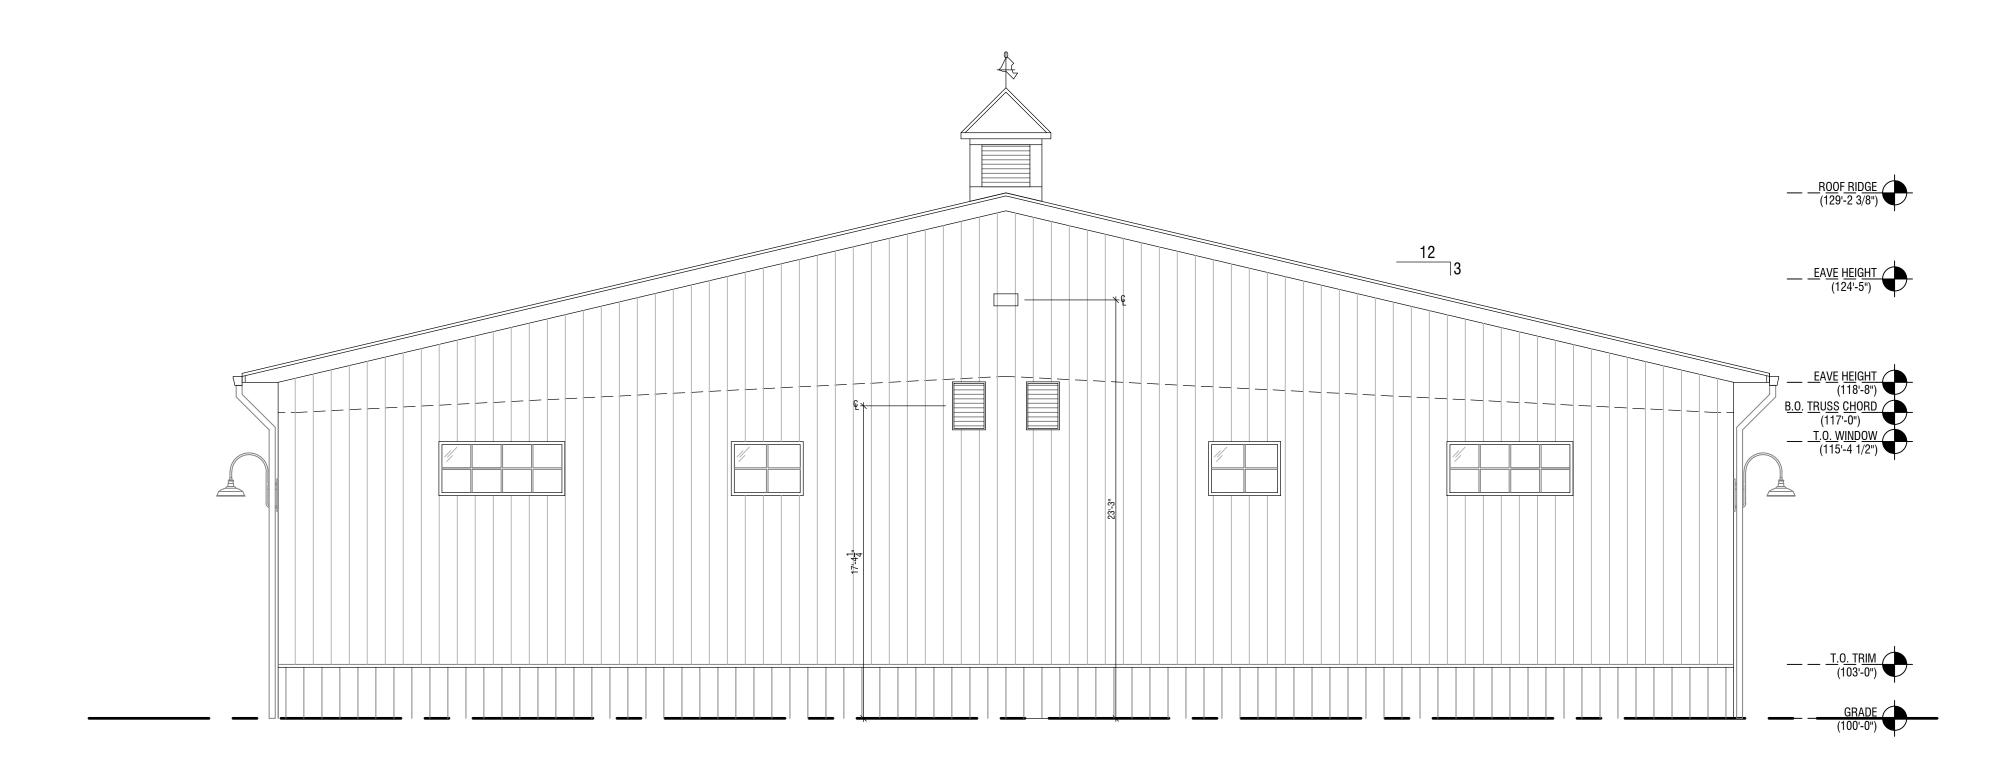

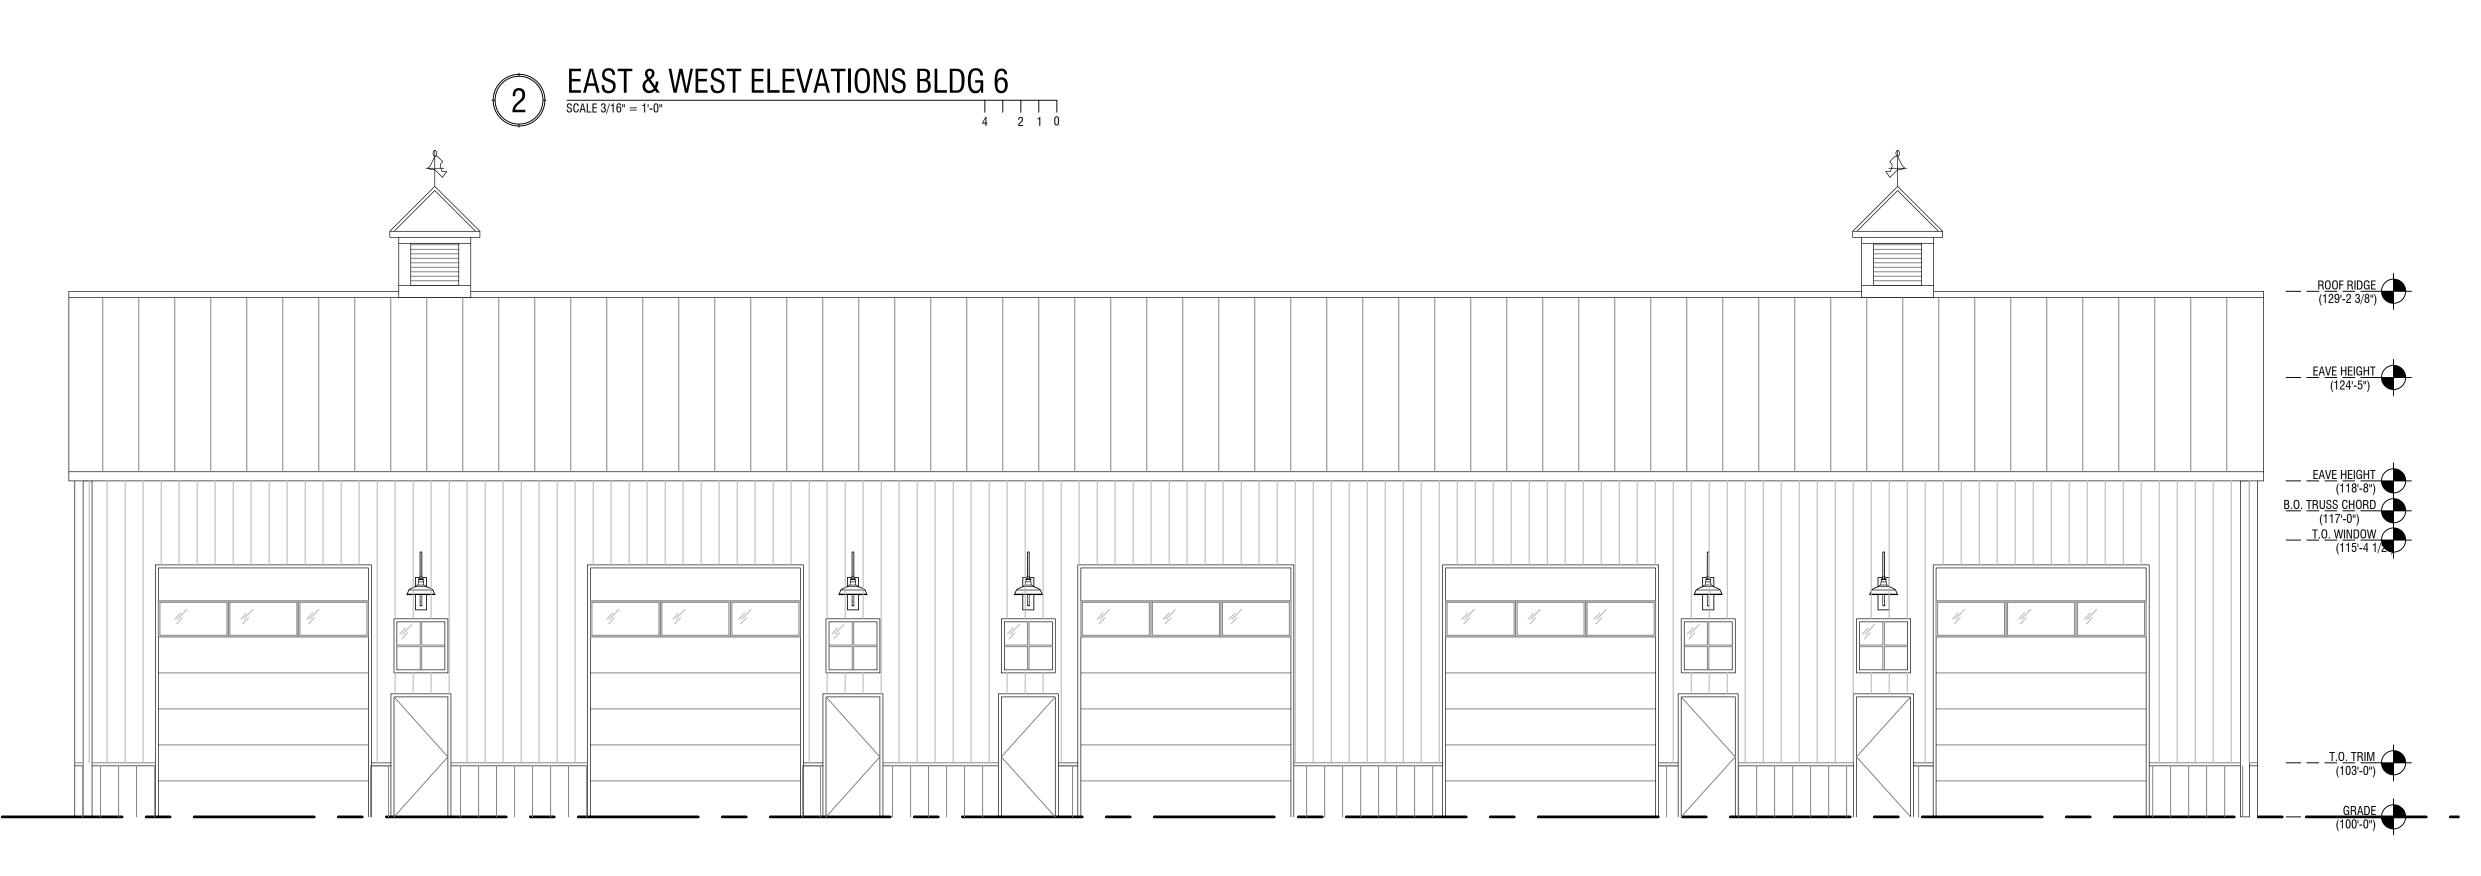

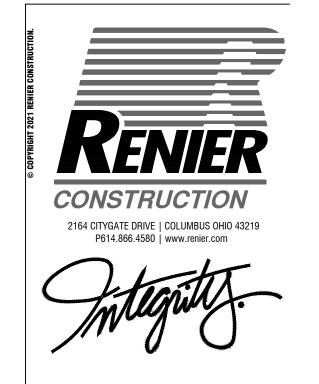

ORSE POWER FARMS



| 02 | 10 | 2021 | preliminary | check set | bid | permit | construction | |

WOT FOR THUS TON


PROJECT NUMBER

020164

SHEET TITLE

EXTERIOR ELEVATIONS - BUILDING 7


**A4.01** 

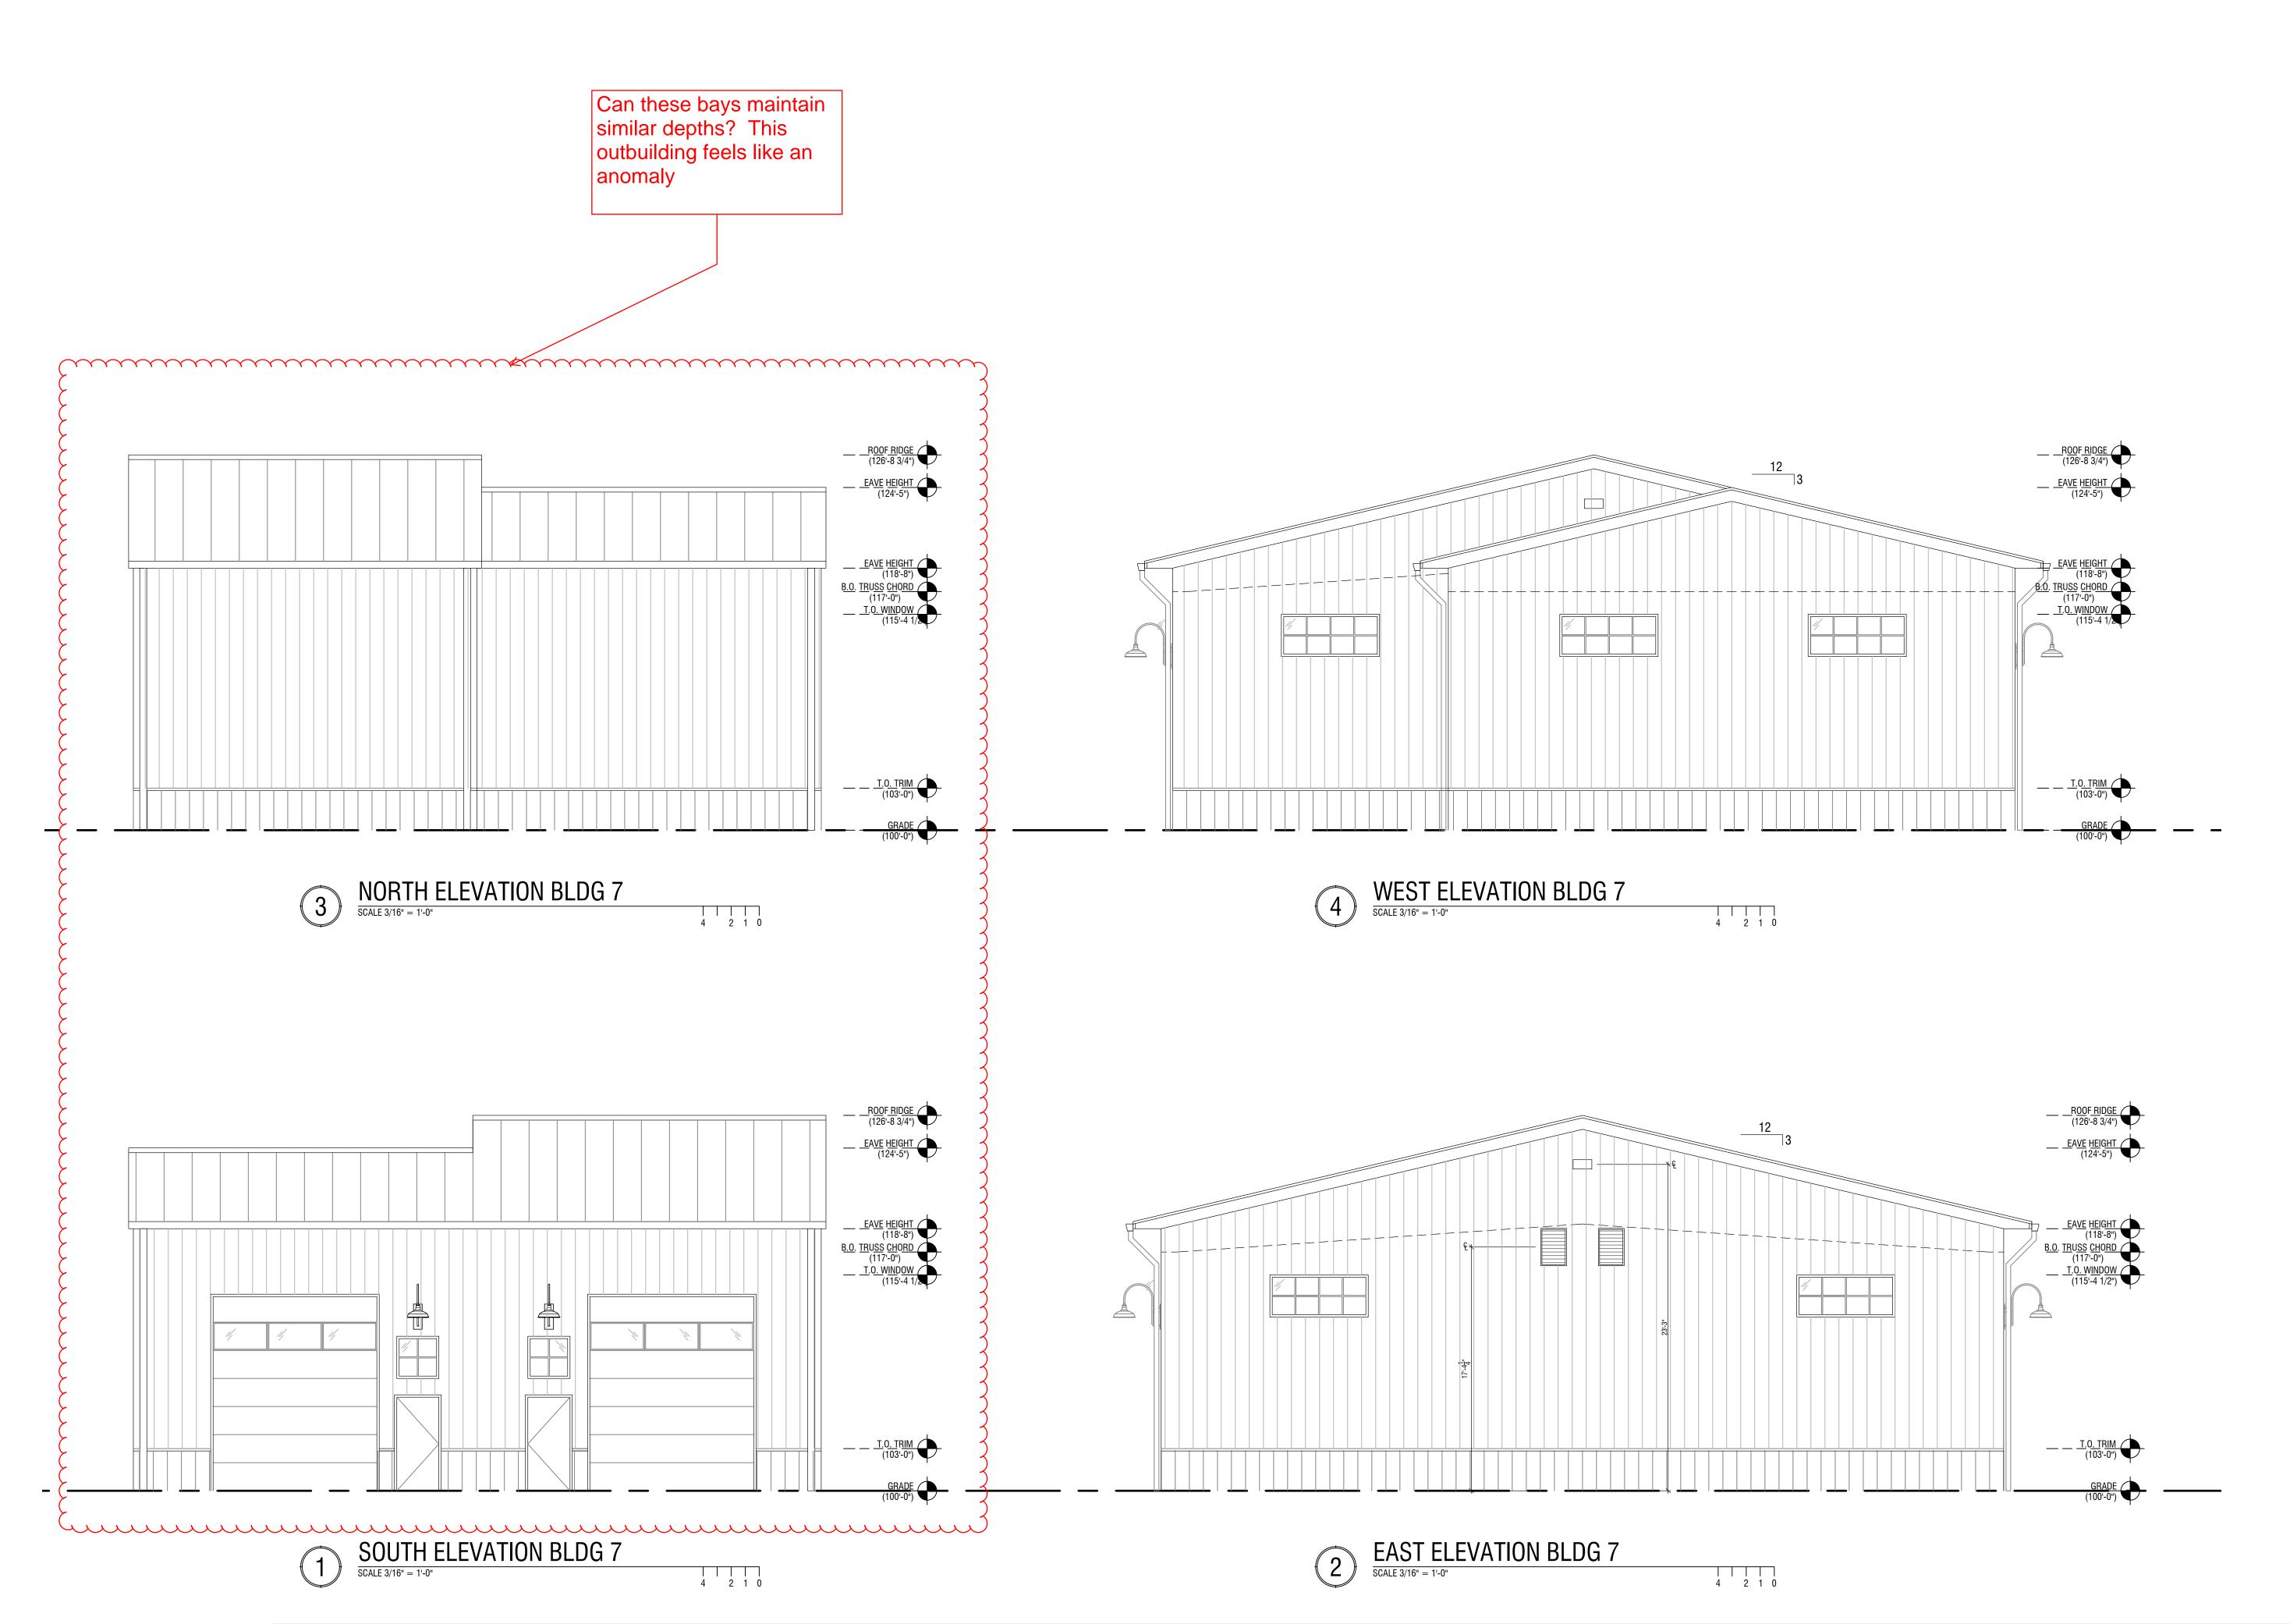








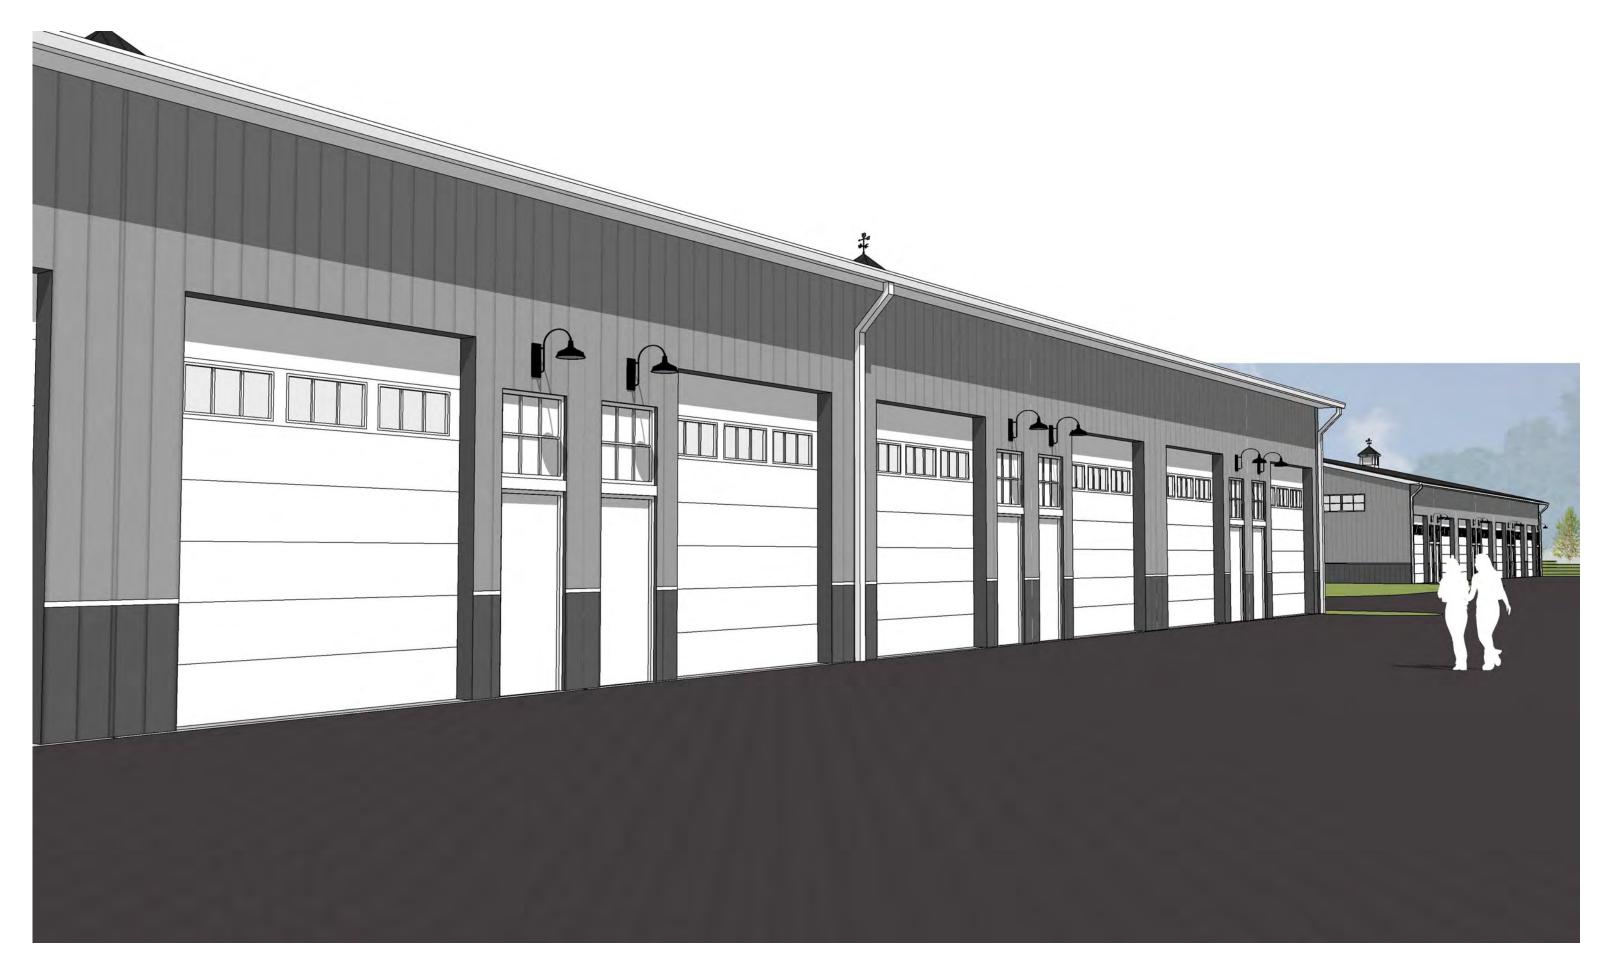





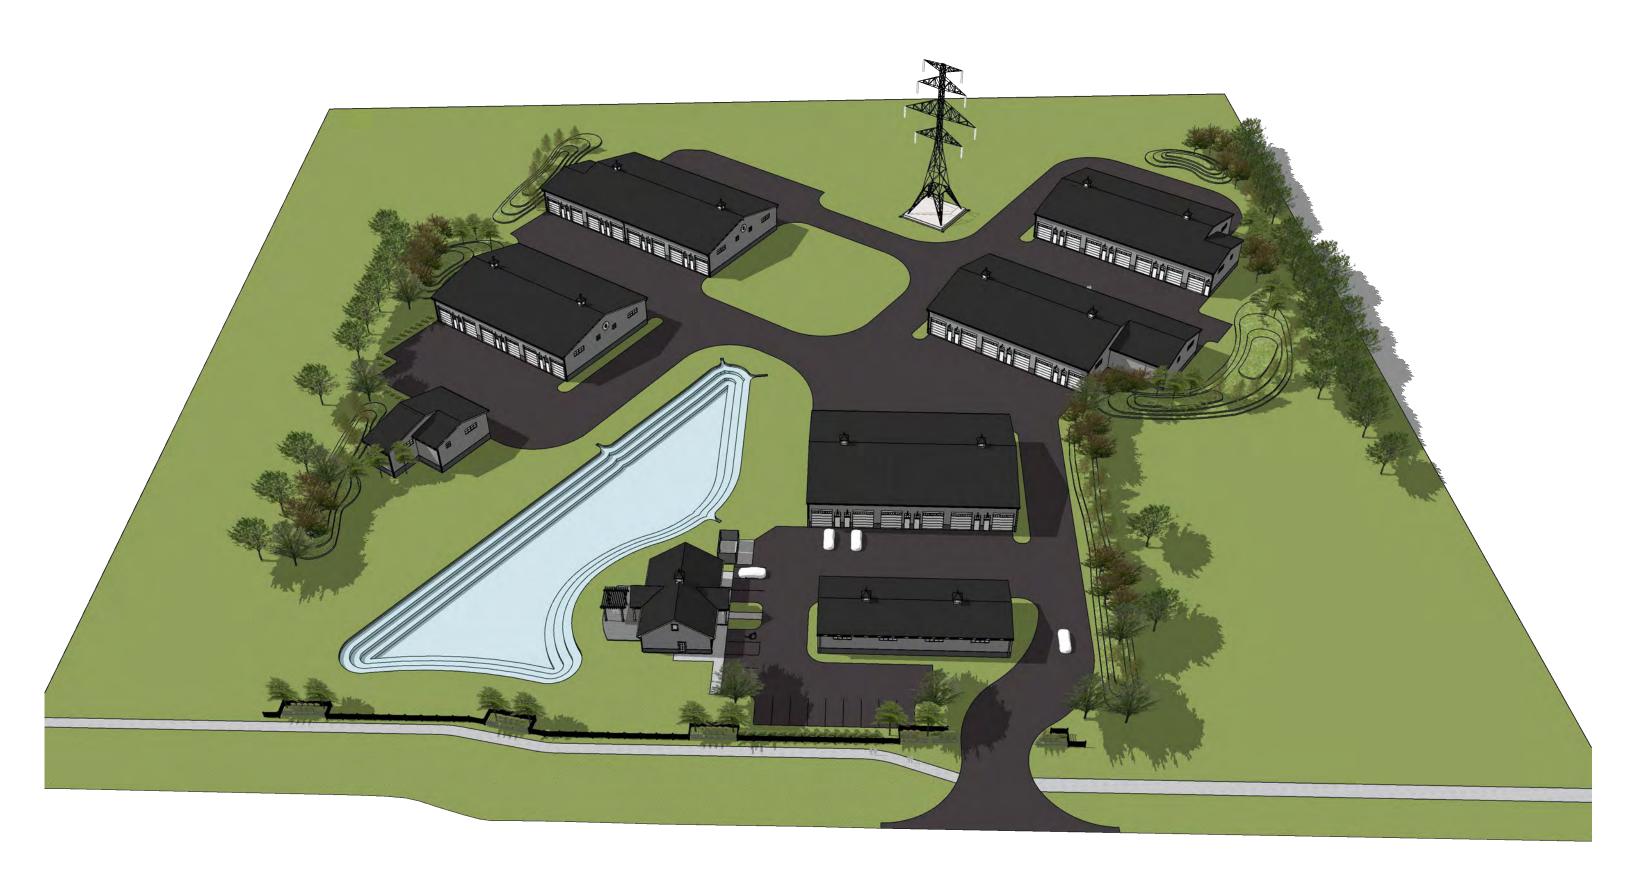














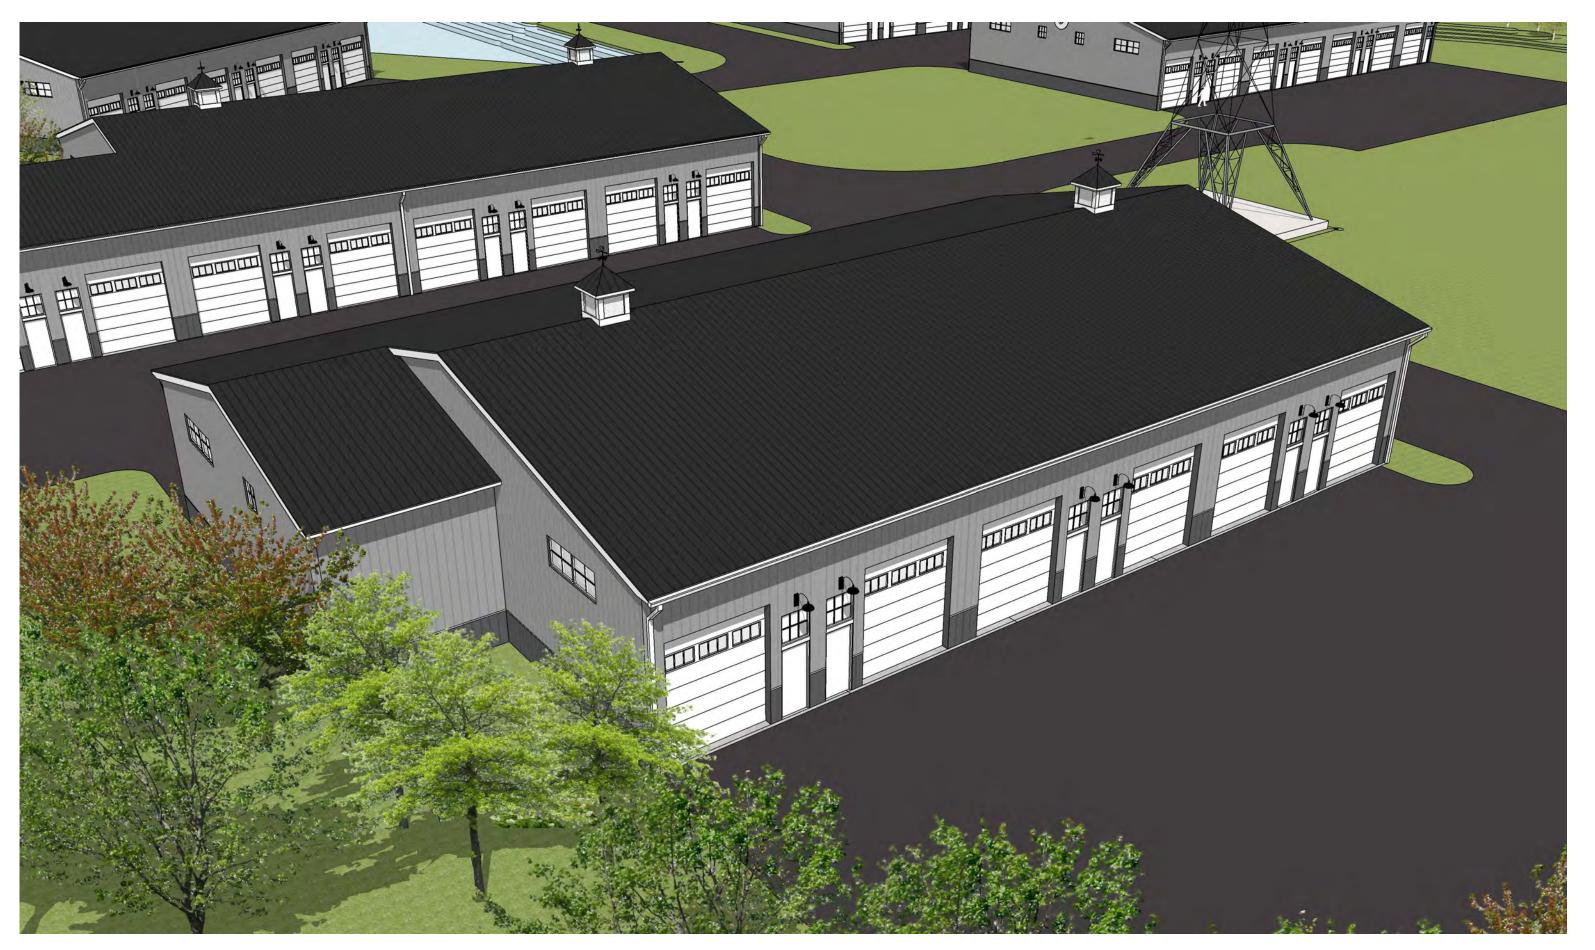










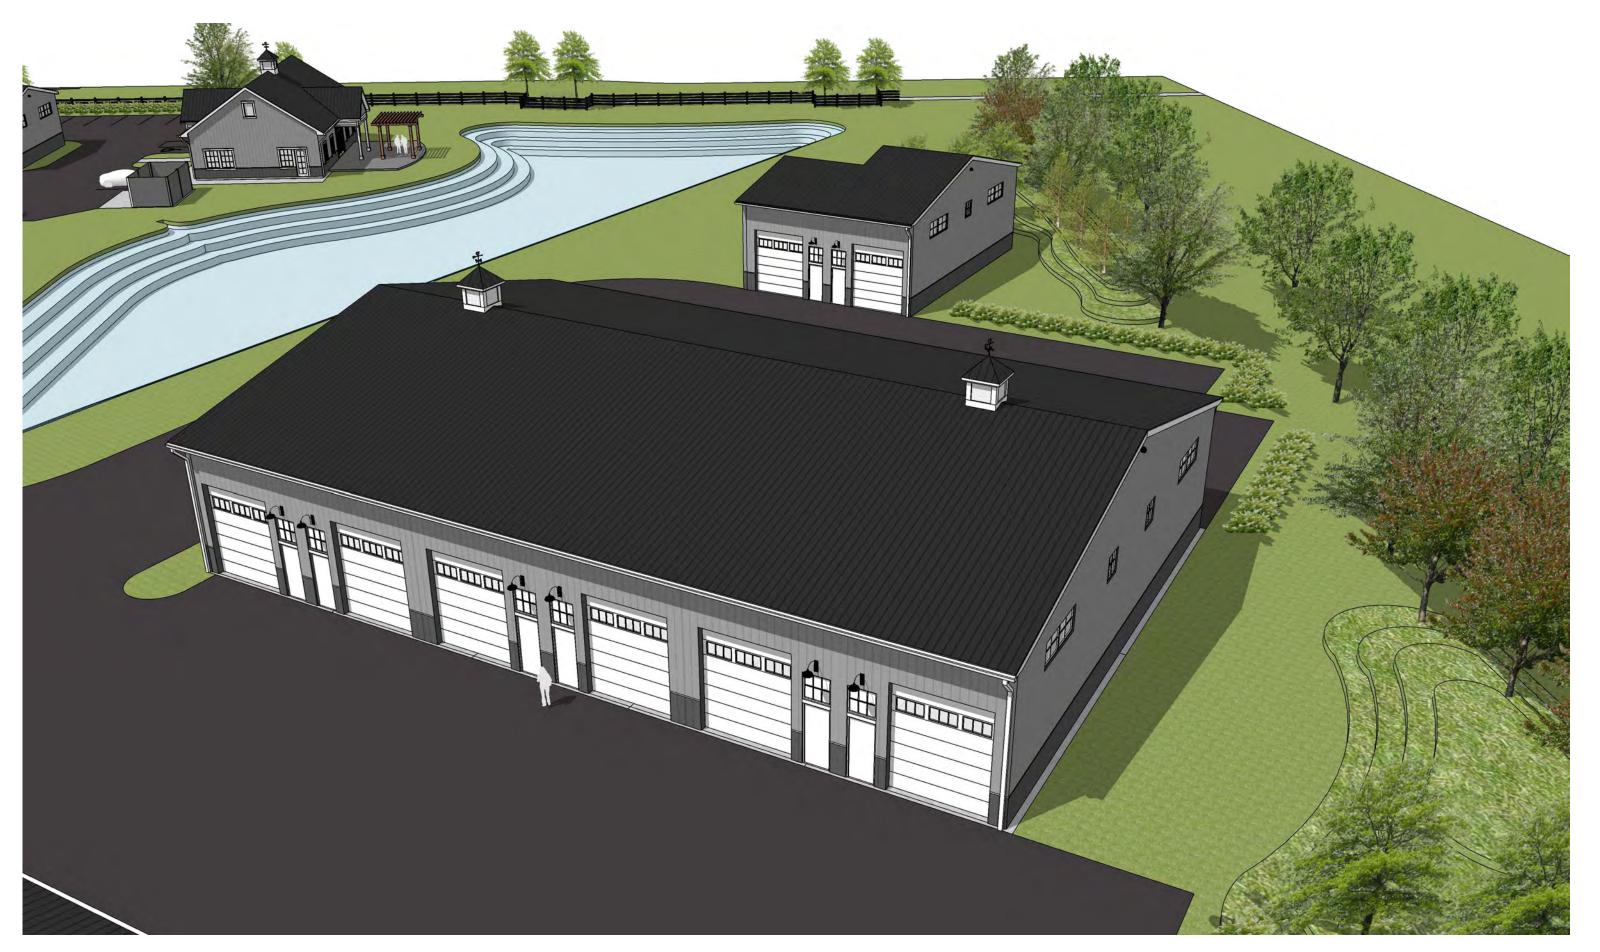







Submitted By LIGHTING SYSTEMS OF COLUMBUS

Catalog Number
WST LED P3 27K VW MVOLT DDBXD

Notes

D<sub>2</sub>



#### **WST LED**

Architectural Wall Sconce







Are these on the

buildings? Could this\*

ends of the

gooseneck?

also be a



Hit the Tab key or mouse over the page to see all interactive elements.

#### **Specifications**

#### Luminaire

Height: 8-1/2" (21.59 cm)

Width: 17" (43.18 cm)

**Depth:** 10-3/16" (25.9 cm)

**Weight:** 20 lbs (9.1 kg)




#### Optional Back Box (PBBW)

Height: 8.49" (21.56 cm)
Width: 17.01"

(43.21 cm)

**Depth:** 1.70" (4.32 cm)

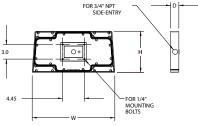

#### **Optional Back Box (BBW)**

Height:


**4"** (10.2 cm)

Width:

5-1/2" (14.0 cm)

Depth:

1-1/2" (3.8 cm)

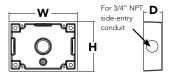

#### \*\* Capable Luminaire

This item is an A+ capable luminaire, which has been designed and tested to provide consistent color appearance and system-level interoperability.

All configurations of this luminaire meet the Acuity Brands' specification for chromatic consistency

This luminaire is A+ Certified when ordered with DTL® controls marked by a shaded background. DTL DLL equipped luminaires meet the A+ specification for luminaire to photocontrol interoperability1

 This luminaire is part of an A+ Certified solution for ROAM® or XPoint™ Wireless control networks, providing out-of-the-box control compatibility with simple commissioning, when ordered with drivers and control options marked by a shaded background¹

To learn more about A+, visit <a href="www.acuitybrands.com/aplus">www.acuitybrands.com/aplus</a>.

See ordering tree for details.

A+ Certified Solutions for ROAM require the order of one ROAM node per luminaire. Sold Separately: <u>Link to Roam</u>; <u>Link to DTL DLL</u>





Submitted By LIGHTING SYSTEMS OF COLUMBUS

Catalog Number WST LED P3 27K VW MVOLT DDBXD

Notes



Ordering	Information		EX	KAMPLE: WST L	ED P1 40K VF MVOLT DDBTXD
WST LED	P3	27K	VW	MVOLT	
Series	Performance Package	Color temperature	Distribution	Voltage	Mounting
WST LED	P1 1,500 Lumen package P2 3,000 Lumen package P3 6,000 Lumen package	27K 2700 K 30K 3000 K 40K 4000 K 50K 5000 K	VF Visual comfort forward throw VW Visual comfort wide	MVOLT <sup>1</sup> 277 <sup>2</sup> 120 <sup>2</sup> 347 <sup>2</sup> 208 <sup>2</sup> 480 <sup>2</sup> 240 <sup>2</sup>	Shipped included (blank) Surface mounting bracket Shipped separately BBW Surface-mounted back box <sup>3</sup> PBBW Premium surface-mounted back box <sup>3,4</sup>
					DDBXD

				DDBXD	1
Options				Finish (requ	uired)
NLTAIR2 PIR NLTAIR2 PIRH PE PER PER5 PER7 PIR PIR1FC3V PIRH PIRH1FC3V SF DF DS DMG E7WH	nLIGHT AIR Wireless enabled motion/ambient sensor for 8'-15' mounting heights 5.6 nLIGHT AIR Wireless enabled motion/ambient sensor for 15'-30' mounting heights 5.6 Photoelectric cell, button type 7 NEMA twist-lock receptacle only (controls ordered separate) 8 Five-wire receptacle only (controls ordered separate) 8 Seven-wire receptacle only (controls ordered separate) 8 Motion/Ambient Light Sensor, 8-15' mounting height.56 Motion/ambient sensor, 8-15' mounting height, ambient sensor enabled at 1fc 5.6 180° motion/ambient light sensor, 15-30' mounting height 5.6 Motion/ambient sensor, 15-30' mounting height, ambient sensor enabled at 1fc 5.6 Single fuse (120, 277, 347V)² Double fuse (208, 240, 480V)² Dual switching³ 0-10V dimming extend out back of housing for external control (control ordered separate)³ Emergency battery backup, Non CEC compliant (7W)¹¹	E7WC E7WHR E20WH E20WC E23WHR LCE RCE Shipped RBPW VG WG	Emergency battery backup, CA Title 20 Noncompliant (cold, 7W) <sup>11,12</sup> Remote emergency battery backup, CA Title 20 Noncompliant (remote 7W) <sup>11,13</sup> Emergency battery pack 18W constant power, Certified in CA Title 20 MAEDBS <sup>11</sup> Emergency battery pack -20°C 18W constant power, Certified in CA Title 20 MAEDBS <sup>11,12</sup> Remote emergency battery backup, CA Title 20 Noncompliant (remote 20W) <sup>11,12,14</sup> Left side conduit entry <sup>15</sup> Right side conduit entry <sup>15</sup> separately Retrofit back plate <sup>3</sup> Vandal guard <sup>15</sup> Wire guard <sup>15</sup>	DDBXD DBLXD DNAXD DWHXD DSSXD DDBTXD DBLBXD DNATXD DWHCXD DSSTXD	Dark bronze Black Natural aluminum White Sandstone Textured dark bronze Textured black Textured natural aluminum Textured white Textured sandstone

#### **Accessories**

Ordered and shipped separately.

WSTVCPBBW DDBXD U Premium Surface - mounted back box WSBBW DDBTXD U Surface - mounted back box RBPW DDBXD U Retrofit back plate

Photocell - SSL twist-lock (120-277V)17 DLL127F 1.5 JU DLL347F 1.5 CUL JU Photocell - SSL twist-lock (347V)17 DLL480F 1.5 CUL JU Photocell - SSL twist-lock (480V)17

#### NOTES

- MVOLT driver operates on any line voltage from 120-277V (50/60 Hz).
- Single fuse (SF) requires 120V, 277V or 347V. Double fuse (DF) requires 208V, 240V or 480V.
- Also available as a separate accessory; see accessories information.
- Top conduit entry standard.

WST LED P1 27K VF MVOLT E7WH


- Not available with VG or WG. See PER Table.
- Reference Motion Sensor table.
- Need to specify 120, 208, 240 or 277 voltage.
- Photocell ordered and shipped as a separate line item from Acuity Brands Controls. Shorting Cap included.
- 9 Not available with Emergency options, PE or PER options.
   10 DMG option not available with standalone or networked sensors/controls.
- 11 Not available with 347/480V.
- 12 Battery pack rated for -20° to 40°C.
- 13 Comes with PBBW.
- 14 Warranty period is 3-years.
- 15 Not available with BBW.


- 16 Must order with fixture; not an accessory.
   17 Requires luminaire to be specified with PER, PER5 or PER7 option. See PER Table.

#### **Emergency Battery Operation**


The emergency battery backup is integral to the luminaire — no external housing required! This design provides reliable emergency operation while maintaining the aesthetics of the product. All emergency backup configurations include an independent secondary driver with an integral relay to immediately detect AC power loss, meeting interpretations of NFPA 70/NEC 2008 - 700.16 The emergency battery will power the luminaire for a minimum duration of 90 minutes (maximum duration of three hours) from the time supply power is lost, per International Building Code Section 1006 and NFPA 101 Life Safety Code Section 7.9, provided luminaires are mounted at an appropriate height and illuminate an open space with no major obstructions. The examples below show illuminance of 1 fc average and 0.1 fc minimum of the P1 power package and VF distribution product in emergency mode.


10' x 10' Gridlines 8' and 12' Mounting Height

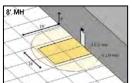

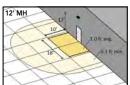

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WST LED P2 40K VF MVOLT E20WH

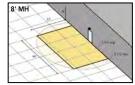

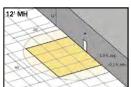

Submitted By
LIGHTING SYSTEMS OF COLUMBUS

Catalog Number
WST LED P3 27K VW MVOLT DDBXD

Notes

D2

#### **Performance Data**

#### **Lumen Ambient Temperature (LAT) Multipliers**

Use these factors to determine relative lumen output for average ambient temperatures from 0-40 °C (32-104 °F).

Amb	Ambient			
0°C	32°F	1.03		
10°C	50°F	1.02		
20°C	68°F	1.01		
25°C	77°F	1.00		
30°C	86°F	0.99		
40°C	104°F	0.98		

#### Projected LED Lumen Maintenance

Values calculated according to IESNA TM-21-11 methodology and valid up to 40°C.

Operating Hours	0	25,000	50,000	100,000
Lumen Maintenance Factor	1.0	>0.95	>0.92	>0.87

#### **Electrical Load**

				Curre	nt (A)		
Performance package	System Watts	120	208	240	277	347	480
P1	11	0.1	0.06	0.05	0.04		
PI	14					0.04	0.03
P1 DS	14	0.12	0.07	0.06	0.06		
P2	25	0.21	0.13	0.11	0.1		
P2	30					0.09	0.06
P2 DS	25	0.21	0.13	0.11	0.1		
P3	50	0.42	0.24	0.21	0.19		
P3	56					0.16	0.12
P3 DS	52	0.43	0.26	0.23	0.21		

Motion Sensor Default Settings								
Option	Dimmed State	High Level (when triggered)	Photocell Operation	Ramp-up Time	Dwell Time	Ramp-down Time		
*PIR or PIRH	3V (37%) Output	10V (100%) Output	Enabled @ 5FC	3 sec	5 min	5 min		
PIR1FC3V or PIRH1FC3V	3V (37%) Output	10V (100%) Output	Enabled @ 1FC	3 sec	5 min	5 min		

<sup>\*</sup>for use with site wide Dusk to Dawn control

#### **PER Table**

Control	PER		PER5 (5 wire)	PER7 (7 wire)							
	(3 wire)		Wire 4/Wire5		Wire 4/Wire5	Wire 6/Wire7					
Photocontrol Only (On/Off)	<b>~</b>	A	Wired to dimming leads on driver	A	Wired to dimming leads on driver	Wires Capped inside fixture					
ROAM	0	<b>✓</b>	Wired to dimming leads on driver	A	Wired to dimming leads on driver	Wires Capped inside fixture					
ROAM with Motion	0	A	Wired to dimming leads on driver	A	Wired to dimming leads on driver	Wires Capped inside fixture					
Futureproof*	0	A	Wired to dimming leads on driver	<b>✓</b>	Wired to dimming leads on driver	Wires Capped inside fixture					
Futureproof* with Motion	0	A	Wired to dimming leads on driver	<b>~</b>	Wired to dimming leads on driver	Wires Capped inside fixture					



<sup>\*</sup>Futureproof means: Ability to change controls in the future.

#### Lumen Output

Lumen values are from photometric tests performed in accordance with IESNA LM-79-08. Data is considered to be representative of the configurations shown, within the tolerances allowed by Lighting Facts.

COMMERCIAL OUTDOOR

Performance W	System Watts	Vatts Dist.	27K (2700K, 70 CRI)				30K (3000K, 70 CRI)							50K (5000K, 70 CRI)								
	(MVOLT <sup>1</sup> )		Lumens	В	U	G	LPW	Lumens	В	U	G	LPW	Lumens	В	U	G	LPW	Lumens	В	U	G	LPW
P1 12W	1314	VF	1,494	0	0	0	125	1,529	0	0	0	127	1,639	0	0	0	137	1,639	0	0	0	137
	1200	VW	1,513	0	0	0	126	1,548	0	0	0	129	1,659	0	0	0	138	1,660	0	0	0	138
P2 25W	25/14	VF	3,163	1	0	1	127	3,237	1	0	1	129	3,469	1	0	1	139	3,468	1	0	1	139
	25W	VW	3,201	1	0	0	128	3,276	1	0	0	131	3,512	1	0	0	140	3,512	1	0	0	140
P3 50	50W	VF	6,025	1	0	1	121	6,165	1	0	1	123	6,609	1	0	1	132	6,607	1	0	1	132
	SUW	VW	6,098	1	0	1	122	6,240	1	0	1	125	6,689	1	0	1	134	6,691	1	0	1	134





Submitted By
LIGHTING SYSTEMS OF COLUMBUS

Catalog Number
WST LED P3 27K VW MVOLT DDBXD


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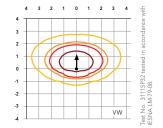
D2

#### **Photometric Diagrams**


To see complete photometric reports or download .ies files for this product, visit Lithonia Lighting's WST LED homepage.

Isofootcandle plots for the WST LED P3 40K VF and VW. Distances are in units of mounting height (10').



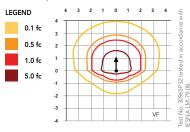

Distribution overlay comparison to 175W metal halide.

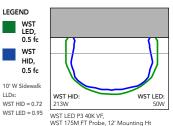

#### **FEATURES & SPECIFICATIONS**

#### INTENDED USE

The classic architectural shape of the WST LED was designed for applications such as hospitals, schools, malls, restaurants, and commercial buildings. The long life LEDs and driver make this luminaire nearly maintenance-free.

#### CONSTRUCTION

The single-piece die-cast aluminum housing integrates secondary heat sinks to optimize thermal transfer from the internal light engine heat sinks and promote long life. The driver is mounted in direct contact with the casting for a low operating temperature and long life. The die-cast door frame is fully gasketed with a one-piece solid silicone gasket to keep out moisture and dust, providing an IP65 rating for the luminaire.

#### FINISH

Exterior parts are protected by a zinc-infused Super Durable TGIC thermoset powder coat finish that provides superior resistance to corrosion and weathering. A tightly controlled multi-stage process ensures a minimum 3 mils thickness for a finish that can withstand extreme climate changes without cracking or peeling. Standard Super Durable colors include dark bronze, black, natural aluminum, sandstone and white. Available in textured and non-textured finishes.

#### OPTICS

Well crafted reflector optics allow the light engine to be recessed within the luminaire, providing visual comfort, superior distribution, uniformity, and spacing in wall-mount applications. The WST LED has zero uplight and qualifies as a Nighttime Friendly™ product, meaning it is consistent with the LEED³ and Green Globes™ criteria for eliminating wasteful uplight.

COMMERCIAL OUTDOOR

#### **ELECTRICAL**

Light engine(s) consist of 98 high-efficacy LEDs mounted to a metal core circuit board and integral aluminum heat sinks to maximize heat dissipation and promote long life (100,000 hrs at 40°C, L87). Class 2 electronic driver has a power factor >90%, THD <20%. Easily-serviceable surge protection device meets a minimum Category B (per ANSI/IEEE C62.41.2).

#### INSTALLATION

A universal mounting plate with integral mounting support arms allows the fixture to hinge down for easy access while making wiring connections.

#### LISTINGS

CSA certified to U.S. and Canadian standards. Luminaire is IP65 rated. PIR and back box options are rated for wet location. Rated for -30°C to  $40^{\circ}$ C ambient.

DesignLights Consortium® (DLC) Premium qualified product. Not all versions of this product may be DLC Premium qualified. Please check the DLC Qualified Products List at <a href="https://www.designlights.org/QPL">www.designlights.org/QPL</a> to confirm which versions are qualified.

#### WARRANTY

5-year limited warranty. Complete warranty terms located at:

**Note:** Actual performance may differ as a result of end-user environment and application. All values are design or typical values, measured under laboratory conditions at 25 °C. Specifications subject to change without notice.





Submitted By LIGHTING SYSTEMS OF COLUMBUS

Catalog Number

SN518-G1/LBA01-1-4000-35K-1SLBCW6-G1/GN24D/SCDC-G1

Notes

VERIFY ARM TYPE/FITURE FINISH, MOUNTING FINISH

Туре

**SN518** 

Custom Build

PROJECT: COMPANY:

PREPARED BY: BUILD DATE: 10/09/2020





#### SN<sub>5</sub>18 - 18" STEP NECK DOME

**Reflector**: Spun from heavy gauge aluminum with an rolled in bead.

Dimensions: Diameter: 18" Height: 11 7/8"

**Max Wattage:** 300W Open fixture. Optional enclosures may reduce max wattage. **Mounting:** Top Mounting with 3/4 NPT. For outdoor use, Teflon tape should be used

around threads.

Finish: Powder Coat Finish for Outdoor use.

**Certification**: Built to UL 1598 and UL Certified for Damp and Wet Locations.



#### **EXTERIOR FINISH:**

... White



#### INTERIOR FINISH:

White





Submitted By LIGHTING SYSTEMS OF COLUMBUS

Catalog Number

SN518-G1/LBA01-1-4000-35K-1SLBCW6-G1/GN24D/SCDC-G1

Notes

VERIFY ARM TYPE/FITURE FINISH, MOUNTING FINISH

уре

**SN518** 

Custom Build

PROJECT: COMPANY:

PREPARED BY: BUILD DATE: 10/09/2020

LBAC1-1-4000-XXK - LBAC1 - SINGLE MODULE, 4000LM, 36W


- LED: 1 x Cree CMA2550 COB
  - Lumen: 4000(36W)
  - o **Kelvin:** 27, 30, 35, 40, 50K Standard
  - o **CRI**: 90CRI
- Driver: ERP PSB Series, 120/277V, 0-10V Dimming down to 1%
  - o *Dimming:* 0-10V, 1%
  - o *Voltage:* 120 277VAC
- Certification: cULus Fixture manufactured to UL Standards 1598 & 8750



35K - 35K

f 1SL - SINGLE SWITCH LEG

BCW6 - 6IN - SC GOOSENECK BALLAST BOX

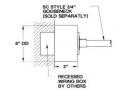

FINISH: ... White

GN24D - 24" STYLE D GOOSENECK

FINISH: ... White





Submitted By LIGHTING SYSTEMS OF COLUMBUS Catalog Number

SN518-G1/LBA01-1-4000-35K-1SLBCW6-G1/GN24D/SCDC-G1

VERIFY ARM TYPE/FITURE FINISH, MOUNTING FINISH

**SN518** 

Custom Build

PROJECT: COMPANY: PREPARED BY: BUILD DATE: 10/09/2020

**SCDCF - SCDCF CANOPY** 



FINISH:

White

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Submitted By LIGHTING SYSTEMS OF COLUMBUS

Catalog Number

SN518-G1/LBA01-1-4000-35K-1SLBCW6-G1/GN24D/SCDC-G1

Notes

VERIFY ARM TYPE/FITURE FINISH, MOUNTING FINISH

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**SN518** 

Custom Build

PROJECT: COMPANY:

PREPARED BY: BUILD DATE: 10/09/2020

LBAC1-1-4000-XXK - LBAC1 - SINGLE MODULE, 4000LM, 36W


- LED: 1 x Cree CMA2550 COB
  - Lumen: 4000(36W)
  - o **Kelvin:** 27, 30, 35, 40, 50K Standard
  - o **CRI**: 90CRI
- Driver: ERP PSB Series, 120/277V, 0-10V Dimming down to 1%
  - o *Dimming:* 0-10V, 1%
  - o *Voltage:* 120 277VAC
- Certification: cULus Fixture manufactured to UL Standards 1598 & 8750



35K - 35K

f 1SL - SINGLE SWITCH LEG

BCW6 - 6IN - SC GOOSENECK BALLAST BOX

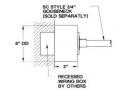

FINISH: ... White

GN24D - 24" STYLE D GOOSENECK

FINISH: ... White





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VERIFY ARM TYPE/FITURE FINISH, MOUNTING FINISH

**SN518** 

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FINISH:

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