



PLANNING AND ZONING COMMISSION (P&Z) FINAL DEVELOPMENT PLAN APPLICATION

ALL ITEMS ON THIS APPLICATION MUST BE COMPLETED.

**Application Fee: \$700.00 + \$100.00 per acre
Per Fee Ordinance 2018-48**

Applicant: _____

Address/City/State/Zip: _____

Email Address: _____

Phone No: _____ Cell Phone No: _____ Fax No: _____

Property Owner: _____

Address/City/State/Zip: _____

Email Address: _____

Phone No: _____ Cell Phone No: _____ Fax No: _____

Architect/Designer for Applicant: _____

Address/City/State/Zip: _____

Email Address: _____

Phone No: _____ Cell Phone No: _____ Fax No: _____

Property Address: _____

Lot Number/Subdivision: _____ Existing Use: _____ Proposed Use: _____

Reason for Administrative Review (attach necessary documents):

Checklist:

- ☐ Preliminary Plan requirements set forth in Section [1143.11\(c\)](#) and Final Plan requirements set forth in Section [1143.11\(i\)](#).
- ☐ Provide any other information that may be useful to the Planning and Zoning Commission or City Staff in the space below or attach additional pages.
- ☐ **5 copies** of all drawings, text, any other items, and application.
- ☐ **1 digital copy** (CD, USB, Email) of the complete application packet.
- ☐ Attach the required fee - \$700.00 + \$100.00 per acre.
- ☐ Post a public notice sign at least (10) days prior to a public hearing or public meeting, pursuant to ordinance 1107.035

Public notice sign details found [here](#).

(See Over)

**APPROVAL SHALL EXPIRE AND MAY BE REVOKED IF CONSTRUCTION DOES NOT BEGIN
WITHIN TWO (2) YEARS FROM THE DATE OF ISSUANCE OF APPROVAL.**

I agree to grant the City Staff, the Commission, Board or Council considering this application access to the property that is the subject of this application for the purposes of reviewing this application and posting public notice for this application.

Signature of Applicant:  Date: September 20, 2019

Office Use
Received

Office Use	
Type/Date:	_____
Base Fee:	_____ \$700.00
Per Acre:	_____ \$100.00X () =
Total:	_____
Prepared by:	_____
Reviewed by:	_____
PAYOR:	_____
RECIEPT #	_____

City of Powell · 47 Hall Street · Powell, Ohio 43065 · (614) 885-5380 · (614) 885-5339 fax· www.cityofpowell.us

FINAL DEVELOPMENT PLAN SUBMITTAL

POWELL OFFICES

8930 Liberty Rd. Powell, Ohio 43065



LANDOWNER:

Milton Properties, LLC

8930 Liberty Road, Powel, Ohio 43065

PREPARED BY:

Equity, Inc.

4653 Trueman Blvd, Suite 100, Hilliard, Ohio 43026

Andy Johanni, Senior Vice President

The Mannik & Smith Group, Inc.

1160 Dublin Rd., Suite 100, Columbus, OH 43215

Steve Fox, PE, CPESC – Project Manager

POD Design

100 Northwoods Blvd., Suite A, Columbus, OH 43235

Todd Foley - Principal

JCKL Architects & Designers, LLC

P.O. Box 340037, Columbus, Ohio 43234

Thomas W. Coffey, Architect

equity

ecs
equity construction solutions®

Sketch Plan Meeting: 12/12/2018
Preliminary Development Plan Meeting: 9/11/2019
Final Development Plan Meeting: 10/09/2019
Powell City Council Meeting: 12/03/2019

PROPOSED DEVELOPMENT: AN OFFICE CONDOMINIUM DEVELOPMENT WITH A DAY-CARE FACILITY AN ASSOCIATED PARKING ON 4.44 ACRES AT THE SOUTHWEST CORNER OF LIBERTY RD AND SELDOM SEEN RD. DETENTION AND WATER QUALITY IS PROVIDED BY A WET BASIN THAT DISCHARGES TO AN EXISTING STORM SEWER FOR THE WOLFE COMMERCE PARK DRAINAGE SYSTEM.

ALL BENCHMARKS AND ELEVATIONS SHOWN ON THIS PLAN ARE BASED ON THE (NAVD 88) NORTH AMERICAN VERTICAL DATUM OF 1988, AND WAS ESTABLISHED BY GPS OBSERVATIONS AND OBSERVATIONS OF SELECTED STATIONS IN THE OHIO DEPARTMENT OF TRANSPORTATION VIRTUAL REFERENCE STATION NETWORK.

BENCHMARK #1
WEST RIM OF SANITARY MANHOLE #4, LOCATED 48' NORTH OF SOUTH PROPERTY LINE & 7' WEST OF
LIBERTY ROAD RIGHT-OF-WAY LINE.

ELEVATION=933.20

THESE MATERIALS ARE GOVERNED BY THE CITY OF COLUMBUS CONSTRUCTION AND MATERIALS SPECIFICATIONS

NOTE:
THE QUANTITIES LISTED HAVE BEEN ESTABLISHED AS A MEANS FOR THE ENGINEER TO
ESTIMATE A PRELIMINARY COST AND MAY NOT BE COMPLETE. THE CONTRACTOR SHALL
BE SOLELY RESPONSIBLE FOR DETERMINING THE REQUIRED BID QUANTITIES NECESSARY
FOR THE COMPLETION OF THE PLAN IMPROVEMENTS.

STORM SEWERS
CITY OF POWELL
47 HALL STREET
POWELL, OHIO 43065
CONTACT: (614) 885-5380

GAS COMPANY
COLUMBIA GAS OF OHIO
920 W. GOODALE BLVD.
COLUMBUS, OHIO 43212
CONTACT: (800) 440-6111

WATER SERVICE
DEL-CO WATER CO., INC.
6658 OLENTANGY RIVER ROAD
DELAWARE, OHIO 43015
CONTACT: RUSTY GRIFFITH
(740) 548-7746

ELECTRIC COMPANY
AMERICAN ELECTRIC POWER
850 TECH CENTER DRIVE
GAHANNA, OHIO 43230-6605
CONTACT: (888) 710-4237

CABLE SERVICES
TIME WARNER CABLE
156 JOHNSON DRIVE
DELAWARE, OHIO 43015
CONTACT: (740) 481-5262

TELEPHONE SERVICE
AT&T
150 E. GAY STREET, ROOM 7B
COLUMBUS, OHIO 43215
CONTACT: (614) 223-4784

SANITARY SEWERS
DELAWARE COUNTY SANITARY ENGINEER
50 CHANNING STREET
DELAWARE, OH 43015
CONTACT: (740) 833-2240

THE STANDARD CONSTRUCTION DRAWINGS LISTED ON THESE PLANS SHALL BE CONSIDERED A PART THEREOF:

QTY OF COLUMBUS	DEL-CO WATER	DEL-COUNTY REGIONAL SANITARY
AA-S102	AA-S133B	
AA-S106	AA-S141	D-1
AA-S106	AA-S149	D-2
AA-S107	AA-S150	D-4
AA-S117	AA-S151	D-5
AA-S119	AA-S169	D-7
AA-S133A		D-10

The map shows a network of roads and geographical features. Home Road runs horizontally at the top. Stitz Road runs vertically, intersecting Home Road at a junction marked with a '124' in a circle. Below Home Road is Rutherford Road T-122, and below that is Seldom Seen Road T-121. W. Powell Road runs horizontally at the bottom. Liberty Road runs vertically, intersecting Rutherford Road and Seldom Seen Road. A road branching off Liberty Road to the east is marked with a '916' in a circle. A road branching off Seldom Seen Road to the west is marked with a '257' in a circle. The O'Shaughnessy Reservoir Dam is located on the western side of the map, near the 257 highway. Summit Peak is located to the east of the Site. A north arrow is located in the bottom right corner of the map.

LOCATION MAP
NOT TO SCALE

EQUITY CONSTRUCTION SOLUTIONS
4653 TRUAMAN BLVD., SUITE 100
HILLIARD, OHIO 43026
CONTACT: SHAWN BOYSKO
PHONE: 614-334-7862
EMAIL: SBOYSKO@ECSBUILDS.COM


MILTON PROPERTIES LLC
8930 LIBERTY ROAD
POWELL, OHIO 43065

ENGINEER
THE MANNIK & SMITH GROUP, INC.
1160 DUBLIN ROAD, SUITE 100
COLUMBUS, OHIO 43215
CONTACT: STEVEN E. FOX, PE
PHONE: 614-452-4628
EMAIL: SFOX@MANNIKSMITHGROUP.COM

TITLE SHEET.....	1
GENERAL NOTES.....	2
MISCELLANEOUS DETAILS.....	3-4
EXISTING CONDITIONS AND DEMOLITION PLAN.....	5
SITE PLAN.....	6
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STRIPING PLAN.....	14
SURVEY.....	15

SIGNATURES BELOW SIGNIFY ONLY CONCURRENCE WITH THE GENERAL PURPOSES AND GENERAL LOCATION OF THE PROJECT. ALL TECHNICAL DETAILS REMAIN THE RESPONSIBILITY OF THE ENGINEER PREPARING THE PLANS.

MAYOR, CITY OF POWELL	DATE
CITY ENGINEER, CITY OF POWELL	DATE
DEVELOPMENT DIRECTOR, CITY OF POWELL	DATE
LIBERTY TOWNSHIP FIRE DEPT.	DATE
DEPUTY GENERAL MANAGER, DEL-CO WATER COMPANY	DATE

1 / 15	TITLE SHEET	SITE IMPROVEMENT PLAN POWELL OFFICE CONDOMINIUMS	8930 LIBERTY ROAD POWELL, OHIO 43065	PREPARED FOR: EQUITY CONSTRUCTION SOLUTIONS 4653 TRUEJAN BLVD., SUITE 100 HILJARD, OH 43026	 TECHNICAL SKILL, CREATIVE SPIRIT. www.manniksmithgroup.com	1160 DUBUN ROAD SUITE 100 COLUMBUS, OH 43215 TEL: 614.41.4222 FAX: 888.488.7240	NO.	DATE	BY	DESCRIPTION
										PROJECT DATE: 10/04/19 PROJECT NO: E120022 DRAWN BY: MS CHECKED BY: SEF



ENGINEER

CONTACT: STEVEN E. FOX, JR., P.E.
MAILING ADDRESS: 1160 DUBLIN ROAD, SUITE 100
COLUMBUS, OH 43215
PHONE: (614) 441-4222
EMAIL ADDRESS: SFOX@MANNIKSMITHGROUP.COM



STEVEN E. FOX, JR. E-70756
OHIO REGISTERED PROFESSIONAL ENGINEER

10/4/2019

DATE

THE CONTRACTOR SHALL PERFORM FIELD RECONNAISSANCE TO BECOME ACQUAINTED WITH THE EXISTING SITE CONDITIONS AND THE POTENTIAL AFFECTS UPON THE WORK SCOPE. ANY PERFORMANCE OF ADDITIONAL SITE SUBSURFACE INVESTIGATIONS (TEST HOLES) SHALL BE COORDINATED IN ADVANCE WITH THE

ALL TRAFFIC CONTROL DEVICES SHALL BE FURNISHED, ERECTED, MAINTAINED AND REMOVED BY THE CONTRACTOR IN ACCORDANCE WITH THE OHIO MANUAL OF UNIFORM TRAFFIC CONTROL DEVICES FOR CONSTRUCTION AND MAINTENANCE OPERATIONS (CURRENT EDITION) COPIES OF WHICH ARE AVAILABLE FROM THE

ALL STORM WATER SEWERS WITHIN PUBLIC RIGHT OF WAY SHALL BE
CONSTRUCTED IN ACCORDANCE WITH THE SPECIFICATIONS OF THE CITY OF
POWELL AND SHALL FOLLOW CITY OF COLUMBUS CONSTRUCTION AND MATERIAL

3. WATER LINE CONSTRUCTION:

A. WATER LINES SHALL BE NSF 61 APPROVED, AND COMPLIANT WITH ASTM D2241 & OHIO EPA ENG-08-001 STANDARDS.

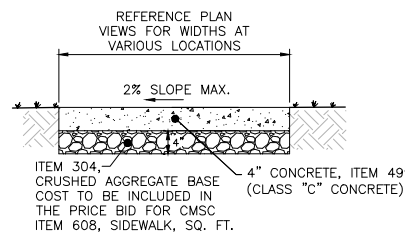
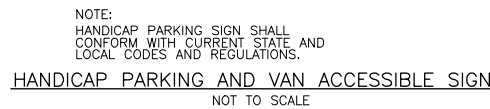
B. USE THE FOLLOWING TYPE AND CLASS OF PIPE UNLESS OTHERWISE INDICATED ON THE DRAWINGS:

F. ALL PIPE INSTALLATION AND PRESSURE TESTING SHALL BE IN ACCORDANCE WITH AWWA C600 FOR DUCTILE IRON PIPE AND C605 FOR PLASTIC PIPE, AND DEL-CO SPECIFICATIONS.

6. ALL WATER MAINS, INCLUDING THOSE NOT DESIGNED TO PROVIDE FIRE PROTECTION, SHALL BE SIZED FOLLOWING AN ANALYSIS BASED ON FLOW DEMANDS, AND PRESSURE REQUIREMENTS. THE SYSTEM SHALL BE DESIGNED TO MAINTAIN A MINIMUM PRESSURE OF 20 PSI AT GROUND LEVEL AT ALL POINTS IN THE DISTRIBUTION SYSTEM UNDER ALL DESIGNED FLOW CONDITIONS. NORMAL WORKING PRESSURE IN THE DISTRIBUTION SYSTEM SHALL NOT BE LESS THAN 35 PSI.


NO CONNECTION SHALL BE MADE TO THE RECEIVING SANITARY SEWER SYSTEM UNTIL THIS PROJECT HAS BEEN FULLY INSTALLED, TESTED AND APPROVED.

2	GENERAL NOTES	SITE IMPROVEMENT PLAN	EQUITY CONSTRUCTION SOLUTIONS 4653 TRUJMAN BLVD., SUITE 100 HILARIO, OH 43026
15		8930 LIBERTY ROAD POWELL, OHIO 43065	




ALL WORK SHALL BE DONE IN ACCORDANCE WITH CMS ITEM 608.

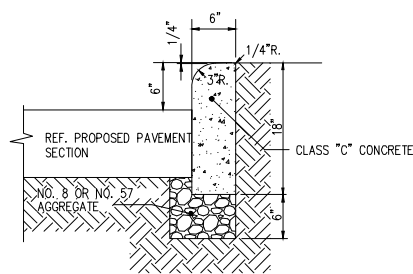
SIDEWALK JOINTS (PRICE SHALL BE INCLUDED W/ITEM 608)
SHALL BE IN ACCORDANCE WITH CMS ITEM 608.03 UNLESS
OTHERWISE DETAILED AS A PART OF THE ARCHITECTURAL PLANS.




STRAIGHT 18" CONCRETE CURB
NOT TO SCALE

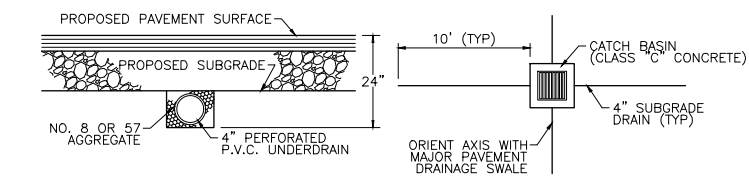

SUBGRADE DRAIN DETAIL
NOT TO SCALE

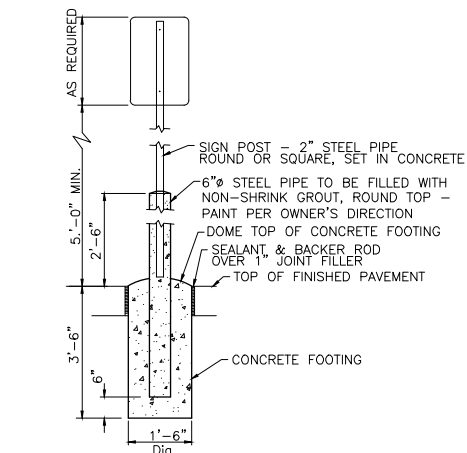


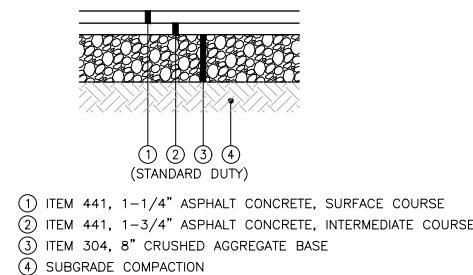TYPICAL SIGN POST IN PAVEMENT
NOT TO SCALE



ALL PAVEMENT MATERIALS SHALL CONFORM TO THE CITY OF COLUMBUS CONSTRUCTION AND MATERIAL SPECIFICATIONS TOGETHER WITH THE STATE OF OHIO, DEPARTMENT OF TRANSPORTATION CONSTRUCTION AND MATERIAL SPECIFICATIONS.

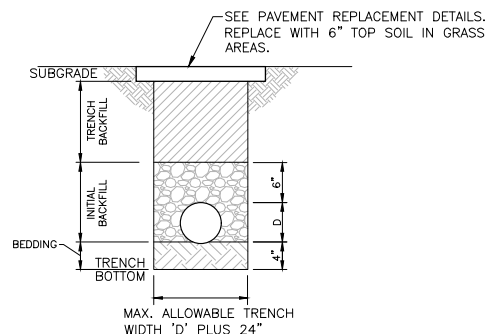
PAVEMENT SECTIONS PROVIDED FOR REFERENCE ONLY. CONTRACTOR SHALL VERIFY SECTION THICKNESS TO BE USED WITH OWNER. THE MANNIK & SMITH GROUP DOES NOT WARRANT PAVEMENT DESIGN.



NOTES

1. SUITABLE BEDDING AND INITIAL BACKFILL MATERIAL SHALL CONSIST OF NATURALLY OCCURRING SAND OR CLAY FREE FROM TRASH, ROOTS, DEBRIS, EXCESSIVE MOISTURE AND OBJECTS LARGER THAN 3".
2. PIPE TRENCH WALL SHALL BE VERTICAL TO THE TOP OF THE INITIAL BACKFILL.
3. PROVIDE SELECT FILL No. 8 OR No. 57 STONE FOR BEDDING MATERIAL TO THE DEPTH REQUIRED BY THE WATER UTILITY WHEN UNSTABLE TRENCH BOTTOMS ARE ENCOUNTERED, AS DETERMINED BY THE WATER UTILITY.
4. MANUALLY COMPACT EMBEDMENT MATERIAL FILLING ALL VOIDS AROUND PIPE.
5. TRENCH BACKFILL TYPE SHALL BE PER GENERAL NOTES AND SPECIFICATIONS.

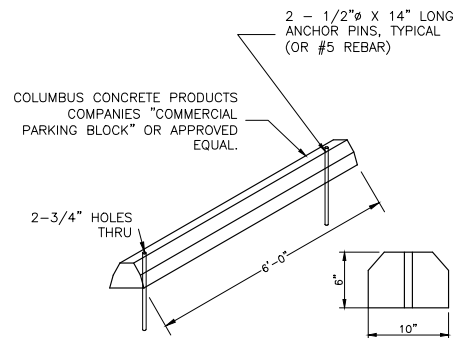WATER LINE EMBEDMENT
NOT TO SCALE
12-01-04



PARKING BLOCK DETAIL
NOT TO SCALE

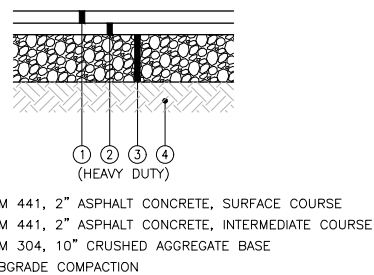


Diagram illustrating a cross-section of a proposed pavement section, showing a concrete curb and base structure.

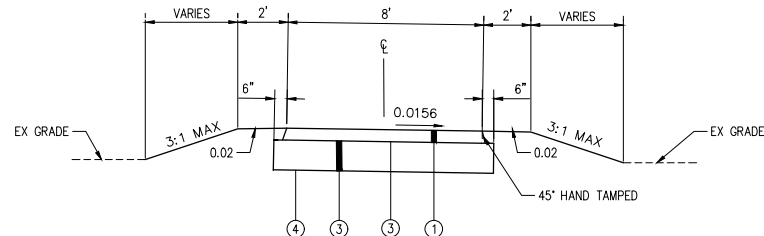
Labels and Dimensions:

- BROOM FINISH:** Indicated on the top surface of the concrete curb.
- REFERENCE PLAN VIEWS FOR WIDTHS AT VARIOUS LOCATIONS:** Indicated by a horizontal dimension line.
- 6"**: Dimension for the width of the curb top.
- 1/2" DEEP CONTRACTION JOINT:** Indicated by a vertical line on the curb face.
- SLOPE:** Indicated by a dashed line on the base.
- SEE GRADING PLAN:** Indicated by a horizontal dimension line.
- PROPOSED PAVEMENT SECTION:** Indicated by a vertical dimension line.
- 18"**: Total height of the proposed pavement section.
- COMPACTED GRANULAR FILL:** Indicated by a layer of small circles below the concrete curb.
- CLASS "COC6" CONCRETE PER CMSC ITEM 499:** Indicated by a layer of larger circles below the granular fill.

NOTE: SEE ARCHITECT'S PLAN FOR SIDEWALK JOINT DETAILS AND LOCATIONS.


NOTE: SIDEWALK JOINTS SHALL BE IN ACCORDANCE WITH CMSC ITEM 608.03 UNLESS OTHERWISE DETAILED AS A PART OF THE BUILDING OR LANDSCAPE ARCHITECT PLANS.

FLUSH COMBINED CURB AND WALK
NOT TO SCALE



- ① ITEM 448, 2" ASPHALT CONCRETE, SURFACE COURSE, TYPE 1, PG64-22
- ② ITEM 306, 6" AGGREGATE BASE
- ③ ITEM 408 - BITUMINOUS PRIME COAT (0.25 GAL/SY)
- ④ ITEM 204 - SUBGRADE COMPACTION

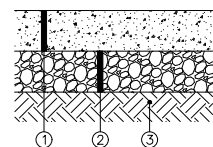BIKE PATH SECTION
NOT TO SCALE




- ① ITEM 452, 8" PLAIN PORTLAND CEMENT CONCRETE PAVEMENT
- ② ITEM 304, 8" AGGREGATE BASE
- ③ SUBGRADE COMPACTION, REF. SOILS REPORT


NOTE:

CONCRETE PAVING, CMSC ITEM 452 SHALL CONFORM TO THE FOLLOWING SPECIFICATIONS:

1. 4000 PSI COMPRESSIVE STRENGTH, 600 PSI FLEXURAL STRENGTH.
2. 5-7% ENTRAINED AIR WITH APPROVED WATER-REDUCING AND RETARDING ADMIXTURES.
3. CONSTRUCTION JOINTS SHALL BE SPECIFIED BY CONTRACTOR AS A PART OF THE CONTRACT BID.
4. CONCRETE PAVING SHALL HAVE A LIGHT BROOM FINISH.
5. CURING COMPOUND SHALL BE APPLIED AS PER CMSC ITEM 451.10.

CONCRETE DUMPSTER PAD SECTION
NOT TO SCALE

3	MISCELLANEOUS DETAILS	SITE IMPROVEMENT PLAN POWELL OFFICE CONDOMINIUMS	PREPARED FOR: EQUITY CONSTRUCTION SOLUTIONS 4653 TRULEMAN BLVD., SUITE 100 HULLARD, OH 43065	 TECHNICAL SKILL - QUALITY SERVICE www.manniksmithgroup.com	1160 DUBJIN ROAD, SUITE 100 COLUMBUS, OH 43215 TEL: 614.441.4222 FAX: 688.488.7340	NO.	DATE	BY	DESCRIPTION
15						PROJECT DATE:	10/04/19		
						PROJECT NO:	E120022		
						DRAWN BY:	MS		
						CHECKED BY:	SEF		

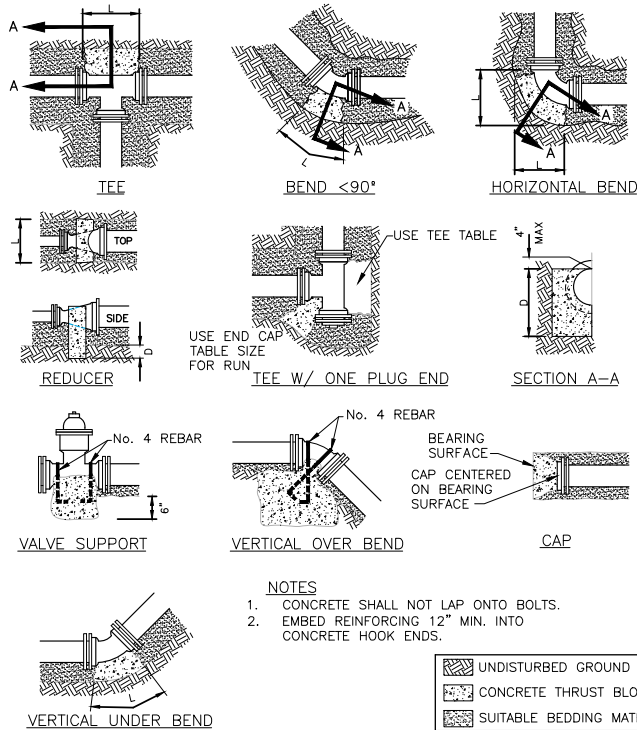

END CAP BLOCKING						
SIZE	2"	4"	6"	8"	12"	16"
BLOCKING AREA	6"x6"	9"x9"	13"x13"	17"x17"	24"x24"	33"x33"


BLOCKING FOR TEES												
R U N	BRANCH											
	4"			6"			8"			12"		
	L"	D"	Vc.f.	L"	D"	Vc.f.	L"	D"	Vc.f.	L"	D"	Vc.f.
4"	11	8	0.8									
6"	11	8	0.8	18	12	1.9						
8"	10	9	0.7	18	12	1.9	23	16	3.5			
12"	8	12	0.8	18	12	1.9	23	16	3.5	38	22	8.7
16"	6	16	0.8	14	16	2.0	20	18	3.5	38	23	8.7
										49	30	13.6

SIZE OF CONCRETE BLOCKING FOR VERTICAL OVERBEND		
PIPE SIZE	SIZE OF BLOCK	VOLUME Cu. Yd.
4"	1.5'x1.5'x1.5'	0.13
6"	2.5'x2.5'x2.5'	0.5
8"	3'x3'x3'	1
12"	3.5'x3.5'x3.5'	1.5
16"	4.5'x4.5'x4.5'	3.5




BLOCKING FOR REDUCERS											
PIPE SIZE	4"		6"		8"		12"		16"		
	D"	L"	D"	L"	D"	L"	D"	L"	D"	L"	L"
2"	12	6	12	12							
4"			12	12							
6"					12	12					
8"							24	18			
12"									24	24	

BLOCKING FOR HORIZONTAL BENDS AND VERTICAL UNDERBEND												
PIPE SIZE	DEGREE OF BEND											
	11.25°			22.5°			45°			90°		
	L"	D"	Vc.f.	L"	D"	Vc.f.	L"	D"	Vc.f.	L"	D"	Vc.f.
4"	5	4	0.2	9	5	0.4	14	5	0.6	14	5	0.6
6"	8	6	0.5	12	7	0.7	20	8	1.4	9	1.7	
8"	9	8	0.7	16	9	1.4	24	12	2.7	25	11	4
12"	14	12	1.8	24	14	3.6	36	18	6.8	32	18	10.7
16"	18	16	3.4	32	18	6.7	36	32	13.4	41	26	25.6

VALVE SUPPORTS		
VALVE SIZE	WIDTH	Vc.f.
4"	16"	0.3
6"	17"	0.4
8"	20"	0.4
12"	24"	0.5
16"	30"	0.5

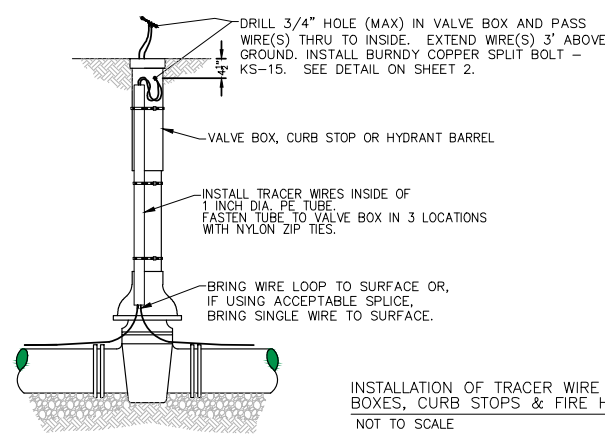

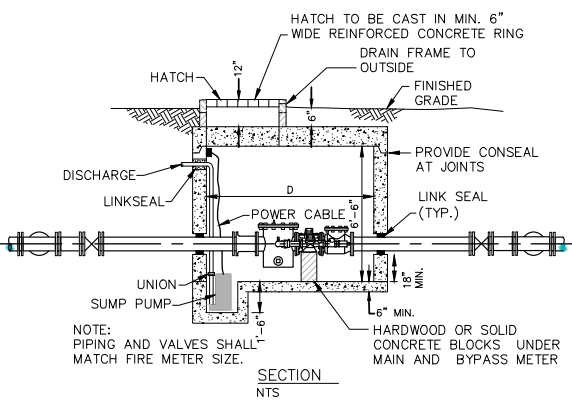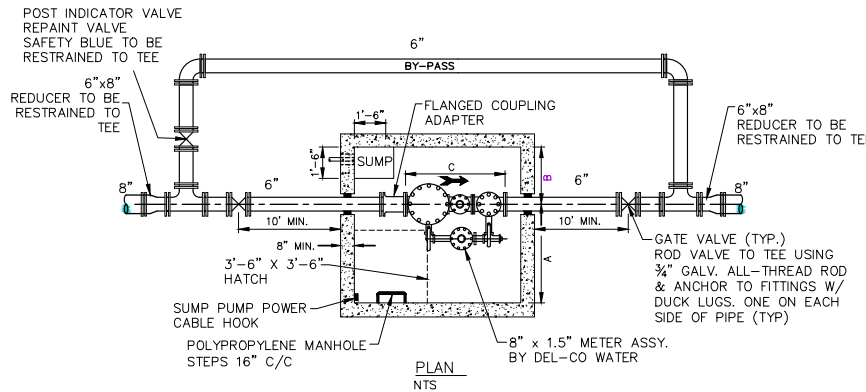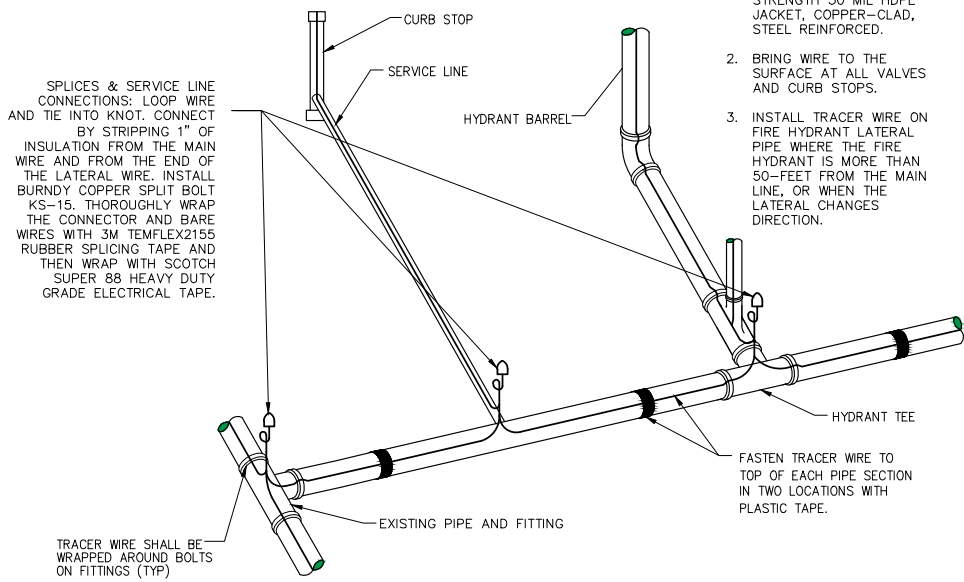
- NOTES:**
- TRACER WIRE SHALL BE 12-GAUGE HIGH STRENGTH 30 MIL HDPE JACKET, COPPER-CLAD, STEEL REINFORCED.
 - BRING WIRE TO THE SURFACE AT ALL VALVES AND CURB STOPS.
 - INSTALL TRACER WIRE ON FIRE HYDRANT LATERAL PIPE WHERE THE FIRE HYDRANT IS MORE THAN 50- FEET FROM THE MAIN LINE, OR WHEN THE LATERAL CHANGES DIRECTION.



- NOTES:**
- PROVIDE ALL EQUIPMENT AND MATERIALS EXCEPT METER. DEL-CO WATER WILL FURNISH METER AT DEL-CO'S OFFICE. CONTRACTOR SHALL TRANSPORT THE METER TO THE SITE AND INSTALL IT.
 - PROVIDE ZOLLER MODEL M53 SUMP PUMP WITH FLOAT SWITCH LEVEL CONTROL. PROVIDE POWER CABLE OF SUFFICIENT LENGTH TO EXTEND 3 FEET PAST HATCH, TERMINATE WITH THREE PRONG PLUG, AND SECURE NEAR HATCH WITH COOPER B-LINE FIG B3190-1 STAINLESS STEEL 1" J-HOOK.
 - HATCH SHALL BE 42"x42" ALUMINUM WITH DIAMOND PLATE COVER REINFORCED FOR 300 PSF LIVE LOAD. PROVIDE CAST ALUMINUM FLUSH LIFTING HANDLE AND PADLOCK HASP AND STAINLESS STEEL HOLD-OPEN ARM. ALL HINGES AND OTHER HARDWARE SHALL BE STAINLESS STEEL. FRAME SHALL BE EXTRUDED ALUMINUM WITH PROTECTIVE COATING ON SURFACES IN CONTACT WITH CONCRETE. U.S.F. FABRICATION INC. MODEL TPS OR EQUAL.
 - VAULT SHALL BE PRE-CAST OR CAST-IN-PLACE CONCRETE DESIGNED TO SUPPORT AN AASHTO H20 LIVE LOAD.
 - SUBMIT SHOP DRAWINGS TO DEL-CO WATER FOR APPROVAL. INCLUDE ALL MATERIALS OF CONSTRUCTION AND PROVIDE STRUCTURAL DESIGN CERTIFICATION BY AN OHIO REGISTERED PROFESSIONAL ENGINEER.


METER SIZE			
SIZE	6"x1 1/2"	8"x2"	10"x2"
A	51"	57"	66"
B	32"	33"	38"
C	45"	53"	68"
D	89"	96"	112"

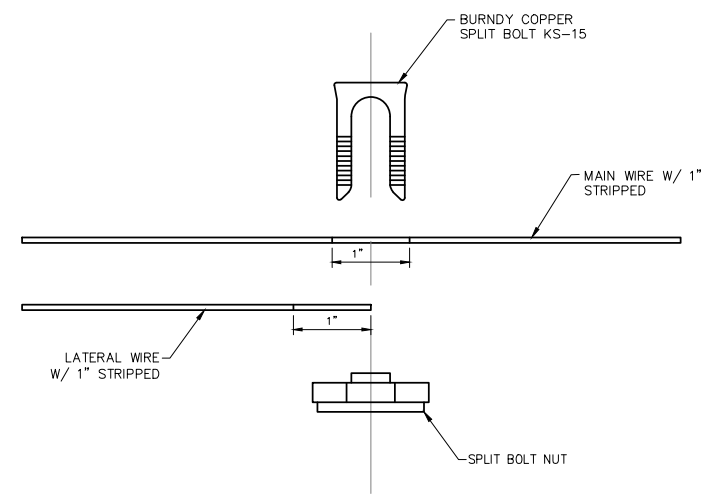MASTER METER VAULT
NOT TO SCALE



DESCRIPTION										
BY										
DATE										
NO.										
1160 DUBIN ROAD SUITE 100 COLUMBUS OH 43215 TEL: 614.441.4222 FAX: 614.482.1040 PROJECT NO: E120022 PROJECT DATE: 10/04/19 DRAWN BY: MS CHECKED BY: SEF										
TECHNICAL SKILL CREATIVE SPIRIT www.manniksmithgroup.com										
PREPARED FOR:	EQUITY CONSTRUCTION SOLUTIONS 4653 TRULIEMAN BLVD., SUITE 100 HILLIARD, OH 43026									
SITE IMPROVEMENT PLAN	POWELL OFFICE CONDOMINIUMS 8930 LIBERTY ROAD POWELL, OHIO 43065									
MISCELLANEOUS DETAILS										
4 / 15										

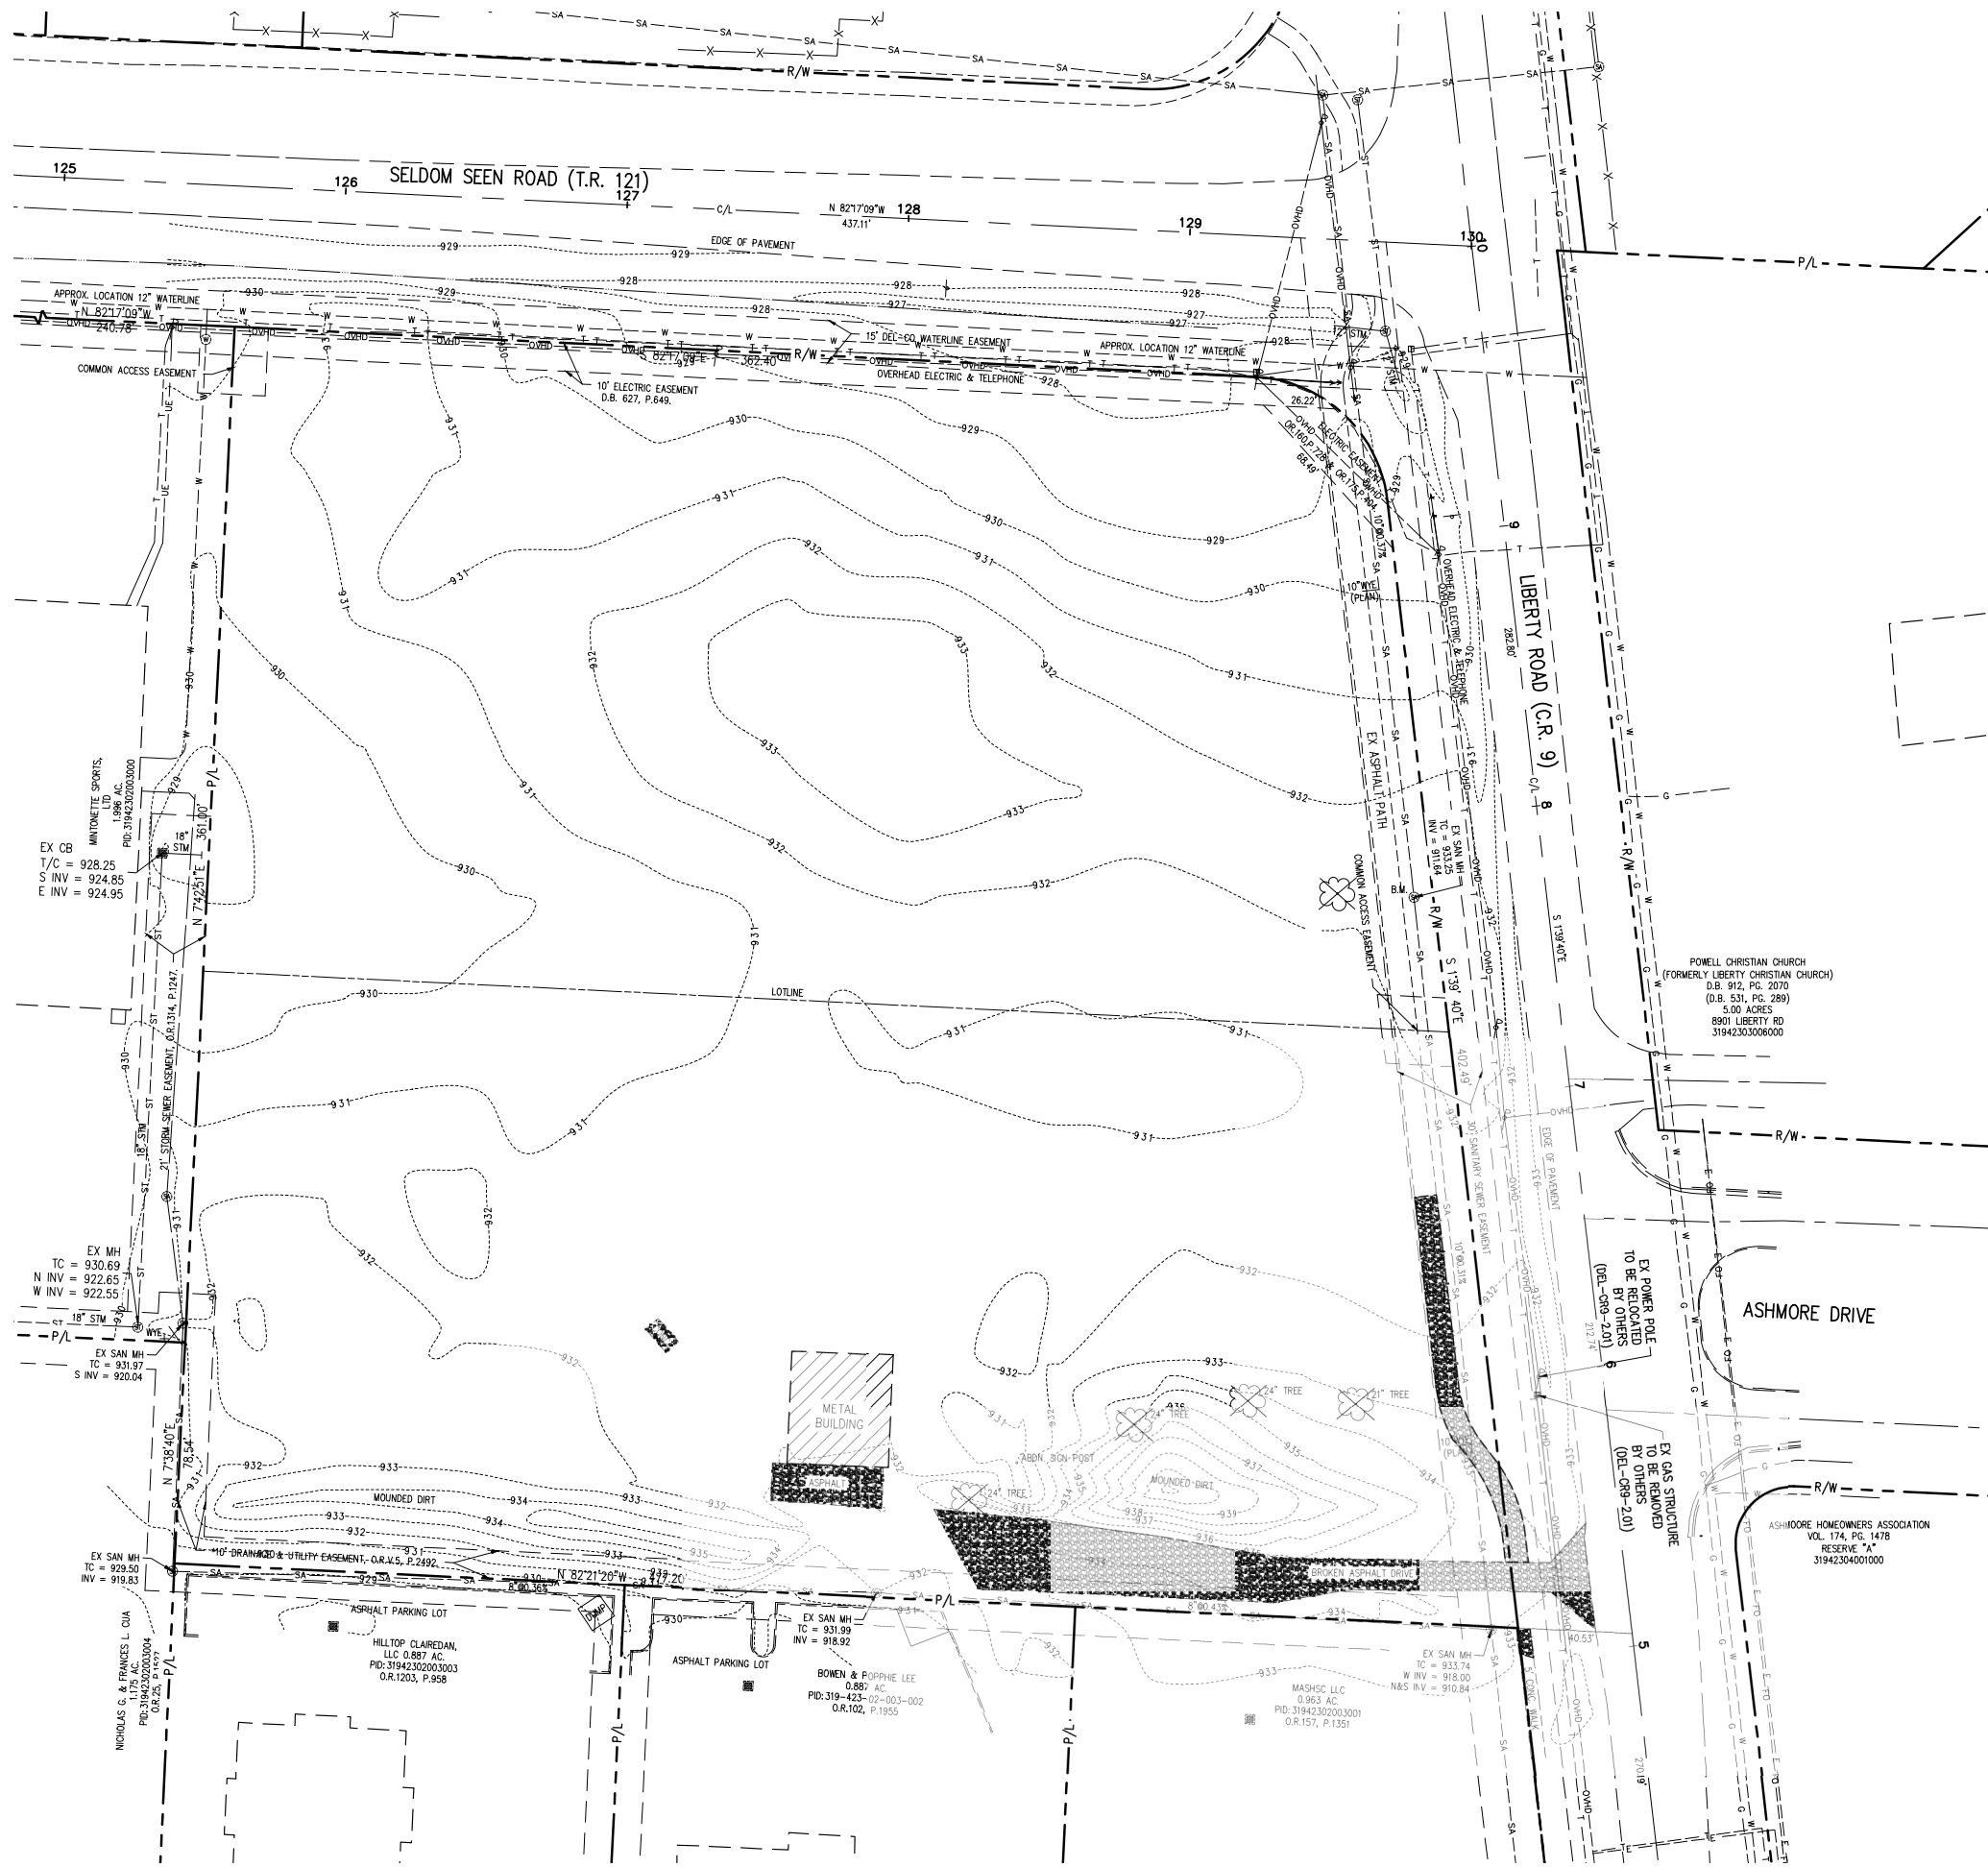L:\Projects\Power Office Condominiums\120022\DEMOLITION\120022.DWG (120022) 11.13 AM by JMS/ah



DEMOLITION NOTES

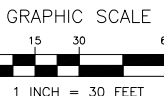
- CONTRACTOR SHALL BE RESPONSIBLE FOR IDENTIFYING, CALCULATING & PRICING HIS OWN QUANTITIES.
- CONTRACTOR TO VERIFY LOCATION AND ELEVATION OF EXISTING UTILITIES PRIOR TO STARTING DEMOLITION OF THE SITE. THE CONTRACTOR SHALL BE RESPONSIBLE FOR PROTECTION AND SUPPORT OF ALL EXISTING UTILITIES DURING CONSTRUCTION. CONTRACTOR SHALL GIVE NOTICE TO THE ENGINEER OF ANY CONFLICTS OR REQUIRED RELOCATIONS NOT SHOWN HEREON.
- CONTRACTOR SHALL MINIMIZE DISRUPTION TO ADJOINING PROPERTIES AND SHALL COMPLETE WORK AS SOON AS PRACTICAL. CONTRACTOR SHALL COORDINATE THE PHASING OF THE PROJECT WITH THE CONSTRUCTION MANAGER AND ADJACENT OWNERS.
- CONSTRUCTION DEBRIS GENERATED FROM DEMOLITION IS NOT CONSIDERED TO BE SUITABLE FOR USE IN ON-SITE FILLS, UNLESS THE DELETERIOUS MATERIALS CAN BE SORTED AND BROKEN DOWN SUFFICIENTLY TO MEET THE REQUIREMENTS OF THE GEOTECHNICAL ENGINEER.
- CONTRACTOR SHALL EXERCISE EXTREME CAUTION WHEN CONDUCTING GRADING ACTIVITIES IN THE VICINITY OF THE EXISTING GAS, UNDERGROUND AND OVERHEAD ELECTRIC, FIBER OPTIC AND TELEPHONE LINES.
- REFERENCE EXISTING BUILDING PLANS FOR DEMOLITION AT EXISTING BUILDING.
- CONTRACTOR SHALL BE RESPONSIBLE FOR APPLYING FOR AND OBTAINING ALL PERMITS ASSOCIATED WITH THE SITE DEMOLITION.
- ARRANGE WITH THE OWNER A CONVENIENT TIME TO PERFORM DEMOLITION WORK AND INSTALL TEMPORARY PROTECTED MEANS OF EGRESS/INGRESS FROM REQUIRED EXITS, INCLUDING TEMPORARY LIGHTING AND SAFETY DEVICES, ALL IN ACCORDANCE WITH GOVERNING STATE AND LOCAL CODE AND LANDLORD REQUIREMENTS.
- TRAFFIC: CONDUCT SITE CLEARING OPERATIONS TO ENSURE MINIMUM INTERFERENCE WITH ROADS, STREETS, WALKS, AND OTHER ADJACENT OCCUPIED OR USED FACILITIES. DO NOT CLOSE OR OBSTRUCT STREETS, WALKS OR OTHER OCCUPIED OR USED FACILITIES WITHOUT PERMISSION FROM AUTHORITIES HAVING JURISDICTION.
- PROTECTION: PROVIDE TEMPORARY FENCES, BARRICADES, COVERINGS, OR OTHER PROTECTION TO PRESERVE EXISTING ITEMS INDICATED TO REMAIN AND TO PREVENT INJURY OR DAMAGE TO PERSONS OR PROPERTY. PROVIDE PROTECTION FOR ADJACENT PROPERTIES AS REQUIRED.
- RESTORE INADVERTENT SITE DAMAGE TO CONDITION EXISTING PRIOR TO START OF WORK.
- STRIP AND STOCKPILE TOPSOIL THAT IS FREE OF CLAY, LARGE STONES AND DEBRIS, FOR REUSE IN GRASSED AND PLANTED AREAS.
- REMOVE EXISTING IMPROVEMENTS, BOTH ABOVE-GRADE AND BELOW-GRADE TO EXTENT INDICATED OR AS OTHERWISE REQUIRED TO PERMIT NEW CONSTRUCTION AS FOLLOWS:
 - REMOVE COMPLETELY ALL EXISTING WALLS, FLOORS, FOOTINGS, PIERS, SLABS, AND OTHER OBSTRUCTIONS WITHIN THE GROUND AREA TO BE OCCUPIED BY NEW BUILDINGS, UTILITY LINES OR EQUIPMENT FOR A DISTANCE OF 5' BEYOND PERIMETER OF NEW BUILDINGS OR WALLS.
 - EXISTING WELLS, CISTERNS OR CATCH BASINS NOT TO BE REUSED, THAT ARE WITHIN 5' OF THE NEW BUILDING WALLS, SHALL BE CLEANED OUT TO SOLID SUB-GRADE, THEN FILLED WITH SAND TO UNDERSIDE OF NEW FOOTING OR FLOOR SLAB. EXISTING BASEMENT FLOORS, CISTERNS OR CESSPOOLS, OUTSIDE OF BUILDING AREA, IF OF MASONRY OR CONCRETE AND TO BE LEFT IN PLACE, SHALL BE CLEANED OF ALL DEBRIS AND BOTTOMS BROKEN UP TO PROVIDE DRAINAGE BEFORE ANY FILL IS PLACED OVER THEM. ALL STORM SEWER PIPES AT ABANDONED CATCH BASINS SHALL BE BULKHEAD PER THE CITY OF COLUMBUS SPECIFICATIONS.
 - IN AREAS TO BE SURFACED OR PLANTED, REMOVE ALL EXISTING WALLS, CURBS, PAVING AND OTHER OBSTRUCTIONS TO DEPTH OF 24" BELOW FINISHED GRADE.
- SALVAGEABLE ITEMS: CAREFULLY REMOVE ITEMS INDICATED TO BE SALVAGED (IF ANY), AND STORE ON OWNER'S PREMISES WHERE INDICATED OR DIRECTED.
- CONTROL AIR POLLUTION CAUSED BY DUST AND DIRT; COMPLY WITH GOVERNING REGULATIONS.
- FILL DEPRESSIONS AND VOIDS RESULTING FROM SITE CLEARING OPERATIONS, USING SATISFACTORY SOIL MATERIALS, PLACED IN MAXIMUM 6 INCH LIFTS. COMPACT EACH LIFT TO DENSITY OF SURROUNDING ORIGINAL GROUND. GRADE BACKFILLED SURFACE TO CONFORM TO PROPOSED SITE CONTOURS AND TO PROVIDE POSITIVE DRAINAGE.
- DISPOSE OF WASTE MATERIALS, INCLUDING TRASH AND DEBRIS, AND EXCESS TOPSOIL, OFF OWNER'S PROPERTY IN A LAWFUL MANNER.
- BURNING OF WASTE MATERIALS ON SITE IS NOT PERMITTED.
- CONTRACTOR IS RESPONSIBLE FOR OBTAINING ALL PERMITS ASSOCIATED WITH SITE DEMOLITION AND MATERIAL DISPOSAL.
- EXISTING UTILITY CONNECTIONS AND TAPS THAT ARE NOT TO BE REUSED ARE TO BE ABANDONED IN ACCORDANCE WITH THE REQUIREMENTS OF THE RESPECTIVE SUPPLIER.

LEGEND


- EX CATCH BASIN
- EX STORM MANHOLE
- EX SANITARY MANHOLE
- EX STORM CURB INLET
- EX STORM
- EX SANITARY
- EX WATER
- EX OVERHEAD ELECTRIC
- EX UNDERGROUND ELECTRIC
- EX GAS
- EX TELEPHONE LINE
- EX TELEPHONE BOX
- EX POWER POLE
- EX WATER METER

DEMOLITION LEGEND

- EX TREE TO BE REMOVED
- EX ASPHALT, CONCRETE PAVEMENT TO BE REMOVED
- EX BUILDING TO BE REMOVED



DESCRIPTION		NO.	DATE	BY
1600 DUBIN ROAD, SUITE 100 COLUMBUS, OH 43215 TEL: 614.441.4222 FAX: 614.441.4240				
PROJECT NO.: E120022 PROJECT DATE: 10/04/19 DRAWN BY: MS CHECKED BY: SEF				
TECHNICAL SKILL CREATIVE SPIRIT				
Mannik Smith GROUP www.manniksmithgroup.com				
PREPARED FOR: EQUITY CONSTRUCTION SOLUTIONS 4653 TRULIEMAN BLVD., SUITE 100 HILLIARD, OH 43005				
SITE IMPROVEMENT PLAN POWELL OFFICE CONDOMINIUMS 8930 LIBERTY ROAD POWELL, OHIO 43065				
EXISTING CONDITIONS AND DEMOLITION PLAN				
5 / 15				

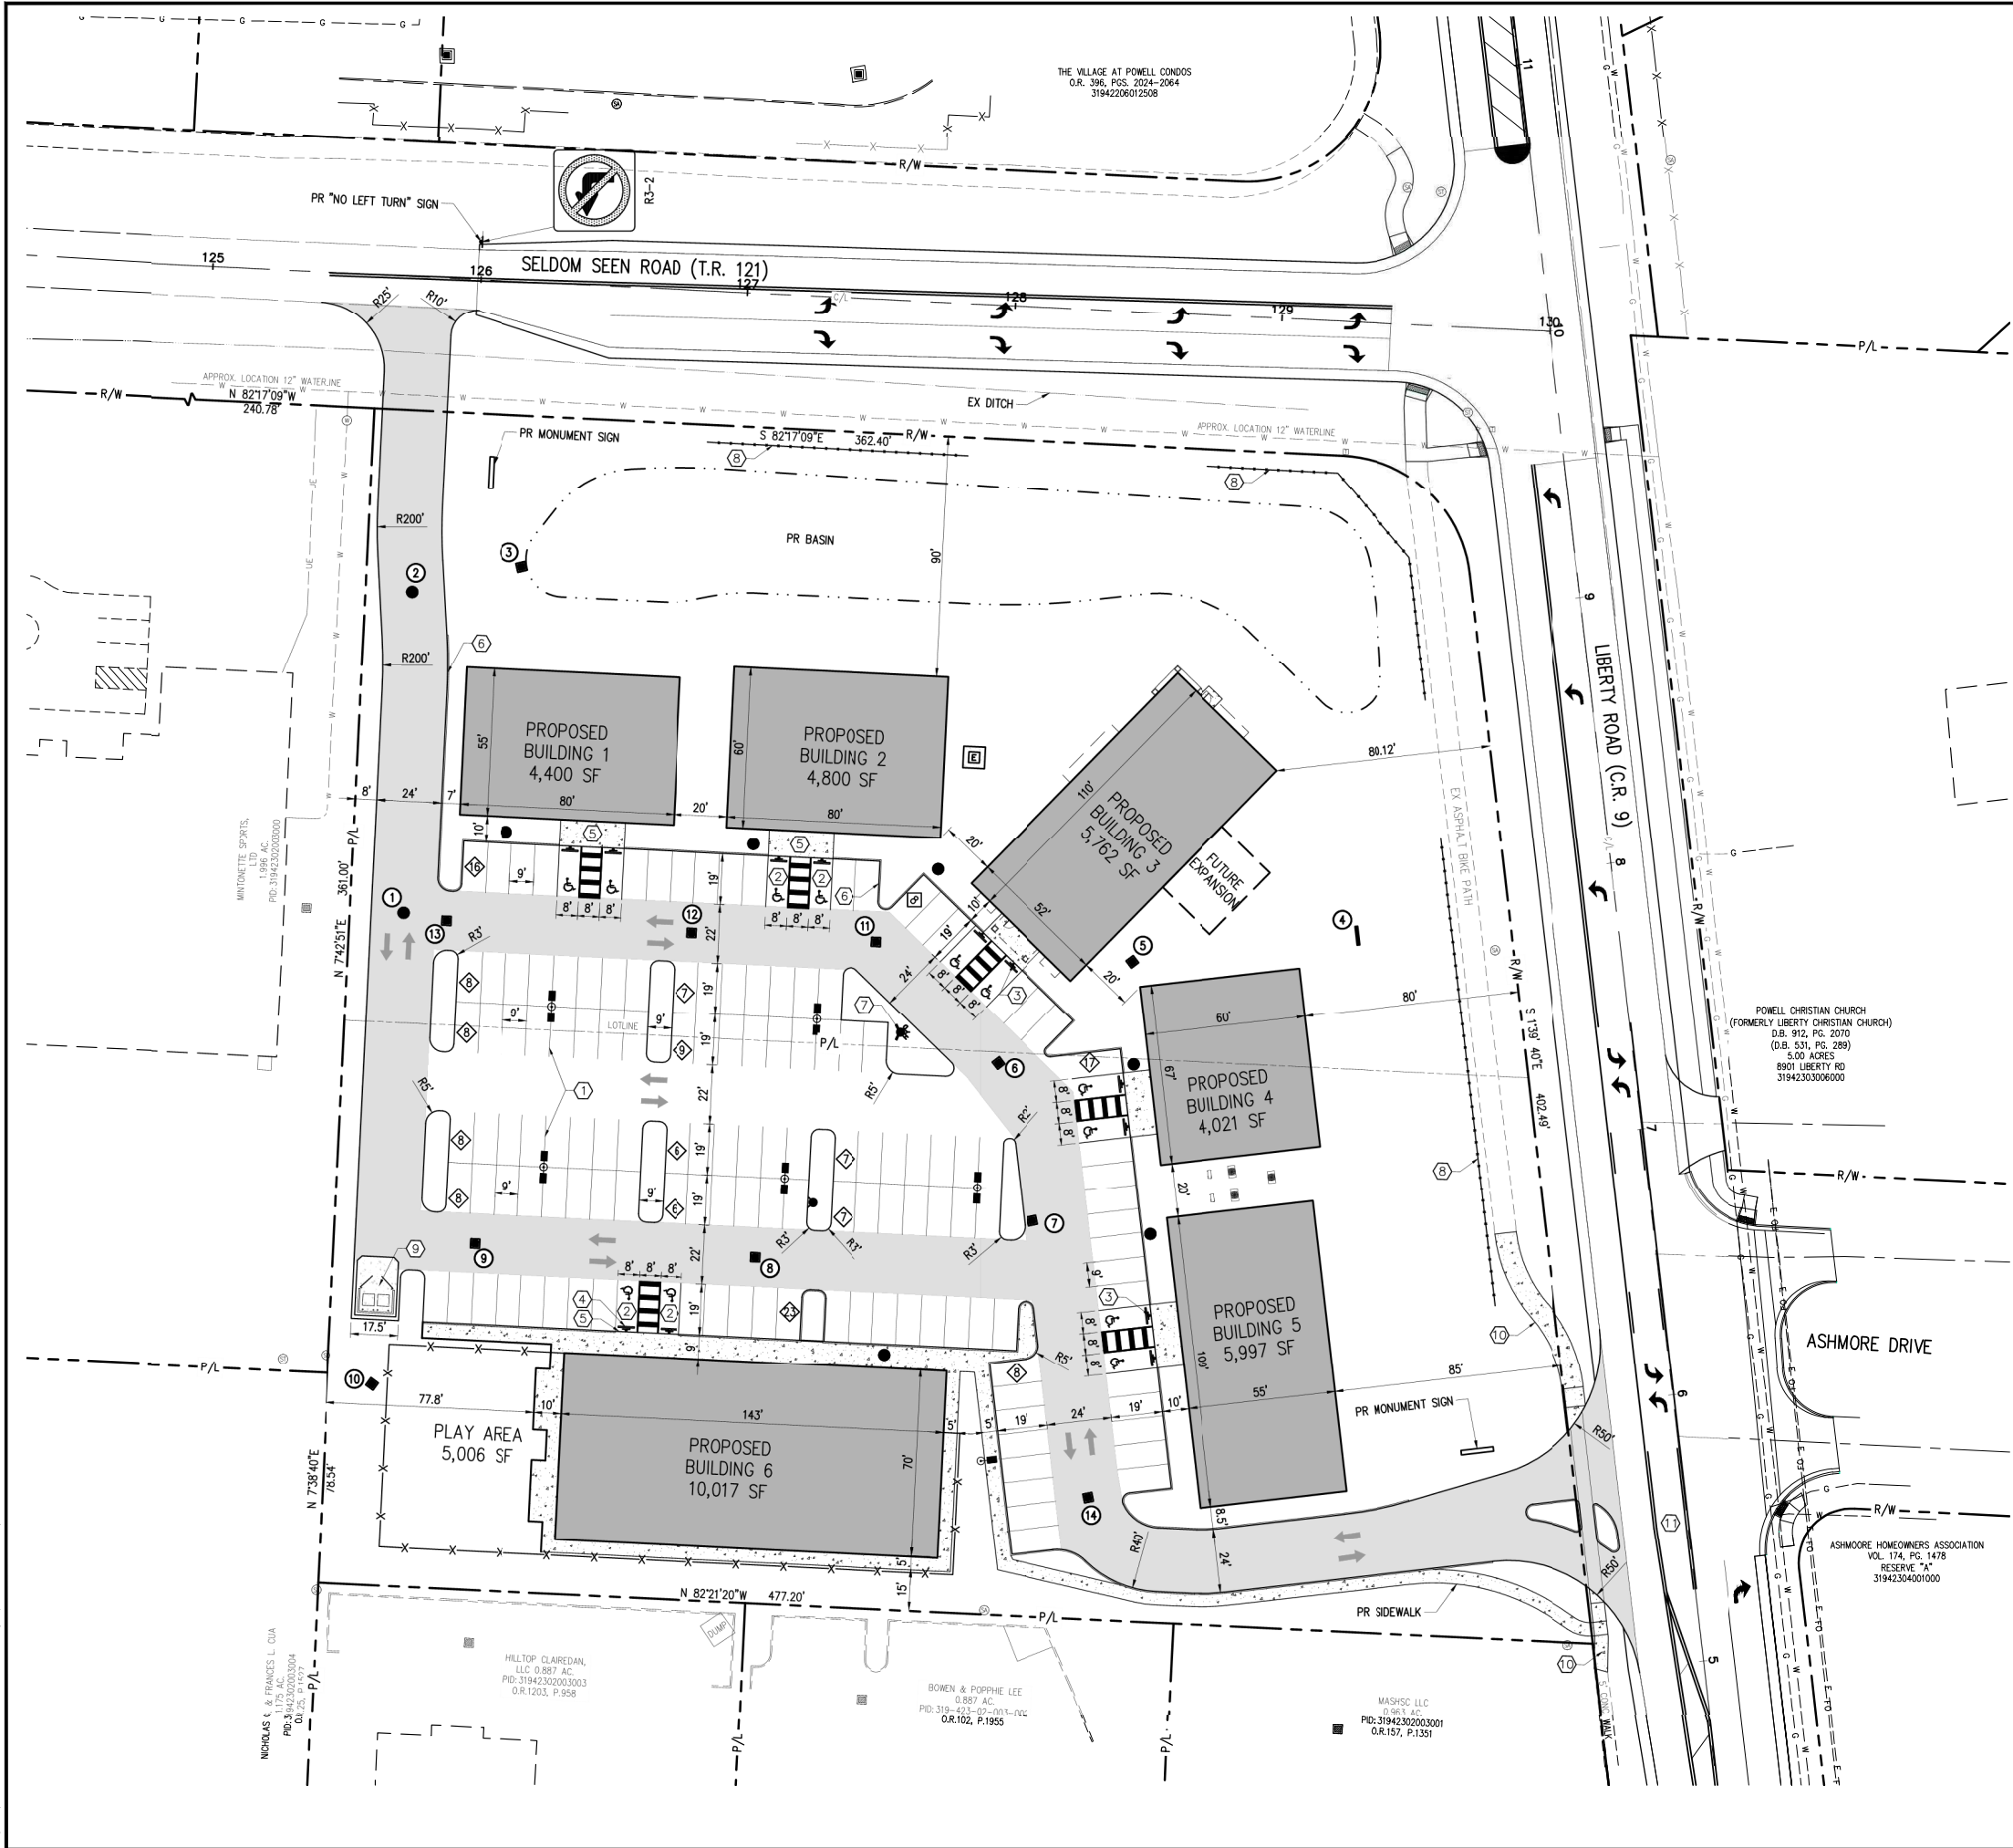

SITE SUMMARY

SITE ADDRESS: 8930 LIBERTY ROAD

SITE AREA: 4.44± ACRES

LOT SIZES: 2.20 AC & 2.20 AC

ZONING: PC-PLANNED COMMERCIAL DISTRICT

PARCEL ID: 31942302003005 & 31942302003006

PARKING: PARKING REQUIRED = 145 SPACES
OFFICE BLDG 1: 4400 SF (1 PER 250 SF) = 18 SPACES
OFFICE BLDG 2: 4800 SF (1 PER 250 SF) = 20 SPACES
OFFICE BLDG 3: 6580 SF (1 PER 250 SF) = 27 SPACES
OFFICE BLDG 4: 4021 SF (1 PER 250 SF) = 16 SPACES
OFFICE BLDG 5: 5997 SF (1 PER 250 SF) = 24 SPACES
OFFICE BLDG 6: 10017 SF (1 PER 250 SF) = 40 SPACES
PARKING PROVIDED = 146 SPACES

FLOOD ZONE: "X", AREAS OUTSIDE 0.2%
500 YEAR FLOOD PLAIN, PANEL NO.: 39041C0212 J (4.21.1999)

DISTURBED AREAS (AC):
GREEN SPACE AREA: 1.74 AC 39%
IMPERVIOUS AREA: 2.70 AC 61%
TOTAL AREA: 4.44 AC 100%

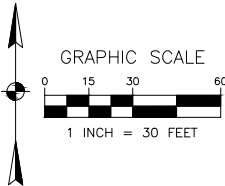
DENSITY: 0.17 UNIT PER ACRE

CODED NOTES

- ① 4" WHITE STRIPING FOR STANDARD PARKING STALLS
- ② ADA ACCESSIBLE PARKING SPACE STRIPING
- ③ HANDICAP PARKING AND VAN ACCESSIBLE SIGN - SEE DETAIL, SHEET 3
- ④ PARKING BLOCK - SEE DETAIL, SHEET 3
- ⑤ WALK FLUSH WITH PAVEMENT - SEE DETAIL, SHEET 3
- ⑥ 18" STRAIGHT CONCRETE CURB - SEE DETAIL, SHEET 3
- ⑦ PR FIRE HYDRANT
- ⑧ PR FENCE, SEE LANDSCAPE ARCHITECTURE PLANS FOR DETAILS
- ⑨ PR DUMPSTER, SEE ARCHITECTURE PLANS FOR DETAILS
- ⑩ PR 8" BIKE PATH - SEE DETAIL, SHEET 3
- ⑪ PR PAVEMENT MARKING MODIFICATIONS - SEE DETAIL, SHEET 14.


LEGEND

- PARKING COUNT
- PR CONCRETE
- PR HEAVY DUTY ASPHALT PAVEMENT
- PR ELECTRIC TRANSFORMER
- PR SITE LIGHTING



DESCRIPTION		DATE	BY
NO.			
1	160 DUBIN ROAD, SUITE 100 COLUMBUS, OH 43215 TEL: 614.441.4222 FAX: 614.441.4240	10/04/19	MS
2	PROJECT DATE: PROJECT NO.: DRAWN BY: CHECKED BY:	E1900022	SEF
TECHNICAL SKILL CREATIVE SPIRIT			
Mannik Smith Group www.manniksmithgroup.com			
PREPARED FOR:		EQUITY CONSTRUCTION SOLUTIONS 4653 TRULEMAN BLVD., SUITE 100 HILLIARD, OH 43005	
SITE IMPROVEMENT PLAN		POWELL OFFICE CONDOMINIUMS 8930 LIBERTY ROAD POWELL, OHIO 43065	
SITE PLAN		6 / 15	

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LEGEND

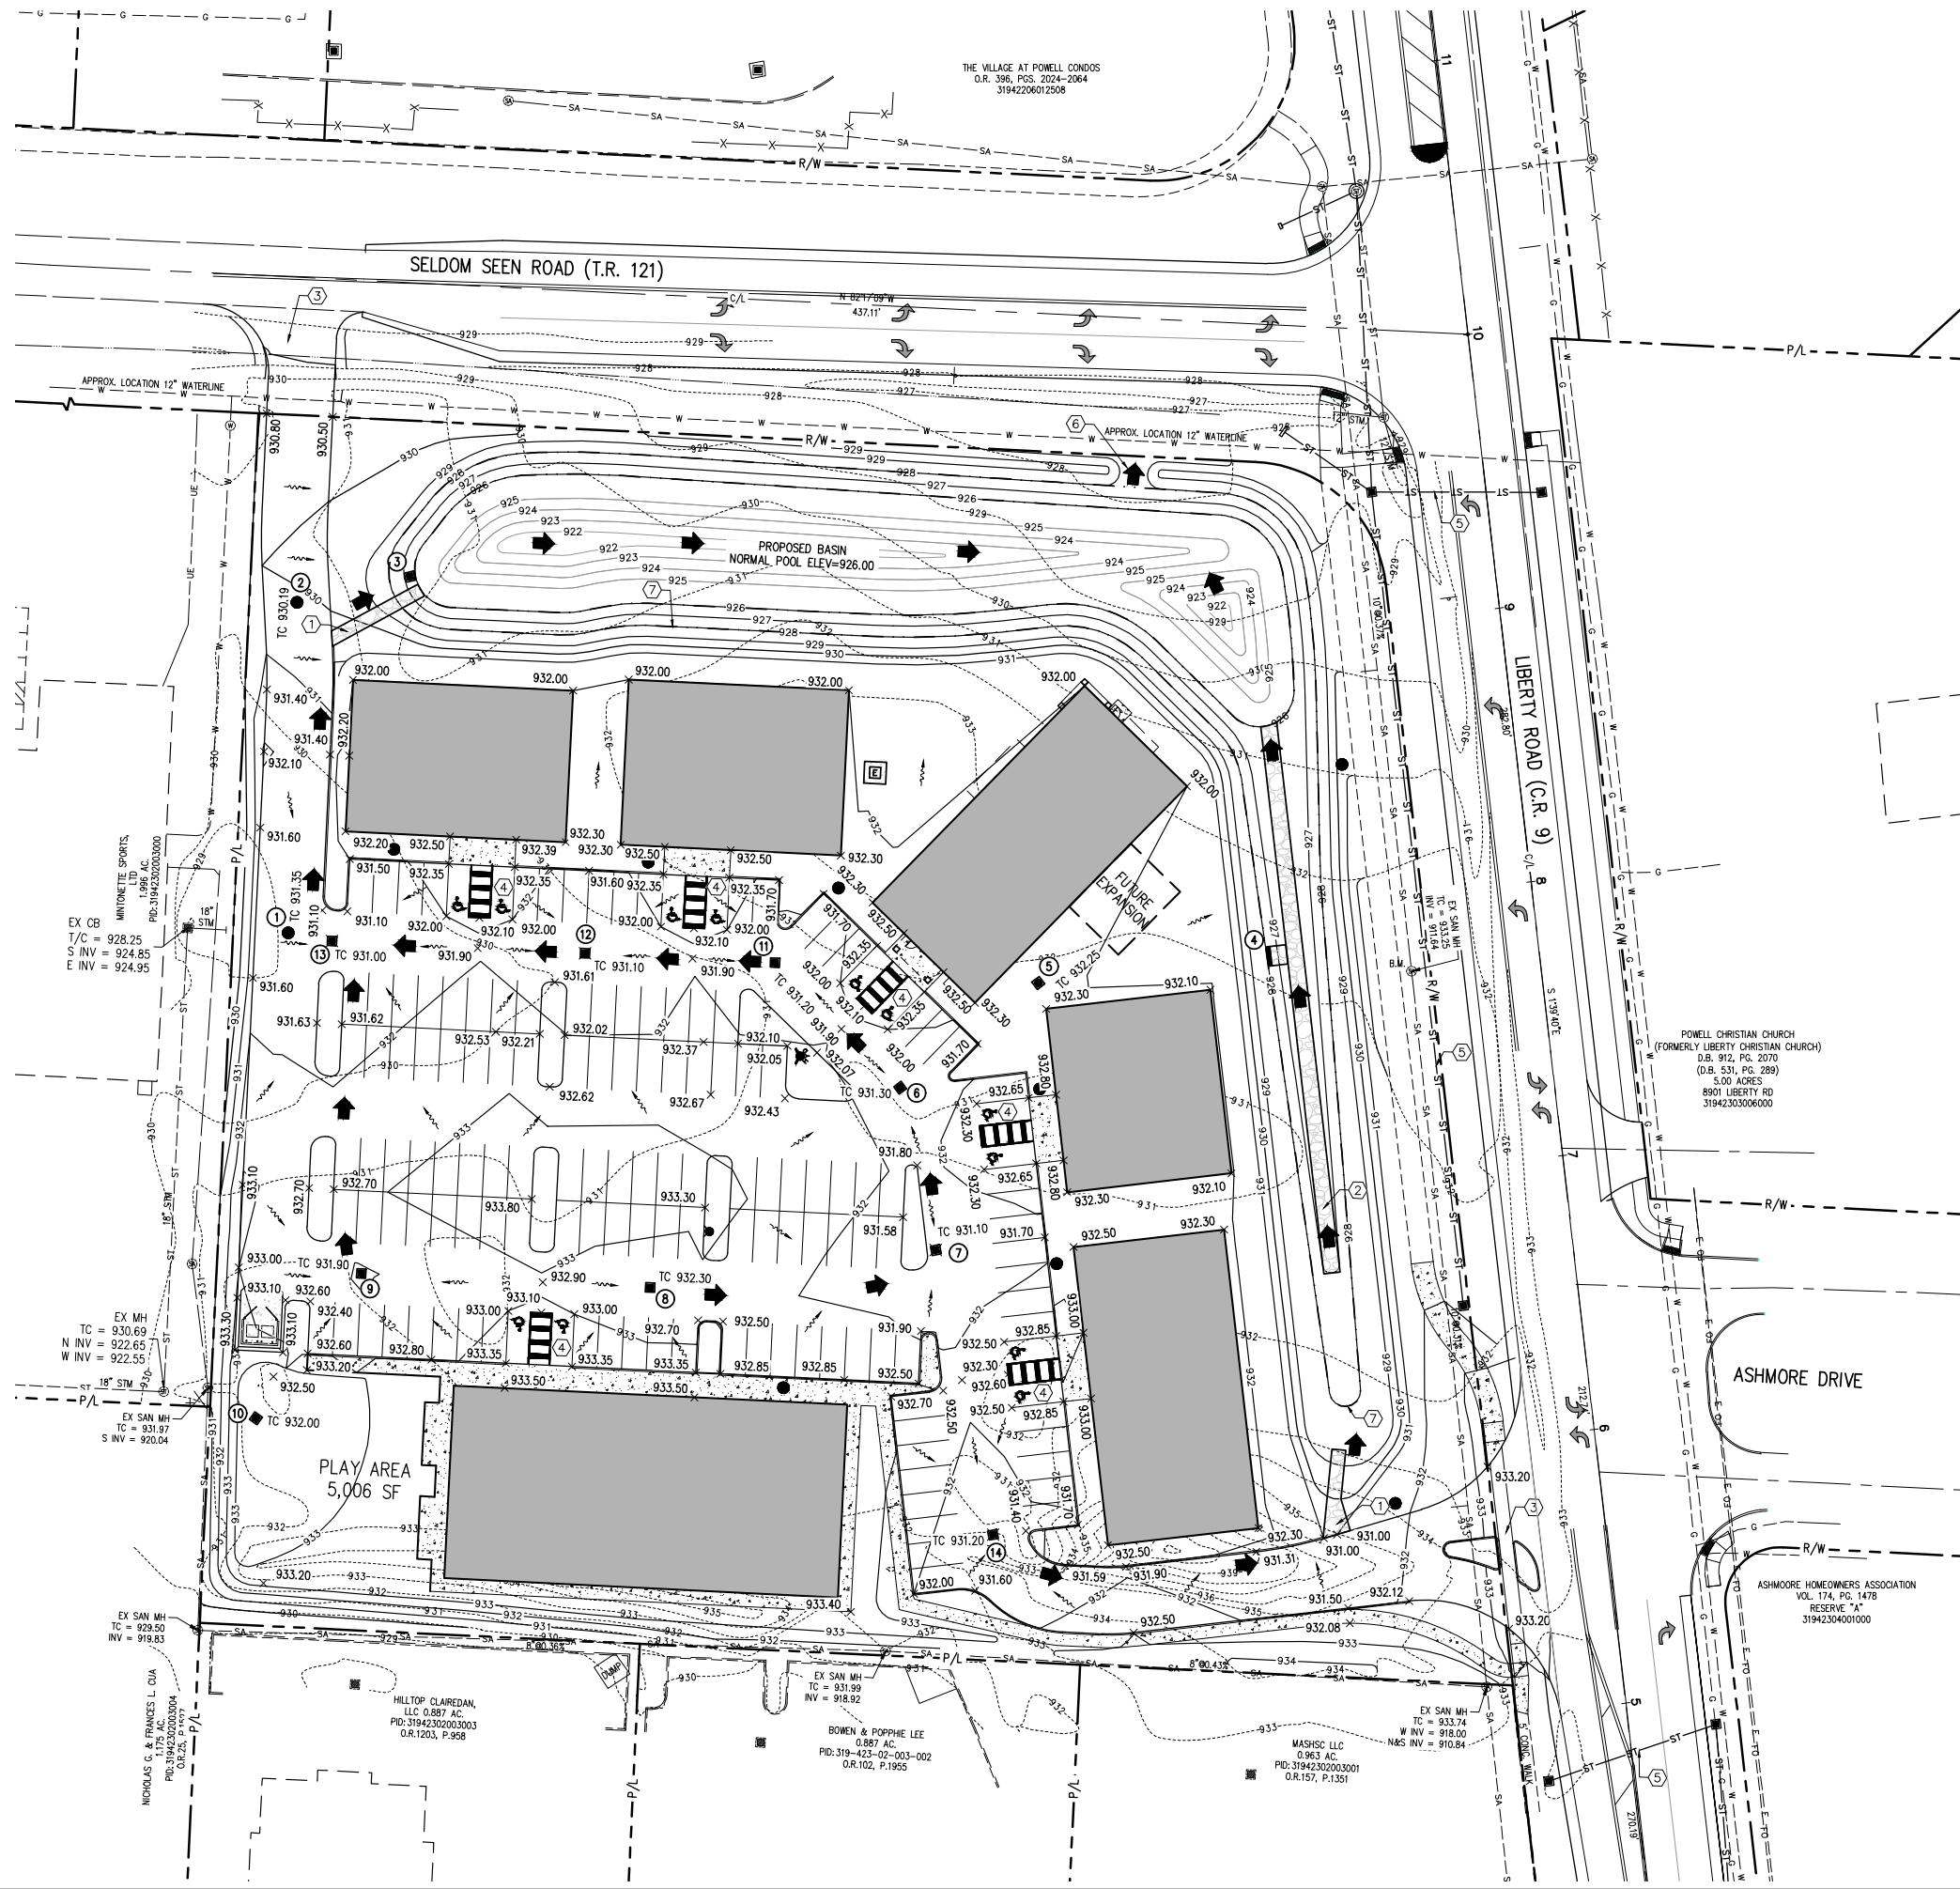
- W EX WATER LINE
- OHE EX OVERHEAD ELECTRIC
- SA EX SANITARY LINE
- ST EX STORM LINE
- X EX FENCE LINE
- EX WATER VALVE
- ⊕ EX FIRE HYDRANT
- ⊞ EX CATCH BASIN
- ⊙ EX STORM MANHOLE
- ⊙ EX SANITARY MANHOLE
- ⊕ EX POWER POLE
- ⊕ EX TELEPHONE POLE
- FLOW ARROW
- 930.00' EX SPOT ELEVATION
- 930.50' PR SPOT ELEVATION
- ➔ PR MAJOR FLOOD ROUTING (GREATER THAN 100-YR EVENT)
- ⊕ PR FIRE HYDRANT

GRADING PLAN NOTES


- ALL SPOTS ARE PAVEMENT ELEVATION, UNLESS OTHERWISE NOTED.
- ADD 0.5' TO PAVEMENT SPOT TO DETERMINE TOP OF CURB ELEVATION.
- THE CONTRACTOR SHALL EXERCISE EXTREME CARE WHEN ESTABLISHING ALL GRADES AND SLOPES IN PAVEMENT AREAS, RAMPS AND SIDEWALKS IN THE VICINITY OF HANDICAP PARKING. ACCESS AREAS SHALL COMPLY WITH FEDERAL, STATE AND LOCAL CODES. SLOPES NOT TO EXCEED 2% IN ANY DIRECTION.
- THE CONTRACTOR SHALL PROVIDE FOR POSITIVE DRAINAGE IN ALL AREAS. PAVEMENT SHALL BE TESTED FOR ANY PONDING CONDITIONS FOLLOWING CONSTRUCTION.
- CONTRACTOR SHALL EXERCISE EXTREME CAUTION WHEN EXCAVATING AROUND EXISTING UTILITIES. COORDINATE ANY RELOCATION WITH RESPECTIVE UTILITY OWNER.
- CONTRACTOR SHALL INSTALL/PLACE ORANGE MESH CONSTRUCTION/BARRIER FENCING AROUND WETLANDS. A SIGN INDICATING THIS AS A "WETLAND ZONE- NO DISTURBANCE PERMITTED" TO BE INSTALLED.

CODED NOTES

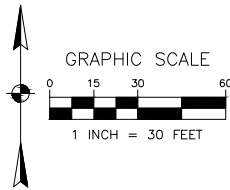- PR ROCK CHANNEL, SEE DETAIL SHEET 11
- PR LOW FLOW GRAVEL CHANNEL, SEE DETAIL SHEET 11
- SEE DRIVE DETAILS, SHEET 10
- WALK FLUSH WITH PAVEMENT, SEE DETAIL SHEET 3
- ROAD IMPROVEMENT PLAN STORM
- EMERGENCY SPILLWAY, SEE DETAIL SHEET 9
- 100 YEAR WATER SURFACE ELEVATION



DESCRIPTION		NO.	DATE	BY
1160 DUBIN ROAD, SUITE 100 COLUMBUS, OH 43215 TEL: 614.441.4222 FAX: 614.482.1040				
PROJECT NO.: 100419 PROJECT DATE: E120022 DRAWN BY: MS CHECKED BY: SEF				
TECHNICAL SKILL CREATIVE SPIRIT				
Mannik Smith Group www.manniksmithgroup.com				
PREPARED FOR: EQUITY CONSTRUCTION SOLUTIONS 4653 TRULIUM BLVD., SUITE 100 HILLIARD, OH 43065				
SITE IMPROVEMENT PLAN POWELL OFFICE CONDOMINIUMS 8930 LIBERTY ROAD POWELL, OHIO 43065				
GRADING PLAN				
8 / 15				

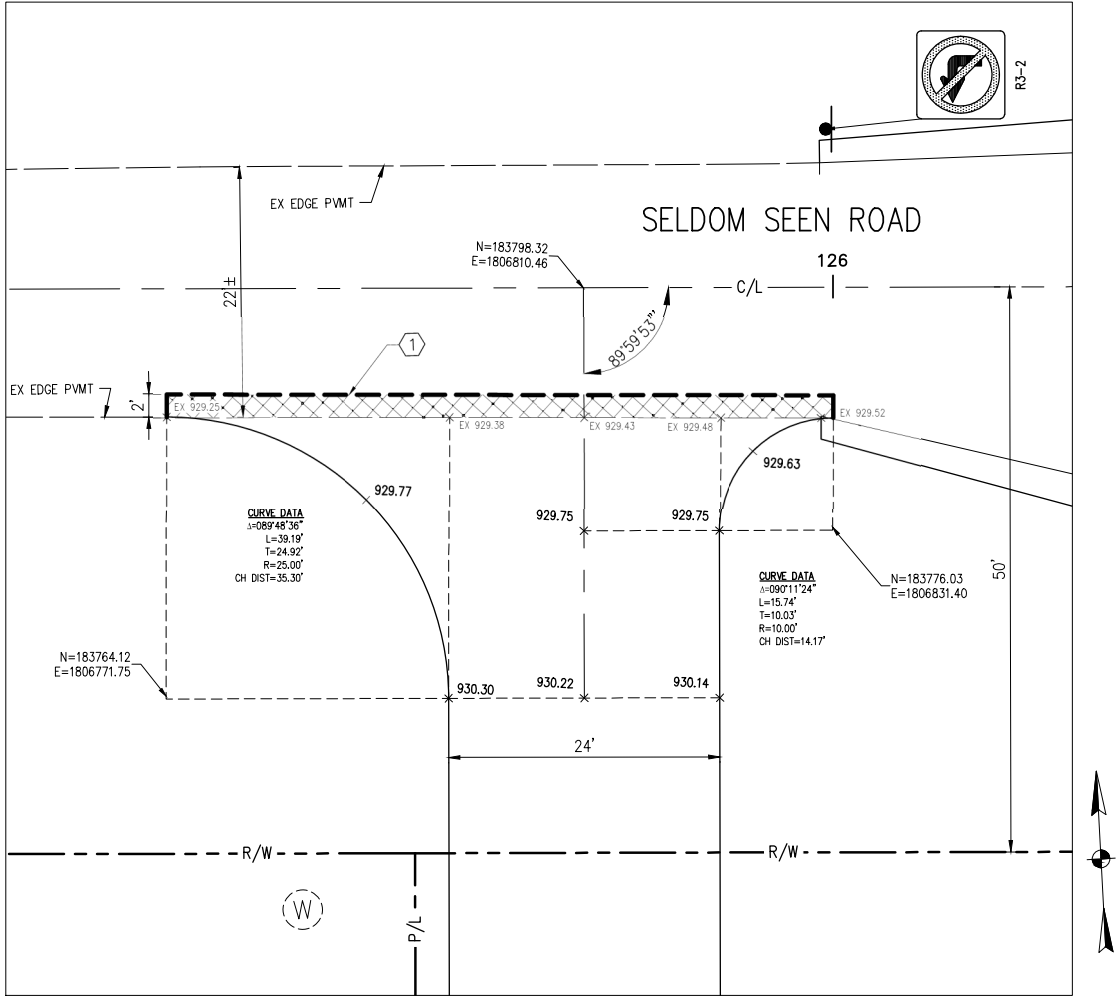


DRIVE DETAIL - SELDOM SEEN ROAD
SCALE: 1"=10'

LEGEND


- PR FULL DEPTH PERMANENT PAVEMENT REPLACEMENT
- PR CONCRETE

KEYED NOTES

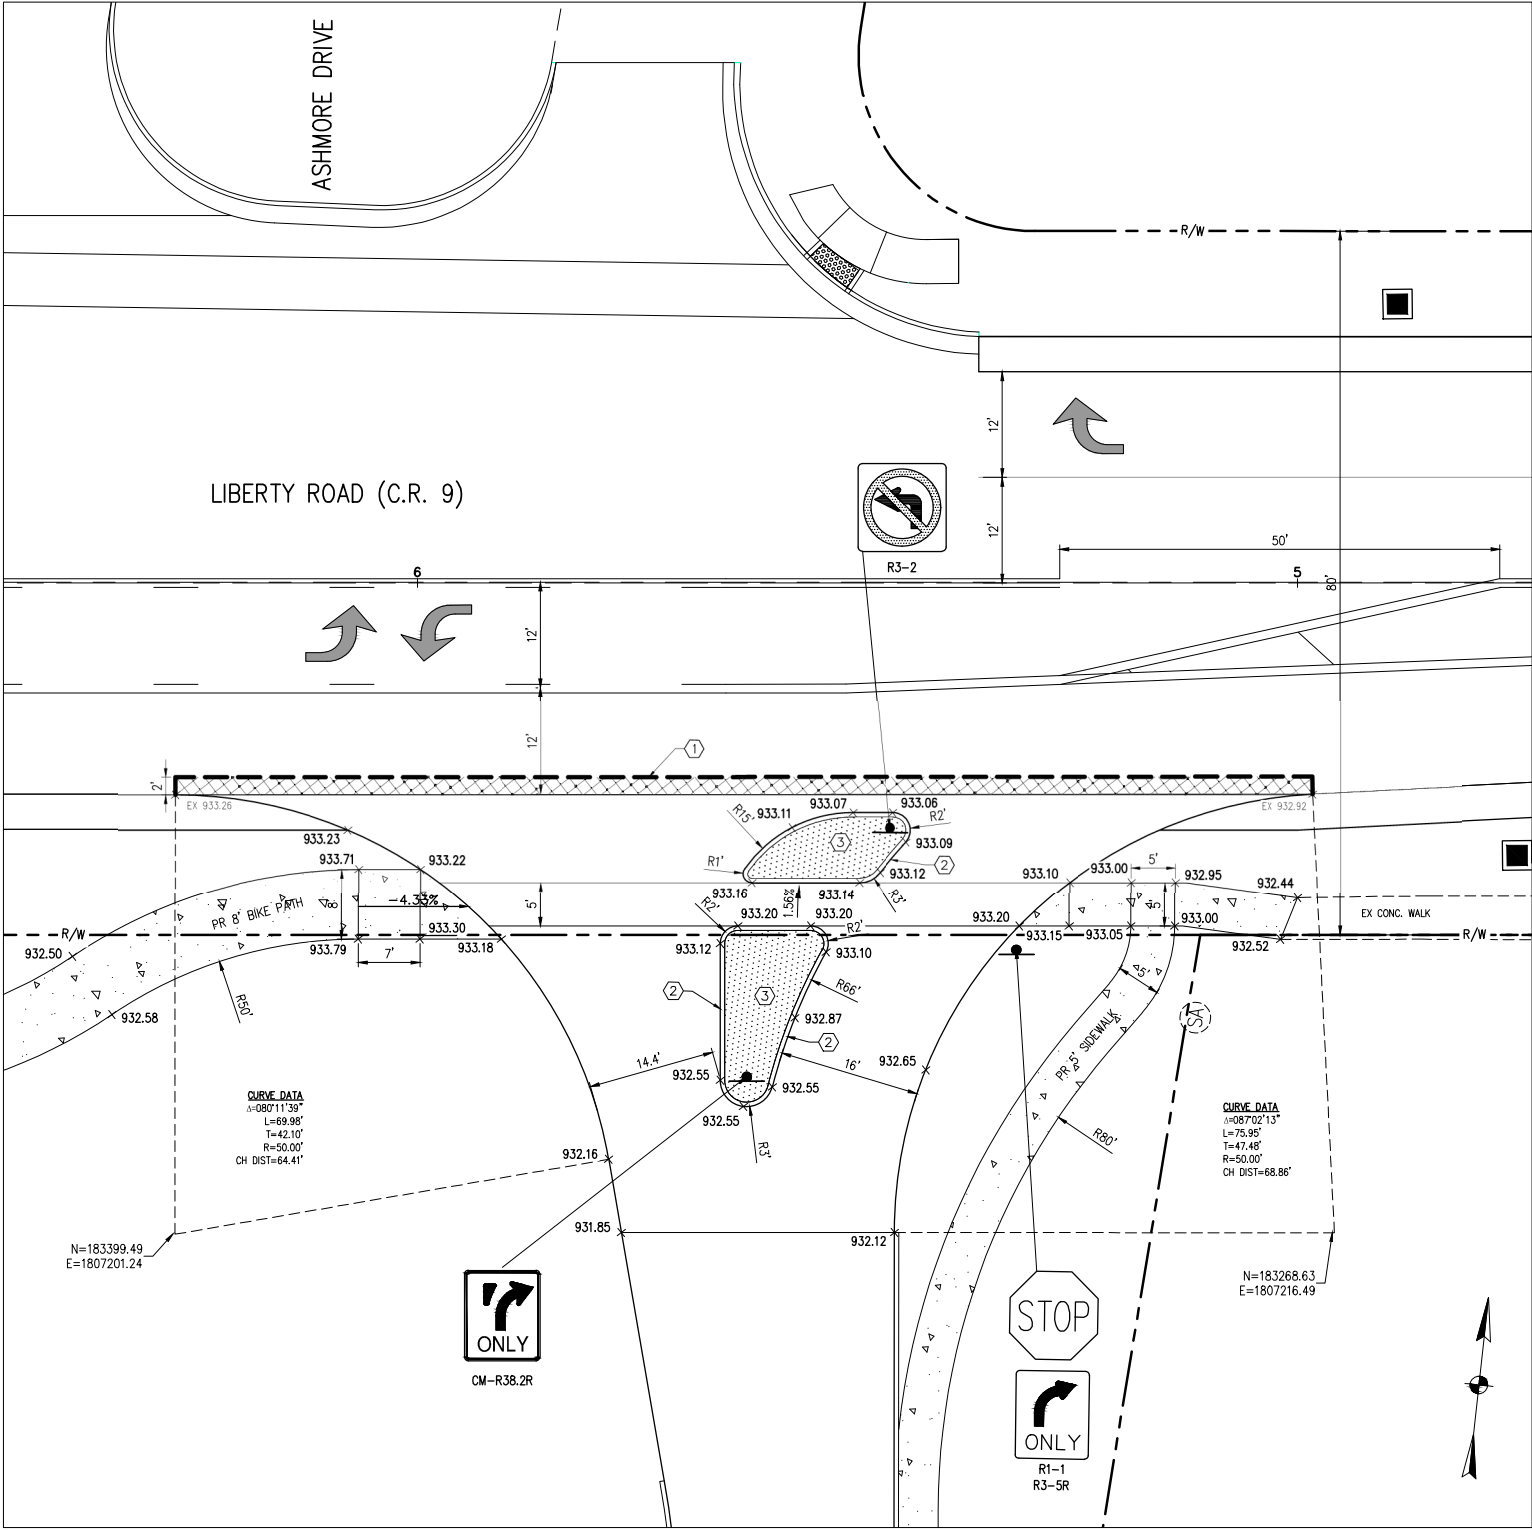- ① SAWCUT LINE SHALL BE MINIMUM 2' FROM EXISTING EDGE OF PAVEMENT
- ② 18" STRAIGHT CURB PER STD DWG 2000
- ③ 6" CONCRETE MEDIAN



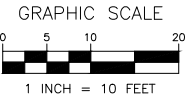DRIVE DETAIL - LIBERTY ROAD
SCALE: 1"=10'









NO.	DATE	BY	DESCRIPTION
1160 DUBIN ROAD, SUITE 100 COLUMBUS, OH 43215 TEL: 614.441.4222 FAX: 614.441.4240	10/04/19	E190022	MS
PROJECT NO:	1004/19	E190022	MS
PROJECT DATE:	10/04/19	E190022	MS
DRAWN BY:	10/04/19	E190022	MS
CHECKED BY:	10/04/19	E190022	MS


PREPARED FOR:	EQUITY CONSTRUCTION SOLUTIONS
4653 TRULEMAN BLVD., SUITE 100 HILLIARD, OH 43026	

SITE IMPROVEMENT PLAN	POWELL OFFICE CONDOMINIUMS
8930 LIBERTY ROAD POWELL, OHIO 43065	


DRIVE DETAILS	10 / 15
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- * COMPACTED BACKFILL PER ITEM 911
- ** COMPACTED GRANULAR BACKFILL PER ITEM 912

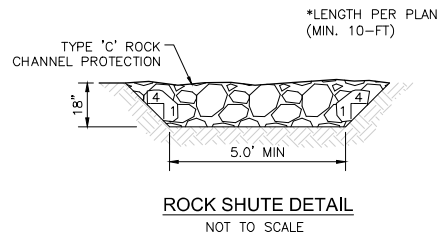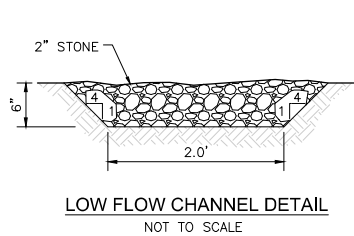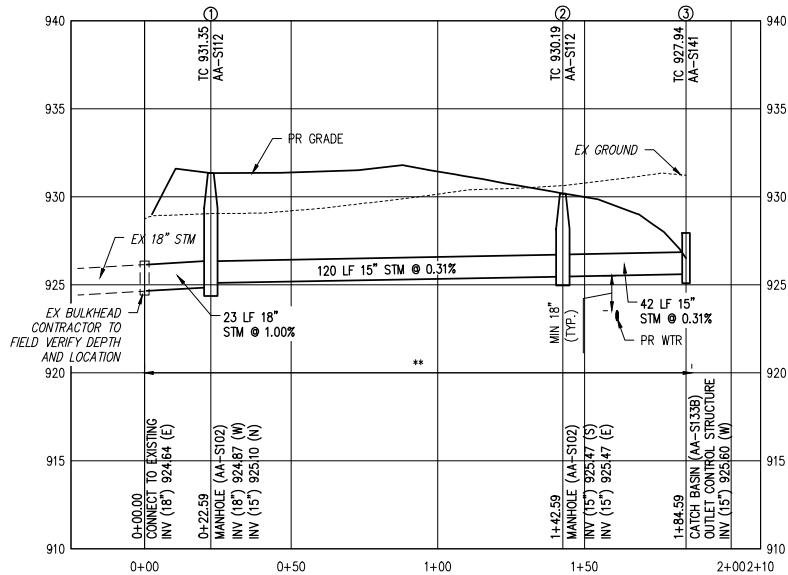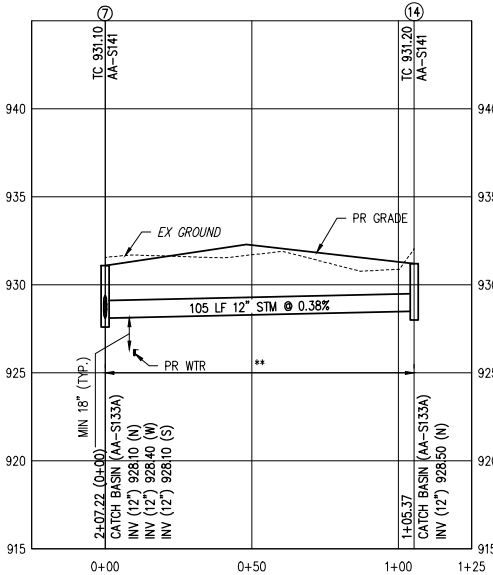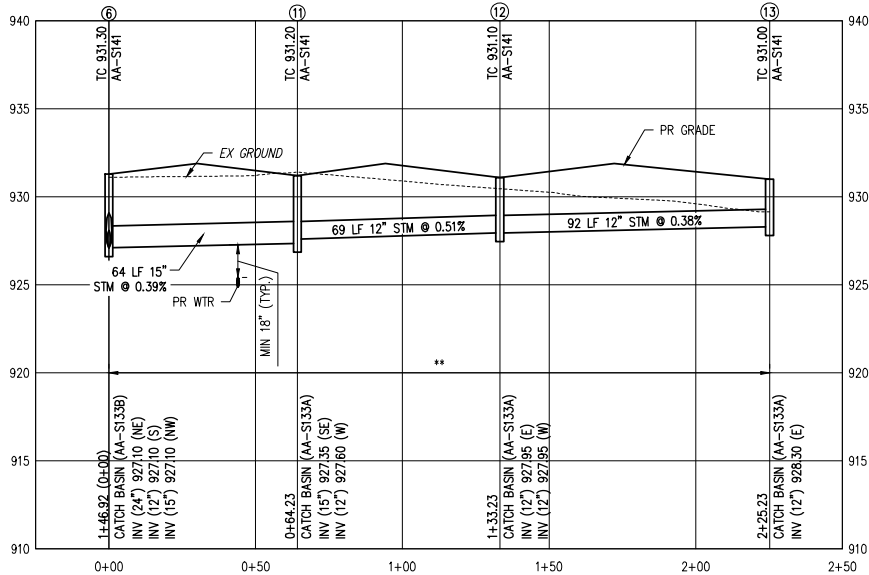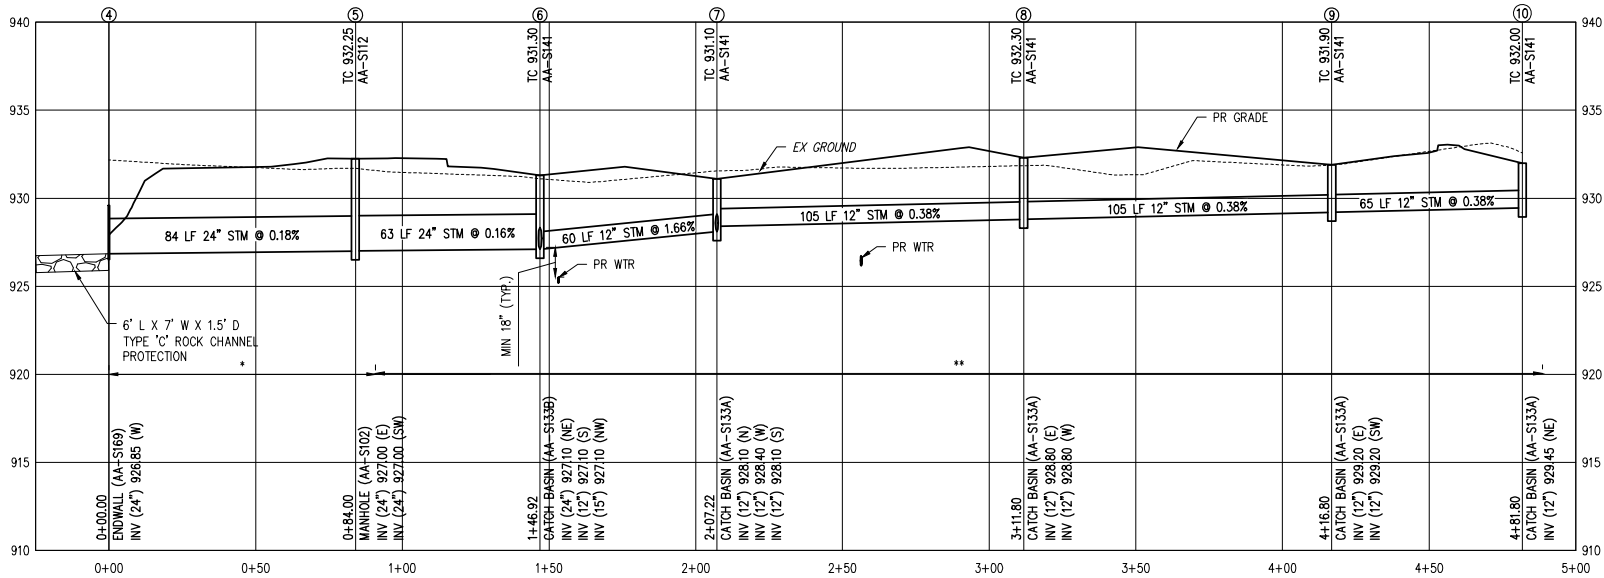


STORM SEWER PROFILES 11 / 15	SITE IMPROVEMENT PLAN POWELL OFFICE CONDOMINIUMS 8930 LIBERTY ROAD POWELL, OHIO 43065	PREPARED FOR: EQUITY CONSTRUCTION SOLUTIONS 4653 TRULEMAN BLVD., SUITE 100 HILLIARD, OH 43026	 TECHNICAL SKILL CREATIVE SPIRIT	1160 DUBIN ROAD, SUITE 100 COLUMBUS, OH 43215 TEL: 614.441.4222 FAX: 614.482.1740 PROJECT DATE: 10/04/19 PROJECT NO: E190022 DRAWN BY: MS CHECKED BY: SEF	NO. DATE BY DESCRIPTION
	1160 DUBIN ROAD, SUITE 100 COLUMBUS, OH 43215 TEL: 614.441.4222 FAX: 614.482.1740 PROJECT DATE: 10/04/19 PROJECT NO: E190022 DRAWN BY: MS CHECKED BY: SEF				

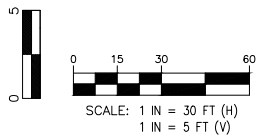

LEGEND

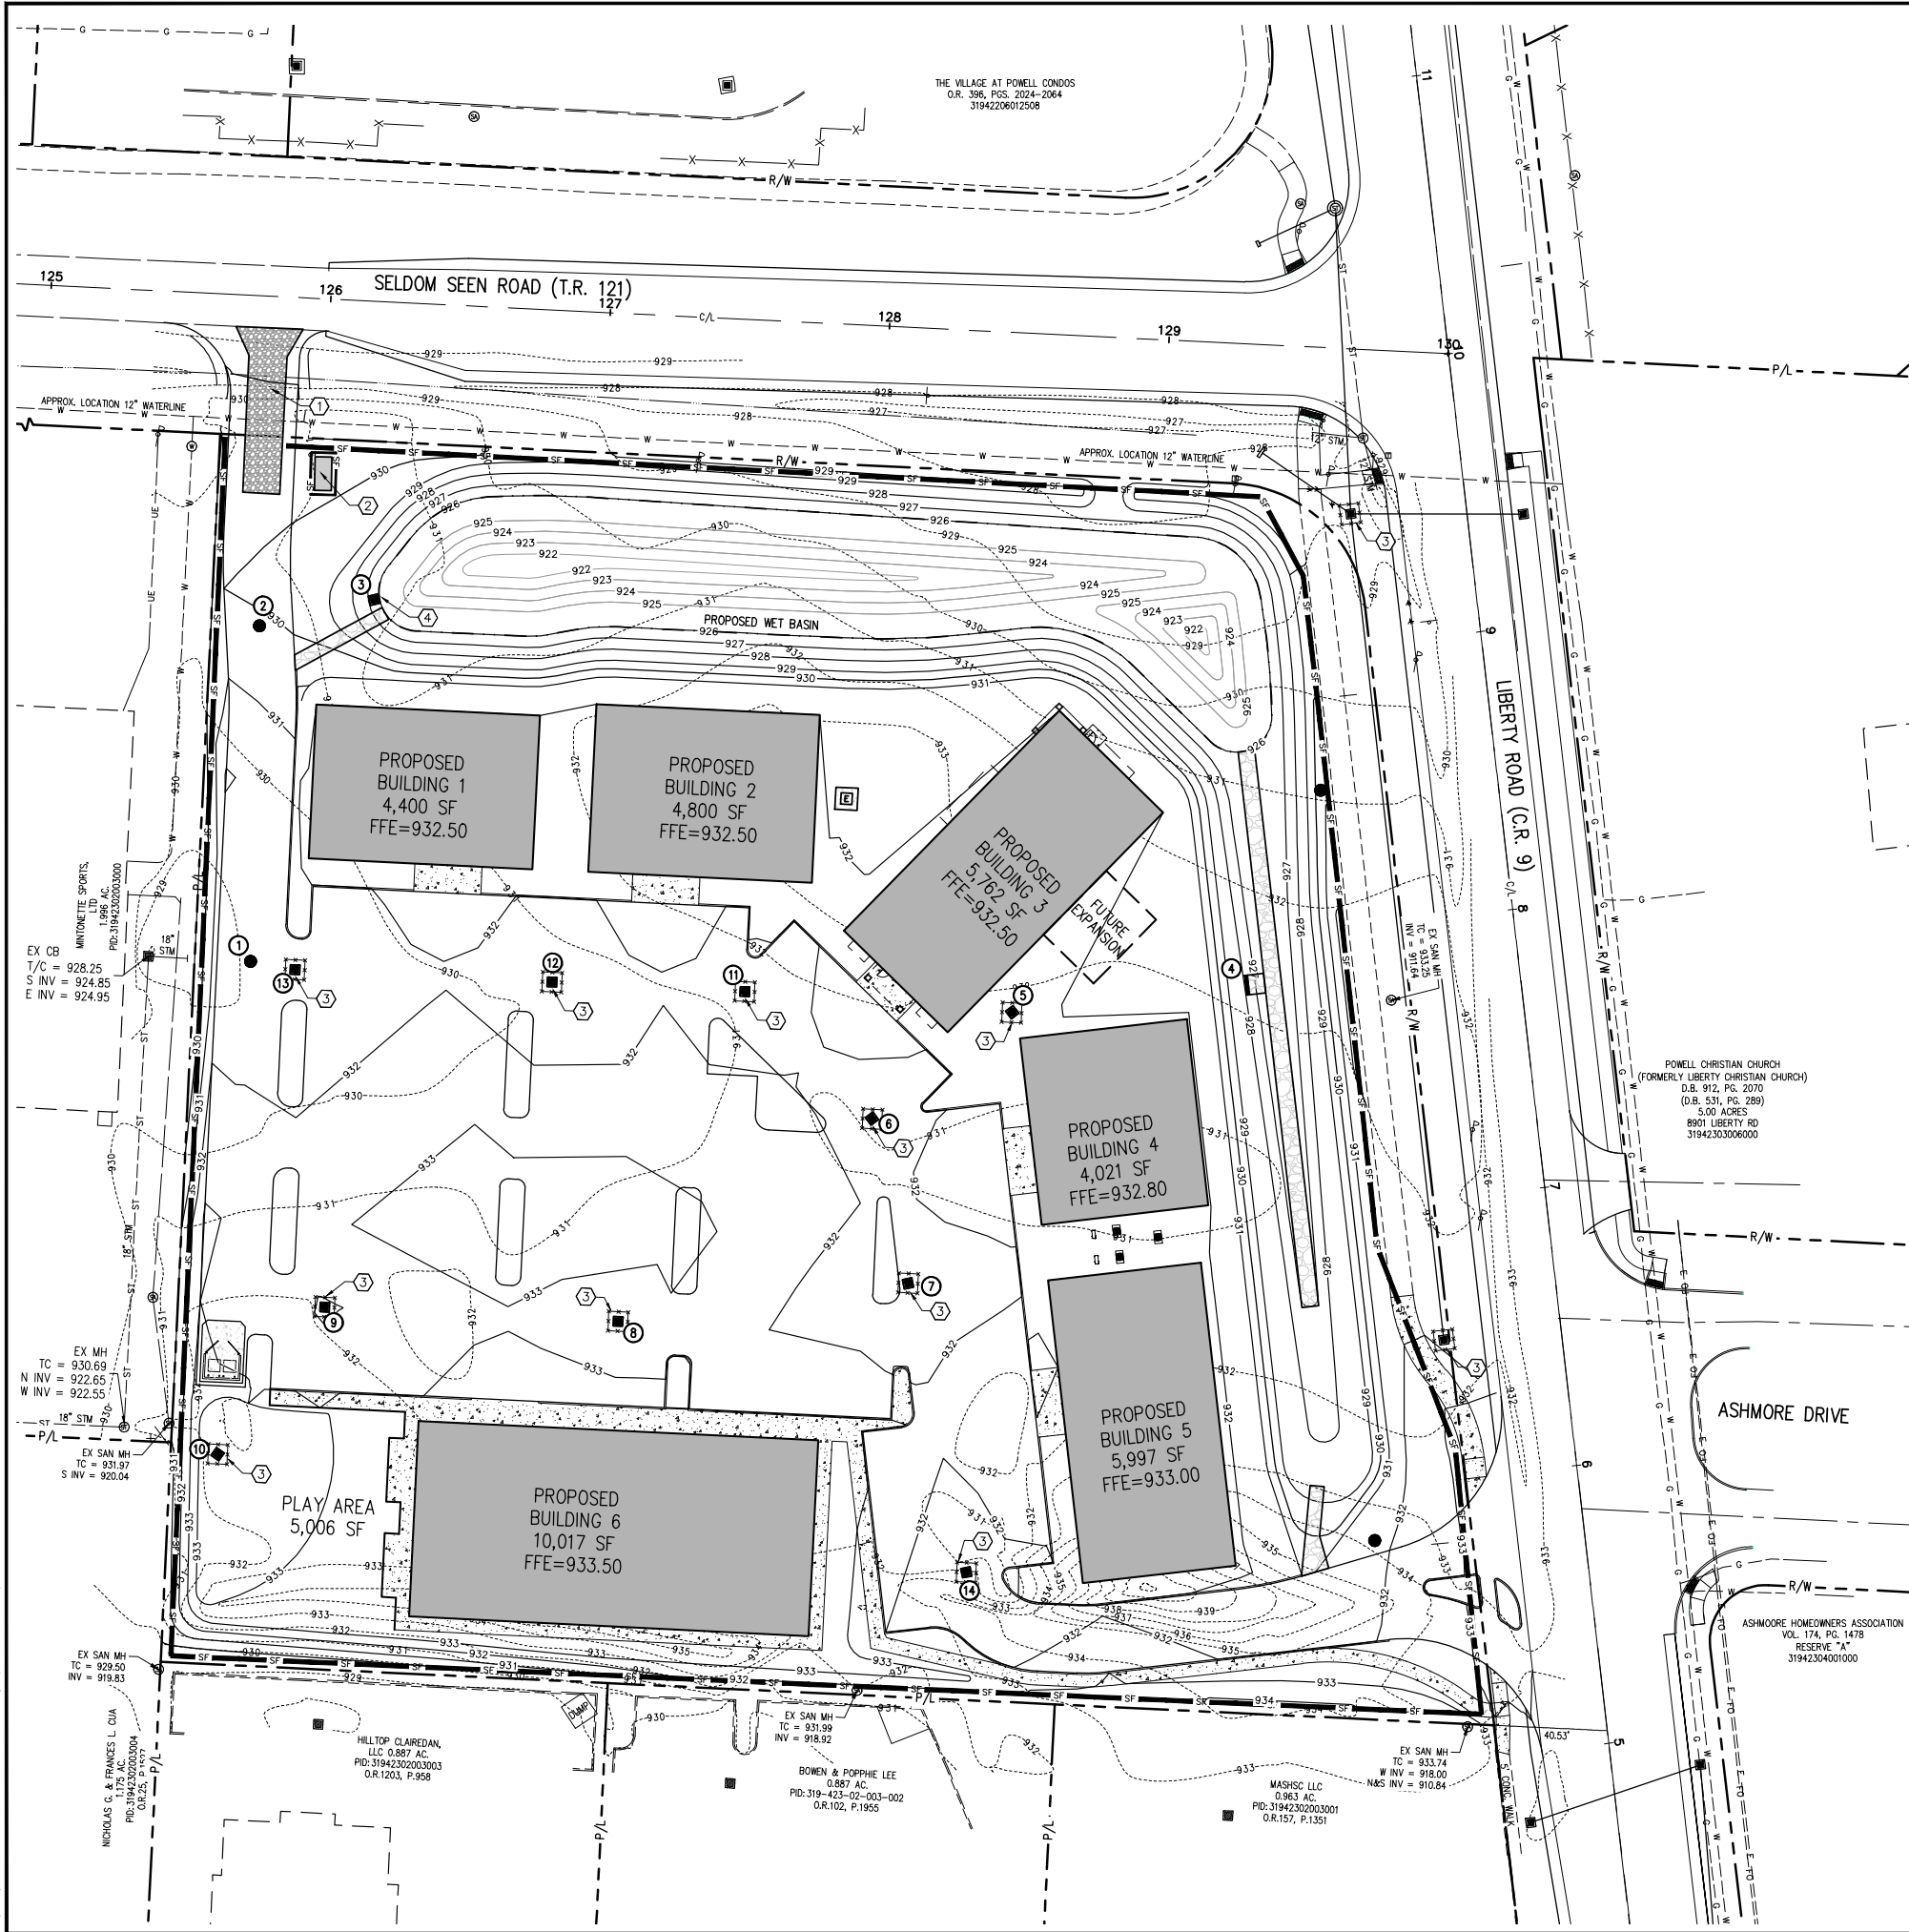
- EXISTING CATCH BASIN
- EXISTING SANITARY MANHOLE
- PROPOSED CATCH BASIN
- PROPOSED STORM STRUCTURE NUMBER
- PROPOSED MANHOLE
- PROPOSED ENDWALL/HEADWALL
- FLOW ARROW
- EX CONTOUR
- PR CONTOUR
- SILT FENCE
- CONCRETE WASHOUT
- STABILIZED CONSTRUCTION ENTRANCE
- INSTALL JUTE MATTING AFTER EXCAVATION/EMBANKMENT ACTIVITIES
- PROPOSED INLET PROTECTION

DISTURBED AREA	4.44 AC
SEDIMENT STORAGE VOLUME REQUIRED	4,440 FT ³
SEDIMENT STORAGE VOLUME PROVIDED	10,623 FT ³
DEWATERING VOLUME REQUIRED	7,992 FT ³
DEWATERING VOLUME PROVIDED	17,327 FT ³

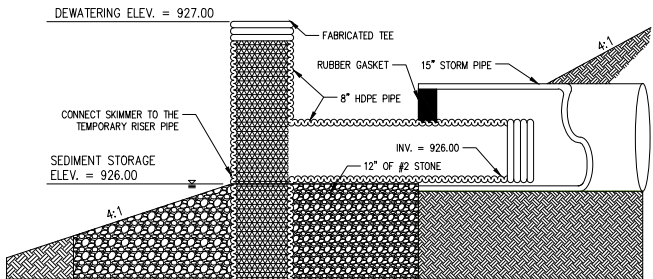


TEMPORARY SEDIMENT CONTROL STAND PIPE DETAIL
NOT TO SCALE

SKIMMER SPECIFICATIONS		
SKIMMER DIAMETER SIZE (INCHES)	SKIMMER ORIFICE DIAMETER (INCHES)	SKIMMER PIPE LENGTH (FEET)
3.0	2.8	8.0

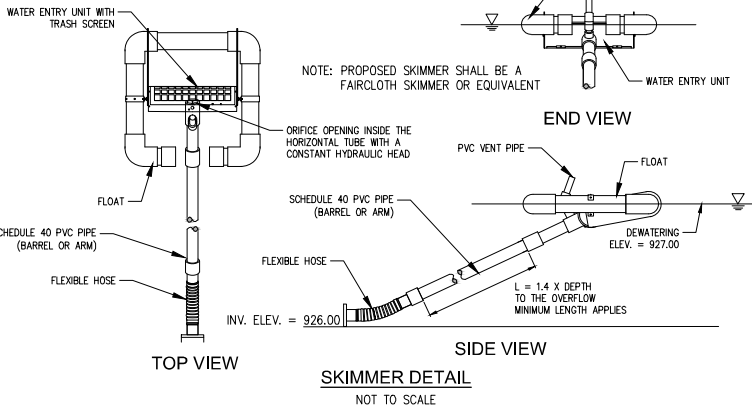

KEYED NOTES

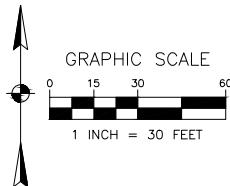- STABILIZED CONSTRUCTION ENTRANCE, SEE DETAIL ON SHEET 13
- CONCRETE WASHOUT, SEE DETAIL ON SHEET 13
- INLET PROTECTION, SEE DETAILS ON SHEET 13
- TEMPORARY SEDIMENT CONTROL STANDPIPE, SEE DETAIL THIS SHEET



DESCRIPTION

BY

DATE

NO.

1004/19

MS

SEF

1160 DUBIN ROAD, SUITE 100
COLUMBUS, OH 43215
TEL: 614.441.4222
FAX: 614.441.4240

PROJECT NO.: E120022

PROJECT DATE: 10/04/19

DRAWN BY: MS

CHECKED BY: SEF

TECHNICAL SKILL
CREATIVE SPIRIT

Mannik Smith Group

www.manniksmithgroup.com

PREPARED FOR:

EQUITY
CONSTRUCTION
SOLUTIONS

4653 TRULMAN BLVD., SUITE 100
HILLIARD, OH 43005

SITE IMPROVEMENT PLAN

**POWELL OFFICE
CONDOMINIUMS**

8930 LIBERTY ROAD POWELL, OHIO 43065

STORM WATER POLLUTION
PREVENTION PLAN

12 / 15

GENERAL NOTES

- NOT ALL EROSION CONTROL MEASURES SHOWN WILL BE IN USE AT THE SAME TIME. PHASING SHALL BE DETERMINED BY THE CONTRACTOR AND EROSION CONTROL DEVICES SHALL BE MODIFIED ACCORDINGLY.
- STREET CLEANING (ON AN AS-NEEDED BASIS) IS REQUIRED THROUGH THE DURATION OF THIS CONSTRUCTION PROJECT. THIS INCLUDES SWEEPING, POWER CLEANING AND (IF NECESSARY) MANUAL REMOVAL OF DIRT OR MUD IN THE STREET GUTTERS.
- THIS PLAN MUST BE POSTED ON-SITE. A COPY OF THE SWPPP PLAN AND THE APPROVED EPA STORMWATER PERMIT (WITH THE SITE-SPECIFIC NOI NUMBER) SHALL BE KEPT ON-SITE AT ALL TIMES.
- DIRECT DISCHARGE OF SEDIMENT LADEN WATER TO THE CITY'S SEWER SYSTEM OR A RECEIVING STREAM IS A VIOLATION OF OHIO EPA AND CITY OF POWELL REGULATIONS. THE CONTRACTOR WILL BE HELD LIABLE FOR THE VIOLATION AND SUBSEQUENT FINES.

PLAN DESIGNER

THE MANNIK & SMITH GROUP
1160 DUBLIN ROAD, SUITE 100
COLUMBUS, OH 43215
CONTACT: STEVEN E FOX
PHONE: (614) 441-4222
EMAIL: SFOX@MANNIKSMITHGROUP.COM

PROJECT OWNER

EQUITY CONSTRUCTION SOLUTIONS
4653 TRUDMAN BLVD., SUITE 100
HILLIARD, OHIO 43026
CONTACT: SHAWN BOYSKO
PHONE: 614-363-8328
EMAIL: SBOYSKO@ECSBUILDS.COM

PROJECT DESCRIPTION

PROJECT CONSISTS OF DEVELOPING A OFFICE CONDOMINIUMS FACILITY ON AN UNDEVELOPED LOT.

AREA OF PROJECT SITE

TOTAL SITE AREA: 4.40± AC.
TOTAL DISTURBED AREA: 4.40± AC.

EXISTING SITE CONDITIONS

THE EXISTING SITE CONTAINS GRASS, BRUSH, AND TREES THAT WILL BE CLEARED FOR NEW CONSTRUCTION.

ADJACENT AREAS

THE SITE IS BOUNDED BY SELDOM SEEN ROAD ON THE NORTH, LIBERTY ROAD ON THE EAST, COMMERCIAL ON THE SOUTH & WEST.

RECEIVING STREAM/SURFACE WATER

OLENTANGY RIVER

EROSION AND SEDIMENT CONTROL MEASURES

SEDIMENT FENCE AND INLET PROTECTION SHALL BE USED AS SHOWN ON THE PLAN.

POST CONSTRUCTION STORM WATER MANAGEMENT

WATER QUALITY WILL BE ACCOUNTED FOR ON THIS DEVELOPMENT THROUGH DRAWDOWN IN WET DETENTION BASIN.

SITE CONTACT

SHAWN BOYSKO
PHONE: 614-363-8328
EMAIL: SBOYSKO@ECSBUILDS.COM

OHIO EPA NPDES PERMIT

OEPA # - TBD

BMP STRUCTURE NOTICE

STRUCTURES ③ ARE BMPs AND ARE AN INTEGRAL PART OF THE PRIVATE STORM SEWER SYSTEM DEPICTED IN THESE DRAWINGS. RESPONSIBILITY AND ASSURANCE OF PERIODIC MAINTENANCE AND THE CONTINUOUS FUNCTIONALITY OF THESE STORMWATER QUALITY DEVICES IS PERPETUAL; BEGINNING WITH THE OWNER AT THE TIME OF INSTALLATION AND CONTINUING TO ALL FUTURE OWNERS OF SAID PRIVATE STORM SEWER SYSTEM.

POST CONSTRUCTION MAINTENANCE

- PERIODIC INSPECTIONS OF THE STORM WATER CONTROL FACILITY AND ITS APPURTENANCES AT A FREQUENCY STIPULATED IN THE APPROVED STORM WATER CONTROL MAINTENANCE PLAN.
- INSPECTIONS SHALL INCLUDE THE COMPLETION OF DATED AND SIGNED INSPECTION CHECKLISTS PROVIDED IN THE STORM WATER CONTROL FACILITY MAINTENANCE PLAN AND THE NOTATION OF ALL DEFICIENCIES OBSERVED DURING THE INSPECTION.
- THE PROPERTY OWNER SHALL MAINTAIN COPIES OF COMPLETE DATED AND SIGNED INSPECTION CHECKLISTS OF MAINTENANCE ACTIVITIES PERFORMED BY PROPERTY OWNER TO REMEDY THE DEFICIENCIES OBSERVED DURING INSPECTION.

EROSION CONTROL NOTES

- ALL CONSTRUCTION METHODS AND MATERIALS MUST CONFORM TO CURRENT STANDARDS AND SPECIFICATIONS OF THE FEDERAL, STATE, COUNTY, CITY OR LOCAL REQUIREMENTS, WHICHEVER HAS JURISDICTION.
- PER THE NPDES CONSTRUCTION GENERAL PERMIT OH0000002, ALL CONTRACTORS AND SUBCONTRACTORS ARE REQUIRED BY THE OHIO EPA TO OBTAIN CO-PERMITS.
- LAND ALTERATION WHICH STRIPS THE LAND OF VEGETATION, INCLUDING REGRADING, SHALL BE DONE IN A WAY THAT WILL MINIMIZE EROSION.
- THIS PLAN SHALL NOT BE CONSIDERED ALL INCLUSIVE AS THE CONTRACTOR SHALL TAKE ALL NECESSARY PRECAUTIONS TO PREVENT SOIL SEDIMENT FROM LEAVING THE SITE. ADDITIONAL EROSION AND SEDIMENT CONTROL MEASURES WILL BE INSTALLED IF DEEMED NECESSARY BY ON-SITE INSPECTION.
- SEDIMENT LADEN WATER SHALL BE DETAINED BY EROSION CONTROL PRACTICES AS NEEDED TO MINIMIZE SEDIMENTATION IN THE RECEIVING STREAM. NO STORM WATER SHALL BE DISCHARGED FROM THE SITE IN A MANNER THAT CAUSES EROSION AT THE POINT OF DISCHARGE.
- WASTES AND UNUSED BUILDING MATERIALS SHALL NOT BE ALLOWED TO BE CARRIED FROM THE SITE BY STORM WATER RUNOFF. PROPER DISPOSAL OF ALL WASTES AND UNUSED BUILDING MATERIALS IS REQUIRED.
- SEDIMENT BEING TRACKED ONTO PUBLIC OR PRIVATE ROADWAYS SHALL BE MINIMIZED. CLEARING OF ACCUMULATED SEDIMENT SHALL NOT INCLUDE FLUSHING WITH WATER. CLEARED SEDIMENT SHALL BE RETURNED TO THE SITE FOR DISPOSAL.
- SOIL WHICH HAS ACCUMULATED NEXT TO EROSION CONTROL DEVICES SHALL BE COLLECTED AND REDISTRIBUTED ON SITE AFTER EACH RAINFALL EVENT, AND AT LEAST ONCE A WEEK.
- IF INSTALLATION OF STORM DRAINAGE SYSTEM SHOULD BE INTERRUPTED BY WEATHER OR NIGHTFALL, THE PIPE ENDS SHALL BE COVERED WITH FILTER FABRIC.
- ALL EXISTING STRUCTURES, FENCING, TREES AND ETC., WITHIN CONSTRUCTION AREA SHALL BE REMOVED AND DISPOSED OF OFF SITE. BURNING IS NOT ALLOWED ON-SITE.
- SCHEDULE OF EARTHWORK ACTIVITIES:
 - THE DURATION OF TIME WHICH AN AREA REMAINS EXPOSED SHALL BE KEPT TO A PRACTICAL MINIMUM. THE AREA SHALL BE STABILIZED AS SOON AS POSSIBLE. TEMPORARY VEGETATION OR MULCHING SHALL BE USED TO PROTECT EXPOSED AREAS IF PERMANENT VEGETATION CANNOT BE SEEDED WITHIN 14 DAYS OR ACTIVITY CEASES FOR MORE THAN 14 DAYS OR AS DIRECTED BY THE ENGINEER.
 - TOPSOIL REPLACEMENT SHALL TAKE PLACE FROM MARCH 1 TO OCTOBER 31. STOCKPILE TOPSOIL AT ALL OTHER TIMES OF THE YEAR. PERMANENT AND FINAL VEGETATION AND STRUCTURAL EROSION CONTROL DEVICES SHALL BE INSTALLED WITHIN SEVEN (7) DAYS AFTER FINAL GRADING OR AS SOON AS POSSIBLE.
- ALL EROSION AND SEDIMENT CONTROL PRACTICES ARE SUBJECT TO FIELD MODIFICATION AT THE DISCRETION OF THE CITY OF POWELL AND/OR THE OHIO EPA.

TEMPORARY AND PERMANENT SEEDING

THE LIMITS OF SEEDING AND MULCHING ARE ASSUMED TO BE 5'-0" OUTSIDE THE WORK LIMITS. ALL AREAS NOT DESIGNATED TO BE SEEDED SHALL REMAIN UNDER NATURAL GROUND COVER. THOSE AREAS DISTURBED OUTSIDE THE SEEDING LIMITS SHALL BE SEEDED AND MULCHED AT THE CONTRACTOR'S EXPENSE.

TEMPORARY SEEDING: ANY AREA WHICH WILL BE LEFT DORMANT (UNDISTURBED) FOR MORE THAN 21 DAYS SHALL BE SEEDED WITHIN 7 DAYS OF TERMINATED WORK. DISTURBED AREAS WITHIN 50 FEET OF A STREAM, FIRST ORDER OR LARGER, SHALL BE STABILIZED WITHIN 2 DAYS OF INACTIVITY. TEMPORARY SEEDING CONSISTS OF SEEDED PREPARATION AND APPLICATION OF SEED, FERTILIZER, AND WATER. SOIL TEST IS RECOMMENDED TO DETERMINE PROPER APPLICATION RATE OF FERTILIZER AND IF LIME IS NECESSARY.

FERTILIZER 12-12-12	12 LB/1000 SQ. FT.
STRAW MULCH	2 TONS/ACRE
WATER	300 G/1000 SQ. FT.

PERMANENT SEEDING: ANY AREA THAT IS AT FINAL GRADE SHALL BE SEEDED WITHIN 7 DAYS OF TERMINATED WORK. PERMANENT SEEDING CONSISTS OF SEEDED PREPARATION AND APPLICATION OF SEED, FERTILIZER, AND WATER. SOIL TEST IS RECOMMENDED TO DETERMINE PROPER APPLICATION RATE OF FERTILIZER AND IF LIME IS NECESSARY. IDEAL CONDITIONS FOR PERMANENT SEEDING IS MARCH 1-MAY 31 AND AUGUST 1-SEPTEMBER 30.


PERMANENT SEEDING			
SEED MIX	SEEDING RATE		NOTES
	LB/ACRE	LB/1000 SQ.FT.	
GENERAL USE			
CREEPING RED FESCUE	20-40	1/2 - 1	
DOMESTIC RYEGRASS	10-20	1/4 - 1/2	
KENTUCKY BLUEGRASS	10-20	1/4 - 1/2	
TALL FESCUE	40	1	
DWARF FESCUE	40	1	

TEMPORARY SEEDING			
SEEDING DATES	SPECIES	LB./1000 SQ. FT.	PER ACRE
MARCH 1 TO NOVEMBER 1	PERENNIAL RYEGRASS	1	40 LB.
	TALL FESCUE	1	40 LB.
	ANNUAL RYEGRASS	1	40 LB.
NOV. 1 TO SPRING SEEDING	USE MULCH ONLY, SODDING PRACTICES OR DORMANT SEEDING		

NOTE: OTHER APPROVED SEED SPECIES MAY BE SUBSTITUTED.

STORM INSPECTION & MAINTENANCE SCHEDULE

ACTIVITY	SCHEDULE
- CLEAN AND REMOVE DEBRIS FROM INLET AND OUTLET STRUCTURES	MONTHLY/ AFTER HEAVY RAIN EVENTS
- WO STRUCTURE FLOATABLES AND SUMP CLEANOUT SHOULD OCCUR AS SOON AS POSSIBLE FOLLOWING A SPILL IN THE CONTRIBUTING DRAINAGE AREA.	
- INSPECT FOR DAMAGE, PAYING PARTICULAR ATTENTION TO THE CONTROL STRUCTURE	
- MONITOR FOR SEDIMENT ACCUMULATION IN FACILITY. REMOVED SEDIMENT SHALL BE HAULED AWAY AND DISPOSED OF PROPERLY.	ANNUAL INSPECTION
- EXAMINE TO ENSURE THAT INLET AND OUTLET DEVICES ARE FREE OF DEBRIS AND OPERATIONAL.	
- WO STRUCTURE FLOATABLE AND SUMP CLEANOUT ARE TYPICALLY CONDUCTED ONCE A YEAR DURING ANY SEASON.	
NOTES: THE RESPONSIBILITY IS PERPETUAL FOR ALL FUTURE OWNERS OF THIS PROPERTY. COPIES OF SAMPLE INSPECTION LOGS CAN BE FOUND IN COC SWDM APPENDIX E.	

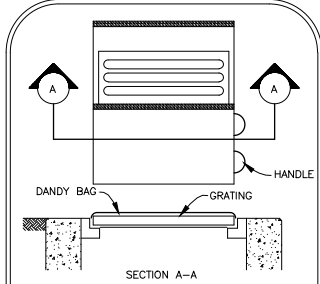

THE DANDY BAG
N.T.S.

INSTALLATION:
STAND GRATE ON END. PLACE DANDY BAG OVER GRATE. FLIP GRATE OVER SO THAT OPEN END IS UP. PULL UP SLACK. TUCK FLAP IN. BE SURE END OF GRATE IS COMPLETELY COVERED BY FLAP OR DANDY BAG WILL NOT FIT PROPERLY. HOLDING HANDLES, CAREFULLY PLACE DANDY BAG WITH GRATE INSERTED INTO CATCH BASIN FRAME SO THAT RED DOT ON THE TOP OF THE DANDY BAG IS VISIBLE.

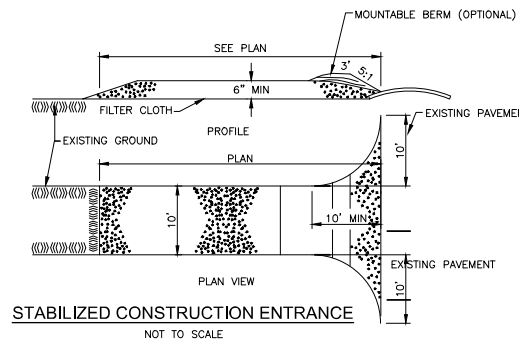
MAINTENANCE:
AFTER SILT HAS DRIED, REMOVE IT FROM THE SURFACE OF DANDY BAG WITH BROOM.

CONSTRUCTION SEQUENCE

- THE CONTRACTOR SHALL ESTABLISH A STABILIZED CONSTRUCTION ENTRANCE.
- THE CONTRACTOR SHALL PLACE THE REQUIRED SEDIMENT FENCE AND INLET PROTECTION ON ANY EXISTING INLETS IN ACCORDANCE WITH THE PLAN DETAILS. INSPECTION BY THE CITY OF POWELL WILL BE REQUIRED PRIOR TO ANY CONSTRUCTION ACTIVITY.
- THE CONTRACTOR SHALL PERFORM SITE EARTHWORK OPERATIONS IN ACCORDANCE WITH THE PLAN DETAILS AND NOTES INCLUDING INSTALLATION OF STORM SEWERS. PROVISIONS FOR INLET PROTECTIONS SHALL BE ESTABLISHED AS REFERENCED BY THE DETAILS SHOWN ON THIS SHEET. THE CONTRACTOR SHALL APPLY WATER OR DUST PALLIATIVE ON DISTURBED AREAS DURING CONSTRUCTION TO ALLEVIATE OR PREVENT DUST NUISANCE PER ITEM 616. DUST PALLIATIVE SHALL CONSIST OF CALCIUM CHLORIDE MEETING THE REQUIREMENTS OF SECTION 712.02. THE WATER OR CALCIUM CHLORIDE SHALL BE SPREAD UNIFORMLY OVER THE SURFACE OF THE DISTURBED AREA.
- EXPOSED SLOPES SHALL BE STABILIZED AS SOON AS THEY ARE ENCOUNTERED.
- THE CONTRACTOR SHALL PLACE SEEDING AND MULCHING AS NECESSARY TO STABILIZE ALL DENUDED AREAS. ALL DENUDED AREAS SHALL HAVE SOIL STABILIZATION APPLIED WITHIN SEVEN (7) DAYS OF DISTURBANCE IF THEY ARE TO BE SUBSTANTIALLY UNWORKED FOR MORE THAN 14 DAYS OR IF THEY ARE AT FINAL GRADE.
- THE CONTRACTOR SHALL REMOVE AND DISPOSE OF THE EROSION CONTROL DEVICES ONLY AFTER ALL AREAS HAVE ESTABLISHED VEGETATIVE COVER AND UPON APPROVAL FROM THE CITY OF POWELL.
- AFTER REMOVAL OF EROSION CONTROL DEVICES, THE CONTRACTOR SHALL CLEAN ALL INLETS AND STORM PIPES OF ALL SEDIMENT INCURRED DURING CONSTRUCTION.


CONSTRUCTION SPECIFICATIONS

- STONE SIZE - USE 2" STONE, OR RECLAIMED OR RECYCLED CONCRETE EQUIVALENT.
- LENGTH - AS REQUIRED.
- THICKNESS - NOT LESS THAN SIX (6) INCHES.
- WIDTH - TWENTY (20) FOOT MINIMUM, BUT NOT LESS THAN THE FULL WIDTH AT POINTS WHERE INGRESS OR EGRESS OCCURS.
- FILTER CLOTH - WILL BE PLACED OVER THE ENTIRE AREA PRIOR TO PLACING OF STONE.
- SURFACE WATER - ALL SURFACE WATER FLOWING OR DIVERTED TOWARD CONSTRUCTION ENTRANCES SHALL BE PIPED ACROSS THE ENTRANCE. IF PIPING IS IMPRACTICAL, A MOUNTABLE BERM WITH 5:1 SLOPES WILL BE PERMITTED. COST OF PIPE SHALL BE INCLUDED IN THE PRICE BID FOR THE STABILIZED CONSTRUCTION ENTRANCE.
- MAINTENANCE - THE ENTRANCE SHALL BE MAINTAINED IN A CONDITION WHICH WILL PREVENT TRACKING OR FLOWING OF SEDIMENT ONTO PUBLIC RIGHT-OF-WAY. THIS MAY REQUIRE PERIODIC TOP DRESSING WITH ADDITIONAL STONE AS CONDITIONS DEMAND AND REPAIR AND/OR CLEANOUT OF ANY MEASURES USED TO TRAP SEDIMENT. ALL SEDIMENT SPILLED, DROPPED, WASHED OR TRACKED ONTO PUBLIC RIGHTS-OF-WAY MUST BE REMOVED IMMEDIATELY.
- WASHING - WHEELS SHALL BE CLEANED TO REMOVE SEDIMENT PRIOR TO ENTRANCE ONTO PUBLIC RIGHT-OF-WAYS. WHEN WASHING IS REQUIRED, IT SHALL BE DONE ON AN AREA STABILIZED WITH STONE AND WHICH DRAINS INTO AN APPROVED SEDIMENT TRAPPING DEVICE.
- PERIODIC INSPECTION AND NEEDED MAINTENANCE SHALL BE PROVIDED AFTER EACH RAIN.




STABILIZED CONSTRUCTION ENTRANCE

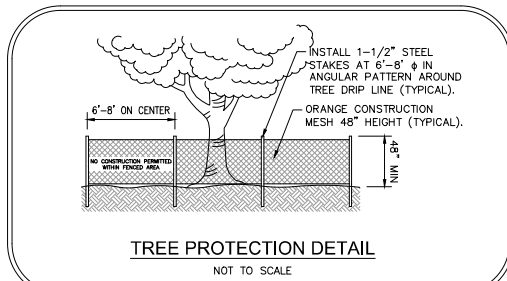NOT TO SCALE




TREE PROTECTION DETAIL

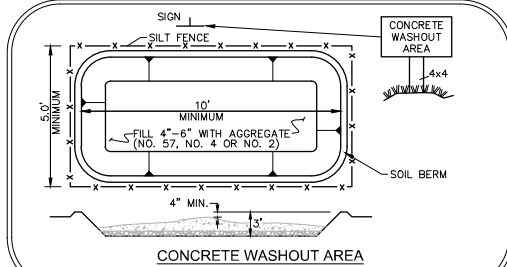NOT TO SCALE



CONCRETE WASHOUT AREA

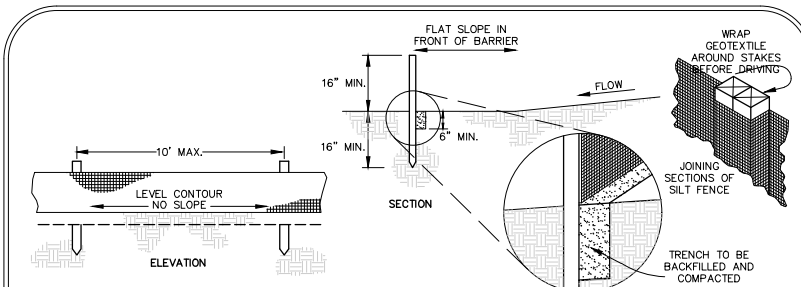THE USE OF PORTABLE CONCRETE WASHOUT UNITS IS APPROVED (AND ENCOURAGED) FOR ALL CONSTRUCTION AREAS IN THE CITY OF COLUMBUS.



- SILT FENCE SHALL BE CONSTRUCTED BEFORE UPSLOPE LAND DISTURBANCE BEGINS.
- ALL SILT FENCE SHALL BE PLACED AS CLOSE TO THE CONTOUR AS POSSIBLE SO THAT WATER WILL NOT CONCENTRATE AT LOW POINTS IN THE FENCE AND SO THAT SMALL SWALES OR DEPRESSIONS THAT MAY CARRY SMALL CONCENTRATED FLOWS TO THE SILT FENCE ARE DISSIPATED ALONG ITS LENGTH.
- ENDS OF THE SILT FENCES SHALL BE BROUGHT UPSLOPE SLIGHTLY SO THAT WATER PONDED BY THE SILT FENCE WILL BE PREVENTED FROM FLOWING AROUND THE ENDS.
- SILT FENCE SHALL BE PLACED ON THE FLATTEST AREA AVAILABLE.
- WHERE POSSIBLE, VEGETATION SHALL BE PRESERVED FOR 5 FEET (OR AS MUCH AS POSSIBLE) UPSLOPE FROM THE SILT FENCE. IF VEGETATION IS REMOVED, IT SHALL BE REESTABLISHED WITHIN 7 DAYS FROM THE INSTALLATION OF THE SILT FENCE.
- THE HEIGHT OF THE SILT FENCE SHALL BE A MINIMUM OF 16 INCHES ABOVE THE ORIGINAL GROUND SURFACE.
- THE SILT FENCE SHALL BE PLACED IN AN EXCAVATED OR SLICED TRENCH CUT A MINIMUM OF 6 INCHES DEEP. THE TRENCH SHALL BE MADE WITH A TRENCHER, CABLE LAYING MACHINE, SLICING MACHINE, OR OTHER SUITABLE DEVICE THAT WILL ENSURE AN ADEQUATELY UNIFORM TRENCH DEPTH.
- THE SILT FENCE SHALL BE PLACED WITH THE STAKES ON THE DOWNSLOPE SIDE OF THE GEOTEXTILE. A MINIMUM OF 8 INCHES OF GEOTEXTILE MUST BE BELOW THE GROUND SURFACE. EXCESS MATERIAL SHALL LAY ON THE BOTTOM OF THE 6-INCH DEEP TRENCH. THE TRENCH SHALL BE BACKFILLED AND COMPACTED ON BOTH SIDES OF THE FABRIC.
- SEAMS BETWEEN SECTIONS OF SILT FENCE SHALL BE SPLICED TOGETHER ONLY AT A SUPPORT POST WITH A MINIMUM 6-IN. OVERLAP PRIOR TO DRIVING INTO THE GROUND, (SEE DETAILS).
- MAINTENANCE-SILT FENCE SHALL ALLOW RUNOFF TO PASS ONLY AS DIFFUSE FLOW THROUGH THE GEOTEXTILE. IF RUNOFF OVERTOPS THE SILT FENCE, FLOWS UNDER THE FABRIC OR AROUND THE FENCE ENDS, OR IN ANY OTHER WAY ALLOWS A CONCENTRATED FLOW DISCHARGE, ONE OF THE FOLLOWING SHALL BE PERFORMED, AS APPROPRIATE: 1)THE LAYOUT OF THE SILT FENCE SHALL BE CHANGED, 2)ACCUMULATED SEDIMENT SHALL BE REMOVED, OR 3)OTHER PRACTICES SHALL BE INSTALLED.

SEDIMENT DEPOSITS SHALL BE ROUTINELY REMOVED WHEN THE DEPOSIT REACHES APPROXIMATELY ONE-HALF OF THE HEIGHT OF THE SILT FENCE.

SILT FENCES SHALL BE INSPECTED AFTER EACH RAINFALL AND AT LEAST DAILY DURING A PROLONGED RAINFALL. THE LOCATION OF EXISTING SILT FENCE SHALL BE REVIEWED DAILY TO ENSURE ITS PROPER LOCATION AND EFFECTIVENESS. IF DAMAGED, THE SILT FENCE SHALL BE REPAIRED IMMEDIATELY.


CRITERIA FOR SILT FENCE MATERIALS

FABRIC PROPERTIES	VALUES	TEST METHOD
Minimum Tensile Strength	120 lbs. (535 N)	ASTM D 4632
Maximum Elongation at 60 lbs	50%	ASTM D 4632
Minimum Puncture Strength	50 lbs (220 N)	ASTM D 4633
Minimum Tear Strength	40 lbs (180 N)	ASTM D 4633
Apparent Opening Size	0.84 mm	ASTM D 4751
Minimum Permeability	1X10-2 sec-1	ASTM D 4491
UV Exposure Strength Retention	70%	ASTM D 4355

* NOTE: THE USE OF STRAW WATTLES HAS PROVEN TO BE A VERSATILE AND EFFECTIVE ESO BMP, ESPECIALLY IN RESIDENTIAL SETTINGS. STRAW WATTLES MAY BE SUBSTITUTED FOR SILT FENCE IN LINEAR INSTALLATIONS. ADDITIONALLY, THE USE OF COMPOST FILTER SOCKS AND COMPOST BLANKETS ARE GAINING WIDER ACCEPTANCE NATIONWIDE. THEY ARE NOW APPROVED FOR USE ON ALL COLUMBUS SWP3 PLANS AND CONSTRUCTION SITES

SILT FENCE

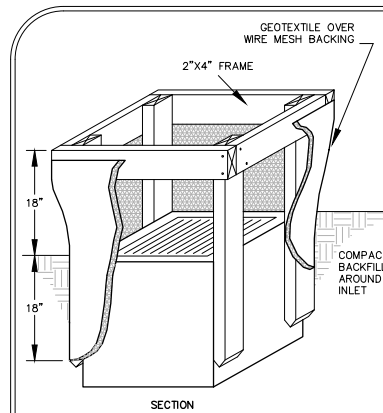N.T.S.



NOTE:
VERTICAL INLET PROTECTION TO BE USED WHERE POSSIBLE AND ALWAYS IN AREAS TO BE GRASSED.

FILTER FABRIC INLET PROTECTION

N.T.S.


- INLET PROTECTION SHALL BE CONSTRUCTED EITHER BEFORE UPSLOPE LAND DISTURBANCE BEGINS OR BEFORE THE INLET BECOMES FUNCTIONAL.
- THE EARTH AROUND THE INLET SHALL BE EXCAVATED COMPLETELY TO A DEPTH AT LEAST 18 INCHES.
- THE WOODEN FRAME SHALL BE CONSTRUCTED OF 2-INCH BY 4-INCH CONSTRUCTION GRADE LUMBER. THE 2-INCH BY 4-INCH POSTS SHALL BE DRIVEN ONE (1) FT. INTO THE GROUND AT FOUR CORNERS OF THE INLET AND THE TOP PORTION OF 2-INCH BY 4-INCH FRAME ASSEMBLED USING THE OVERLAP JOINT SHOWN. THE TOP OF THE FRAME SHALL BE AT LEAST 6 INCHES BELOW ADJACENT ROADS. IF PONDED WATER WILL POSE A SAFETY HAZARD TO TRAFFIC.
- WIRE MESH SHALL BE OF SUFFICIENT STRENGTH TO SUPPORT FABRIC WITH WATER FULLY IMPOUNDED AGAINST IT. IT SHALL BE STRETCHED TIGHTLY AROUND THE FRAME AND FASTENED SECURELY TO THE FRAME.
- GEOTEXTILE MATERIAL SHALL HAVE AN EQUIVALENT OPENING SIZE OF 20-40 Sieve AND BE RESISTANT TO SUNLIGHT. IT SHALL BE STRETCHED TIGHTLY AROUND THE FRAME AND FASTENED SECURELY. IT SHALL EXTEND FROM THE TOP OF THE FRAME TO 18 INCHES BELOW THE INLET NOTCH ELEVATION. THE GEOTEXTILE SHALL OVERLAP ACROSS ONE SIDE OF THE INLET SO THE ENDS OF THE CLOTH ARE NOT FASTENED TO THE SAME POST.
- BACKFILL SHALL BE PLACED AROUND THE INLET IN COMPACTED 6-INCH LAYERS UNTIL THE EARTH IS EVEN WITH NOTCH ELEVATION ON ENDS AND TOP ELEVATION ON SIDES.
- A COMPACTED EARTH DIKE OR CHECK DAM SHALL BE CONSTRUCTED IN THE DITCH LINE BELOW THE INLET IF THE INLET IS NOT IN A DEPRESSION. THE TOP OF THE DIKE SHALL BE AT LEAST 6 INCHES HIGHER THAN THE TOP OF THE FRAME.

DESCRIPTION	BY	DATE	NO.
1160 DUBLIN ROAD SUITE 100 COLUMBUS OH 43215 TEL: 614.441.4222 FAX: 614.441.4222			
PROJECT NO: E120022	10/04/19	MS	SEF
DRAWN BY:			
CHECKED BY:			
PREPARED FOR:	EQUITY CONSTRUCTION SOLUTIONS		
SITE IMPROVEMENT PLAN	POWELL OFFICE CONDOMINIUMS		
STORM WATER POLLUTION PREVENTION DETAILS			
13	15		


8930 LIBERTY ROAD POWELL, OHIO 43065

4653 TRUDMAN BLVD., SUITE 100
HILLIARD, OH 43026

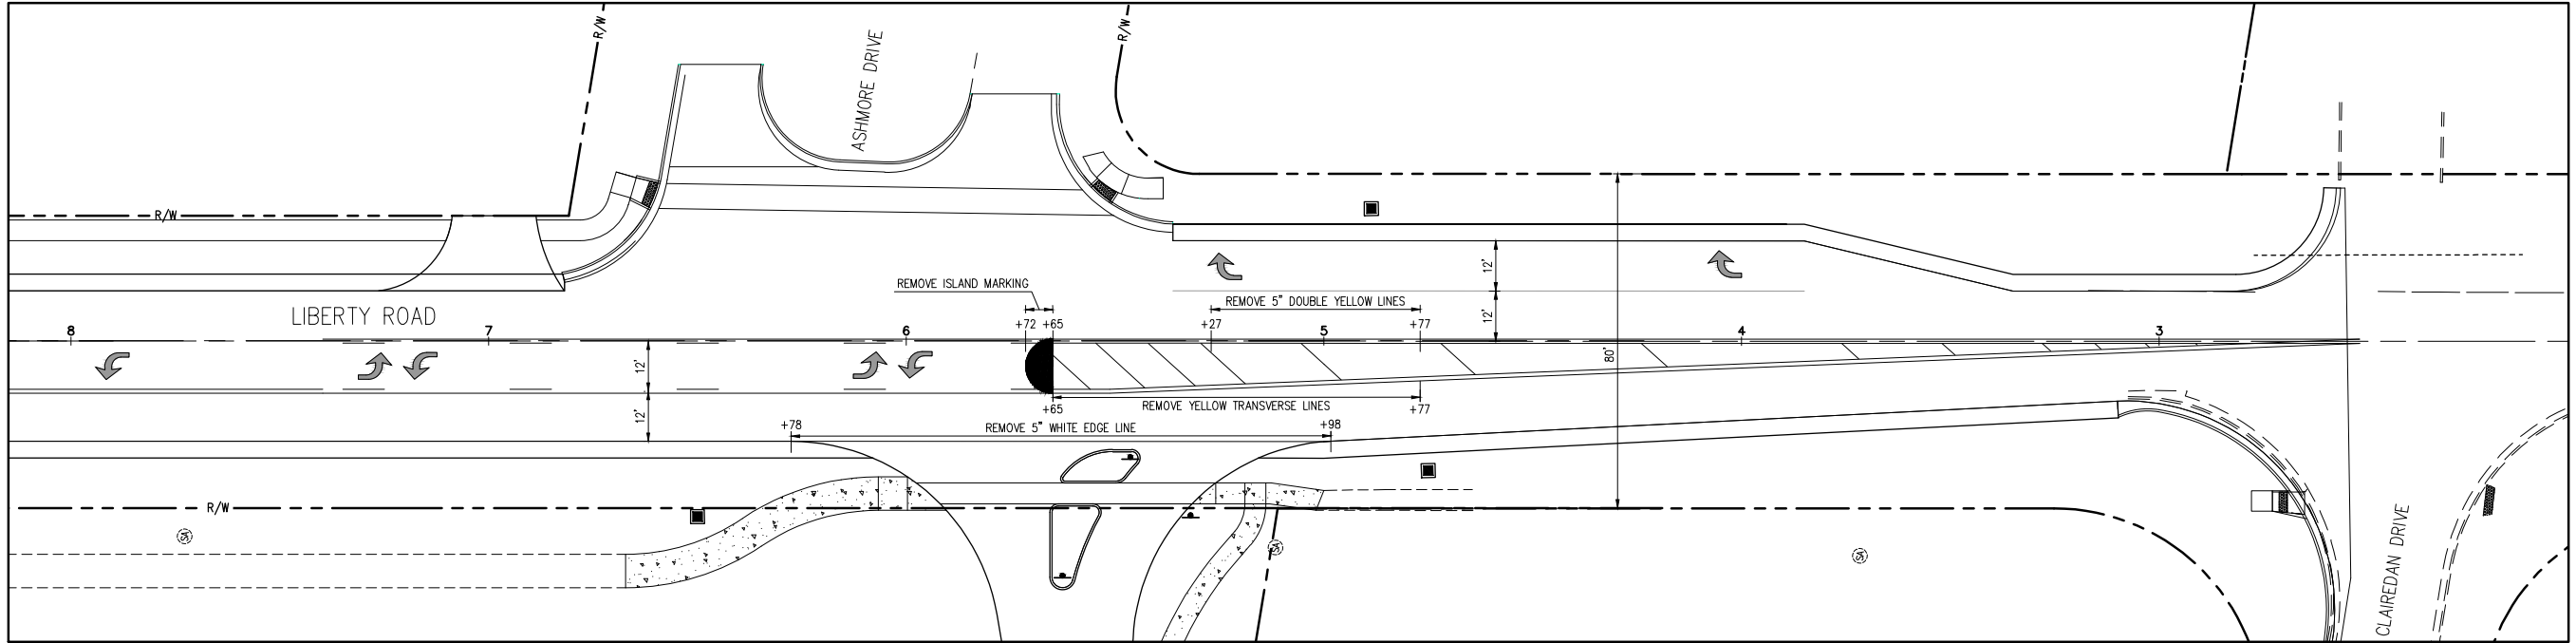
www.manniksmithgroup.com




LIBERTY ROAD DEMO PAVEMENT MARKING PLAN

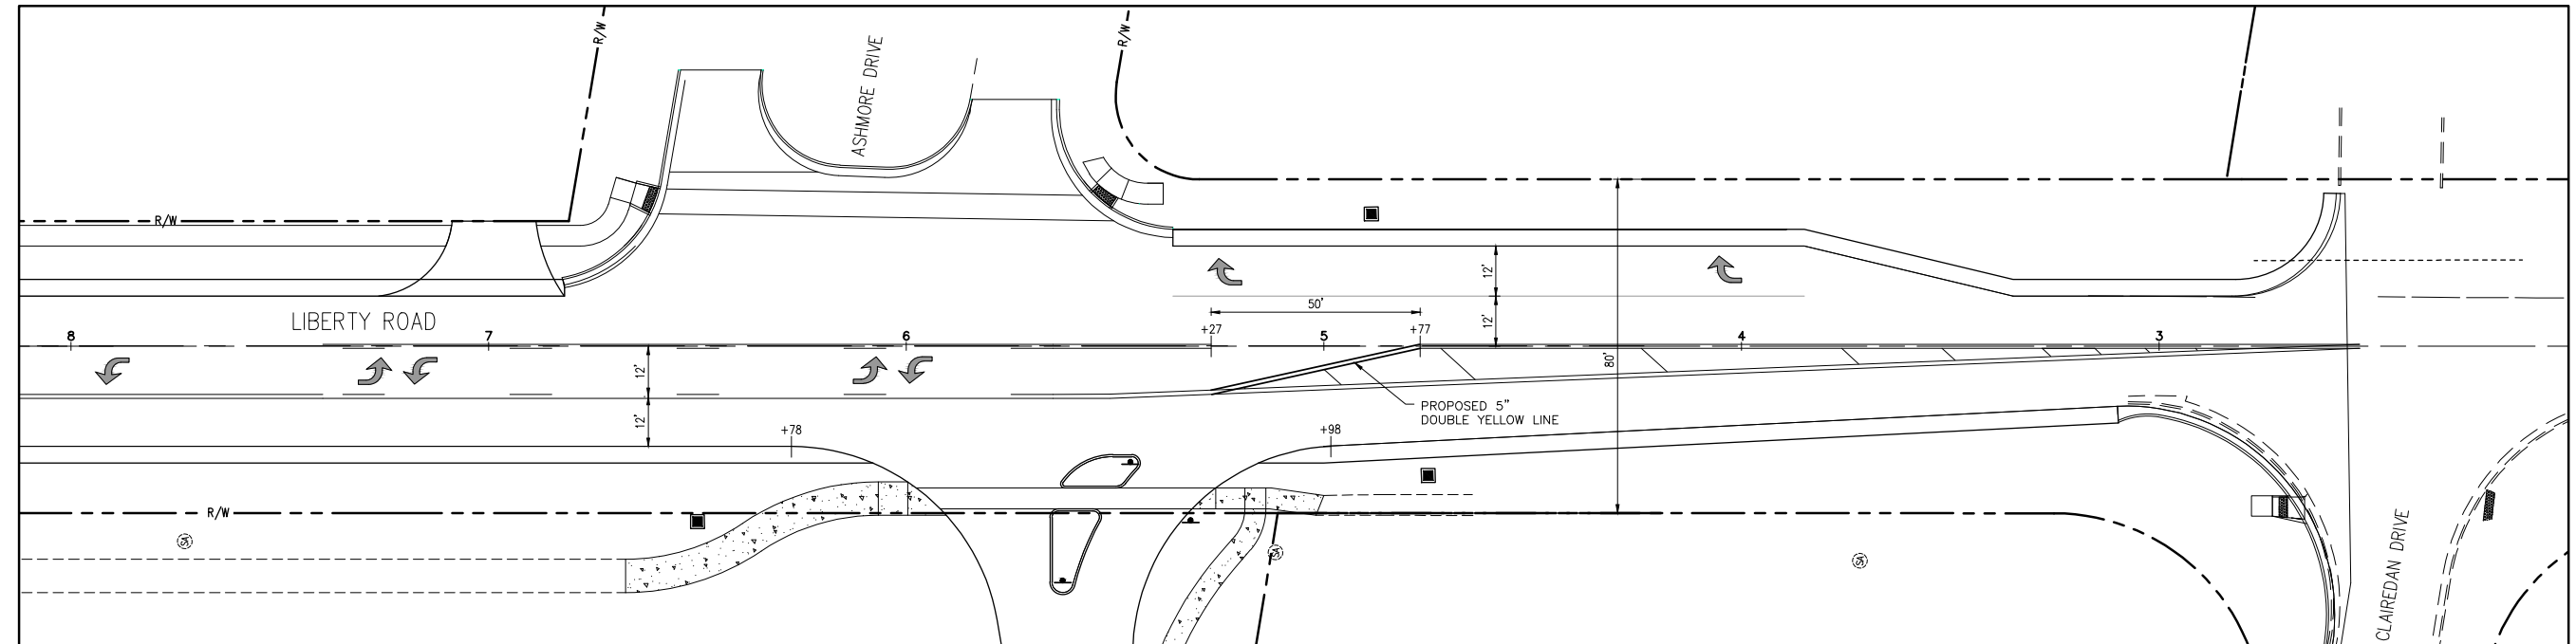

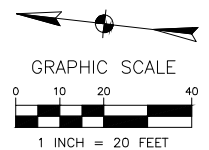LIBERTY ROAD PROPOSED PAVEMENT MARKING PLAN



14	PAVEMENT MARKING PLAN	8930 LIBERTY ROAD POWELL, OHIO 43065	EQUITY CONSTRUCTION SOLUTIONS 4653 TRUEMAN BLVD., SUITE 100 HILLIARD, OH 43026	 www.manniksmithgroup.com	TECHNICAL SKILL: QUANTITATIVE SKILL:	1160 DUBIN ROAD SUITE 100 COLUMBUS, OH 43215 TEL: 614.441.4222 FAX: 888.486.7340	PROJECT DATE: 10/04/19	PROJECT NO: E1200022	DRAWN BY: MS	CHECKED BY: SEF	NO.	DATE	BY	DESCRIPTION			

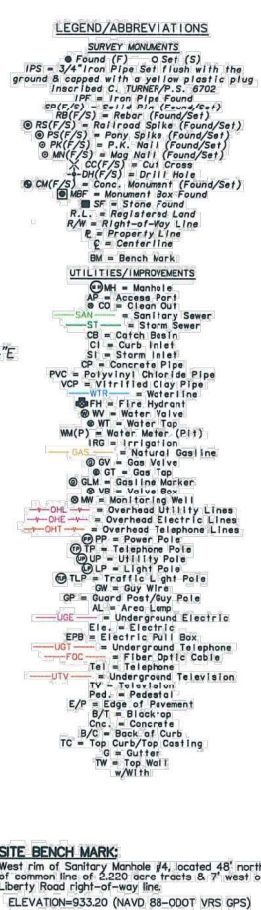


EXHIBIT 1 (South 2.220 Acre Tract)

being in the City of Powell County, Delaware, State of Ohio, located in part of Farm Lot 36, Section 4, Township 3, Range 8, United States Military Lands, being in part of an original 52.018 acre tract conveyed to Louis V. and Doris E. Huffman in Deed Book 342, Page 57, and being more particularly described as follows:

Commencing at a "r" solid iron pin found at the intersection of the centerlines of Liberty Road (North Liberty Street-Corridor Road 9) and Seldom Seen Road (Township Road 12), said iron pin being on the common line between Farm Lots 36 and 37, and being the northeasterly corner of a 1263 acre tract conveyed to the City of Powell in Official Record Volume 105, Page 1495;

Thence, North 07° 39' 40" East, along the centerline of North Liberty Street, being the easterly line of said 1263 acre tract, a distance of 282.80 feet to a point;

Thence, North 82° 17' 09" East, along an existing (South) 52.018 acre tract conveyed to Louis V. and Doris E. Huffman in Deed Book 342, Page 57, being the easterly line of said 52.018 acre tract, a distance of 40.54 feet to an iron pin set on the westerly right-of-way line of North Liberty Street, being a westerly line of said 1263 acre tract, and being the TRUE PLACE OF BEGINNING;

Thence, South 07° 39' 40" East, along said westerly right-of-way line and the westerly line of said 1263 acre tract, a distance of 212.79 feet to an iron pin found at the northeasterly corner of a 0.963 acre tract conveyed to Mark D. Mansfield and Mildred Mansfield in Official Record Volume 29, Page 1945, northeasterly corner of a 0.68 acre tract conveyed to the Village of Powell in Official Record Volume 13, Page 884;

Thence, North 82° 21' 20" West, along the northerly line of said 0.963 acre tract, the northerly line of a 0.887 acre tract conveyed to Sudar Singh and Anjali Singh in Official Record Volume 20, Page 261, and the northerly line of a 0.857 acre tract conveyed to Mark D. Mansfield and Mildred Mansfield in Official Record Volume 29, Page 1945, (passing over iron pins found at 51.20 feet and 31.70 feet), a total distance of 47.72 feet to an iron pin set at the northwest-southeast corner of a 0.68 acre tract conveyed to the Village of Powell in Official Record Volume 13, Page 884;

Thence, North 07° 36' 40" East, along a portion of the easterly line of said 1175 acre tract a distance of 78.54 feet on iron pin set at the northeasterly corner of said 1175 acre tract;

Thence, North 07° 42' 51" East, through said original 52.018 acre tract, a distance of 313.58 feet to an iron pin set;

Thence, South 82° 17' 09" East, continuing through said original 52.018 acre tract, a distance of 442.64 feet, to the TRUE PLACE OF BEGINNING.

Containing 2220 acres, more or less.

Subject, however, to all easements, restrictions and rights-of-way recorded.

The above description is based on and referenced to a Plat of Survey entitled "Plat of a Three Lot Split for Louis V. and Doris E. Huffman" dated May 9, 1984, and recorded in Official Record Volume 29, Page 1945.

All references are to records at the Recorder's Office, Delaware County, Ohio.

All iron pin set are 5/8" diameter iron pins with yellow plastic caps stamped "Shuts & Assoc."

The bearing system is based on the centerline of Chardon Drive, (North 82° 21' 20" West) as recited on the plat of John D. West Commerce Park, Section No. 2, in Plat Cabinet 1, Sides 542 and 542-A.

In addition to the above described 2220 acre tract, the Grantor heretofore reserves a Common Access Easement between said 2220 acre tract and the adjoining (North) 2220 acre tract as shown on said Plat of Survey.

EXHIBIT 2 (North 2220 Acre Tract)

Situated in the City of Powell County, Delaware, State of Ohio, located in part of Farm Lot 36, Section 4, Township 3, Range 8, United States Military Lands, being in part of an original 52.018 acre tract conveyed to Louis V. and Doris E. Huffman in Deed Book 342, Page 57, and being more particularly described as follows:

Commencing at a "r" solid iron pin found at the intersection of the centerlines of Liberty Road (North Liberty Street-Corridor Road 9) and Seldom Seen Road (Township Road 12), said iron pin being on the common line between Farm Lots 36 and 37, and being the northeasterly corner of a 1263 acre tract conveyed to the City of Powell in Official Record Volume 105, Page 1495;

Thence, North 82° 17' 09" East, along the centerline of Seldom Seen Road, said Farm Lot Line and the northerly line of said 1263 acre tract, a distance of 43.71 feet to a point;

Thence, South 07° 42' 51" West, a distance of 50.00 feet to an iron pin set on the southerly right-of-way of Seldom Seen Road being the southerly line of said 1263 acre tract, and being the TRUE PLACE OF BEGINNING;

Thence, South 82° 17' 09" East, along the southerly right-of-way of Seldom Seen Road, being a southerly line of said 1263 acre tract, a distance of 43.71 feet to an iron pin set;

Thence, continuing along a line of said 1263 acre tract and along the arc of a curve to the right, having a chord bearing of 80° 37' 29", a radius of 50.00 feet, an arc length of 70.36 feet, a chord of 64.70 feet, and a chord deflection angle of 80° 37' 29", to an iron pin found on the westerly right-of-way line of Liberty Street, being a westerly line of said 1263 acre tract;

Thence, South 07° 39' 40" East, along the westerly right-of-way line of Liberty Street, being a westerly line of said 1263 acre tract, a distance of 189.70 feet to an iron pin set;

Thence, North 82° 17' 09" East, through said original 52.018 acre tract, a distance of 442.64 feet to an iron pin set;

Thence, North 07° 42' 51" East, continuing through said original 52.018 acre tract, a distance of 229.02 feet to the TRUE PLACE OF BEGINNING.

Containing 2220 acres, more or less.

Subject, however, to all easements, restrictions and rights-of-way recorded.

The above description is based on and referenced to a Plat of Survey entitled "Plat of a Three Lot Split for Louis V. and Doris E. Huffman" dated May 9, 1984, and recorded in Official Record Volume 29, Page 1945.

All references are to records at the Recorder's Office, Delaware County, Ohio.

All iron pin set are 5/8" diameter iron pins with yellow plastic caps stamped "Shuts & Assoc."

The bearing system is based on the centerline of Chardon Drive, (North 82° 21' 20" West) as recited on the plat of John D. West Commerce Park, Section No. 2, in Plat Cabinet 1, Sides 542 and 542-A.

In addition to the above described 2220 acre tract, the Grantor heretofore reserves a Common Access Easement between said 2220 acre tract and the adjoining (South) 2220 acre tract as shown on said Plat of Survey.

LIBERTY RD - Viewing East to West

SELDOM SEEN RD - Viewing North to South

NOTE "A" – EXPLANATION OF SURVEY:
This plot represents an ALTA/ACSM Land Title Survey made in compliance with the requirements of, and for the sole, exclusive and collective use of the parties named herein. The survey was made for the purpose of defining the boundaries of the parties' interest and the information shown herein is restricted to the parties named herein. This survey is not transferable and is invalid without an original signature and embossed over blue ink seal.

NOTE "B" – BASIS OF BEARINGS:
Bearings are referenced to that meridian used in the deed of the subject property, which is a 4°56'12" clockwise rotation from Grid North of the Ohio State Plane Coordinate System, as determined by GPS observations.

NOTE "C" – TITLE COMMITMENT/POLICY EASEMENTS:
No investigation of the public records as to recorded easements, restrictions or other encumbrances was made by us in connection with this survey. This survey is subject to all recorded liens, mortgages, easements, restrictions, covenants, building setbacks, taxes or special assessments, or other matters, if any, which would be discovered by a title search of the public records. No warranty is made by us. We were provided a copy of Old Public Title Insurance Company Commitment No. 003679, describing an effective date of October 24, 2014, which in schedule B-1 lists the "following items":

- Items 1-6, 8 and 7(a)-(7) & 8-(7)-(9), Inclusive, see commitment & related documents
- Item 7(a), OR 105, P.1464 & 1469; Building Setback Lines-Applicable as shown.
- Item 7(a), OR 105, P.1465 & 1469; Access Easement-Applicable as shown.
- Item 7(a), B.361, P.861, 862 & 863; Old Waterline Easement-Apparently lies within current Liberty Road Right-of-Way (R/W)-N/A (Not Applicable).
- Item 7(a), D.600, P.636 & 637; Electric Easement-Applicable as shown.
- Item 7(a), D.635, P.668; Old Waterline Easement-Applicable as shown.
- Item 7(a), D.652, P.717; Electric Easement-Apparently lies within current Liberty Road R/W-N/A.
- Item 7(a), D.652, P.649; 101 Electric Easement along northerly line of north 2220 acre tract-Applicable as shown.
- Item 7(a), D.652, P.635 & 636; Access Easement-Applicable as shown.
- Item 7(a), D.652, P.728 & 8.175, F.404; Electric Easement of northeast corner north 2220 acre tract-Applicable as shown.
- Item 7(a), D.652, P.635 & 636; Record-Applicable, see document.
- Item 7(a), E.79, P.975, P.2825; Restrictions of Record-Applicable, see document.

Easements Not Listed in Commitment:
Item 7(a), D.1492; Driveway Easement along southerly & westerly lines of south 2220 acre tract-Applicable as shown.
CR134, P.1247; Storm Sewer Easement-Benefits subject properties as shown on adjacent plat.

NOTE "D" – DOCUMENTATION USED:
Subject & adjoining deeds as referenced Surveys acquired from Delaware County's GIS: 19-3-4-052; 19-3-4-055; 19-3-4-077; 19-3-4-380; 19-3-4-480; 19-3-4-059; 19-3-4-060; 19-3-4-061; 19-3-4-312; 19-3-

To Jeffrey T. Milroy; Milroy Properties, LLC; Commerce National Bank; Eagle Land Title Agency, Inc.; and Old Republic Title Insurance Company.

This is to certify that this map or plat and the survey on which it is based were made in accordance with the 2011 Minimum Standard for Land Surveys of the ALTA/ACSM Land Title Survey, jointly established and adopted by ALTA and NSPS, and includes items 1-4, 6(c), 8, 11(a), 13, 14, 16-18 of Table A thereof. The field work was completed on December 8, 2014.

By: Carl E. Turner Jr. 20 December 2014
CARL E. TURNER JR., Professional Surveyor S-6702 Date

NOT AN AUTHORIZED DOCUMENT WITHOUT
EMBOSSMENT OVER BLUE INK SURVEYOR'S SEAL
©2014 TERRA SURVEYING SERVICES, LLC

road
55

30 20 0 30 160
GRAPHIC SCALE: 4"=30'

FIELD SURVEY DATE: 4 & 8 Dec. 2014	FIELD SURVEY BY: CT/VRS/GRS-1	CLIENT PROJECT NO.1: N/A
DRAWING DATE: 20 December 2014	DRAWN BY: C. Turner	TERMS FILE NO: 21PWL 130.14



Illustrative Site Plan
SCALE: 1" = 30'-0"



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PODdesign.net

Project Name
Powell Office Condominiums
8930 Liberty Road
Powell, OH 43065

Prepared For
Powell Office Condominiums
8930 Liberty Road
Powell, Ohio 43065

Project Info
Project # 18097
Date 09/23/19
By SF
Scale As Shown

Revisions

Sheet Title
ILLUSTRATIVE SITE PLAN

Sheet #
L1.0

Powell Office Condominiums

8930 Liberty Road Powell, OH 43065

DATE: September 24, 2019

Final Design Development Landscape Design

PROJECT NO. 18097

SHEET INDEX

L1.0	Final Development Planting Plan
L2.0	Planting Details
L3.0	Final Development Details

PREPARED FOR

Powell Office Condominiums
8930 Liberty Road
Powell, Ohio 43065

PREPARED BY



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LANDSCAPE REQUIREMENTS

REPLACEMENT OF DESTROYED TREES - SECTION 1145.29 (d)(1)			
REQUIRED		PROVIDED	
FOR EVERY TREE REMOVED W/ A TRUNK DIAMETER GREATER THAN 6", PROVIDE NEW TREES WITH A TOTAL TRUNK DIAMETER OF NO LESS THAN 6"		4 TREES x 6" DIA. = 24" DIA. REQUIRED	24" DIA. WITH TREES EACH AT 3" CAL.
MINIMUM REQUIRED TREES - SECTION 1145.30 (a)(2)(C)			
REQUIRED		PROVIDED	
FOR COMMERCIAL STRUCTURES, PROVIDE AT LEAST 71" TOTAL TRUNK DIAMETER WHEN TOTAL AREA FOR ALL STRUCTURES, PARKING & TRASH STORAGE IS BETWEEN 86,001 - 90,000 SF, PLUS 2" OF TRUNK DIAMETER FOR EVERY 4,000 SF OVER 50,000 SF OR FRACTION THEREOF.		35,808 SF BLDGS. + 50,310 SF PRKG. = 86,118 SF = 71" DIA. REQ. ----- (86,118-50,000) = 36,118 SF IN EXCESS 36,118 SF/4000 SF= (9 AREAS) WITH 2" ----- TOTAL DIA= 71" + 18" = 89" DIA. REQ'D	89" DIA. WITH TREES EACH AT 2.5" CAL.
REQUIRED LANDSCAPING OF PARKING AREAS - SECTION 1145.31			
REQUIRED		PROVIDED	
IN ALL PARKING AREAS, PROVIDE ONE UNPAVED PARKING SPACE WITH ONE DECIDUOUS TREE FOR EVERY EIGHT (8) SPACES		145 SPACES = 18 TREES	18 TREES
REQUIRED LANDSCAPING AROUND BUILDING FOUNDATIONS - SECTION 1145.32			
CODE	BUILDING #	REQUIRED	PROVIDED
70% MIN. OF THE BUILDING PERIMETER SHALL BE LANDSCAPED			
		(____ LF BLDG X .70 = LF REQ.)	
	BUILDING 1:	(270 LF BLDG) = 189 LF REQ	MIN. 189 LF
	BUILDING 2:	(280 LF BLDG) = 196 LF REQ.	MIN. 196 LF
	BUILDING 3:	(324 LF BLDG) = 227 LF REQ.	MIN. 227 LF
	BUILDING 4:	(254 LF BLDG) = 178 LF REQ.	MIN. 178 LF
	BUILDING 5:	(328 LF BLDG) = 230 LF REQ.	MIN. 230 LF
	BUILDING 6:	(426 LF BLDG) = 298 LF REQ.	MIN. 298 LF
PROVIDE (5) SHRUBS FOR EVERY 40 LF OF BUILDING PERIMETER			
		(____ LF BLDG / 40 LF) x 5 SHRUBS = SHRUBS REQ.)	
	BUILDING 1:	(270 LF BLDG) = 34 SHRUBS REQ.	34 SHRUBS MIN
	BUILDING 2:	(280 LF BLDG) = 35 SHRUBS REQ.	35 SHRUBS MIN
	BUILDING 3:	(324 LF BLDG) = 40 SHRUBS REQ.	40 SHRUBS MIN
	BUILDING 4:	(254 LF BLDG) = 32 SHRUBS REQ.	32 SHRUBS MIN
	BUILDING 5:	(328 LF BLDG) = 41 SHRUBS REQ.	41 SHRUBS MIN
	BUILDING 6:	(426 LF BLDG) = 53 SHRUBS REQ	53 SHRUBS MIN
PROVIDE (10) PERENNIALS FOR EVERY 40 LF OF BUILDING PERIMETER			
		(____ LF BLDG / 40 LF) x 10 PERENNIALS = PERENNIALS REQ.)	
	BUILDING 1:	(270 LF BLDG) = 64 PERENNIALS REQ	64 PERENNIALS
	BUILDING 2:	(280 LF BLDG) = 70 PERENNIALS REQ.	70 PERENNIALS
	BUILDING 3:	(324 LF BLDG) = 80 PERENNIALS REQ	80 PERENNIALS
	BUILDING 4:	(254 LF BLDG) = 64 PERENNIALS REQ.	63 PERENNIALS
	BUILDING 5:	(328 LF BLDG) = 82 PERENNIALS REQ.	82 PERENNIALS
	BUILDING 6:	(426 LF BLDG) = 106 PERENNIALS REQ	106 PERENNIALS



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Project Name

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Powell, OH 43065

Prepared For

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Powell, Ohio 43065

Project Info

Project # 18097
Date 09/24/19
By SF
Scale As Shown

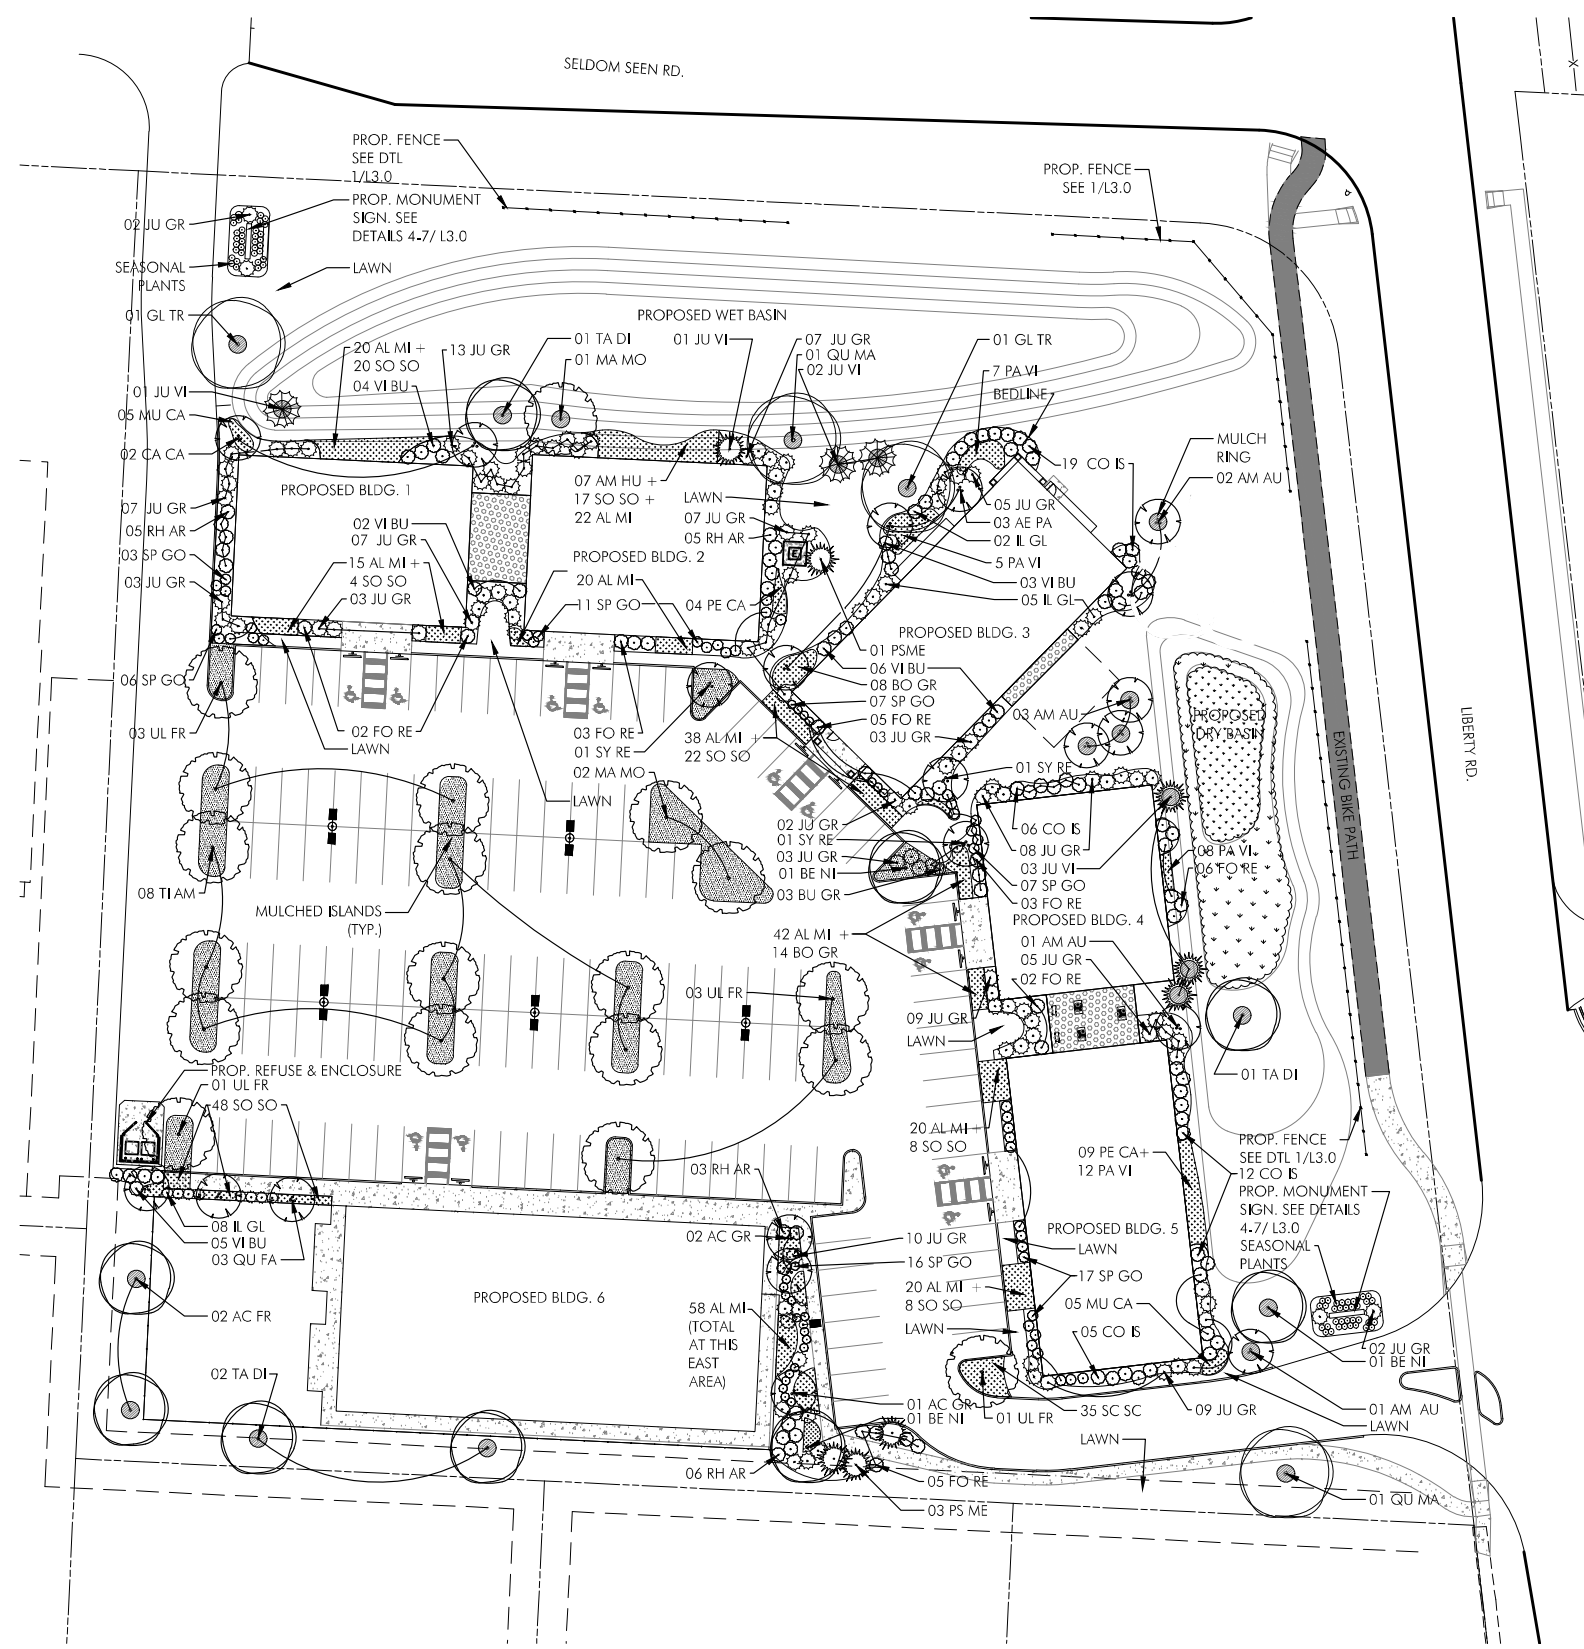
Revisions

Sheet Title

FINAL DEVELOPMENT PLANTING PLAN


Sheet #

L1.0











PLANTING SCHEDULE					
QTY	SYMBOL	BOTANICAL & COMMON NAMES	SIZE	COND	REMARKS
LARGE TREE SPECIMEN, FOR REPLACEMENT					
2	GL TR	Gleditsia t.i. 'Skyline' Skyline Honeylocust	3" Cal.	B&B	AS SHOWN
3	JU VI	Juniperus virginiana 'Burkii' Burk Juniper	3" Height	B&B	AS SHOWN
1	PL OC	Platanus occidentalis American Sycamore	3" Cal.	B&B	AS SHOWN
2	QU MA	Quercus macrocarpa Bur Oak	3" Cal.	B&B	AS SHOWN
LARGE TREES / TREES FOR OPEN GREEN AREAS					
2	AC FR	Acer x f. 'Celebration' Celebration Maple	2.5" Cal.	B&B	AS SHOWN
3	JU VI	Juniperus virginiana 'Burkii' Burk Juniper	6' Height	B&B	AS SHOWN
4	PS ME	Pseudotsuga menziesii Douglasfir	6'	B&B	AS SHOWN
3	TA DI	Taxodium distichum Bald Cypress	2.5" Cal.	B&B	AS SHOWN
SMALL, MEDIUM AND FAST GROWING TREES					
3	AC GR	Acer griseum Paperbark Maple	6' Height	B&B	(3) Min. Heavy Stock Multi-stem
3	AE PA	Aesculus pavia Red Buckeye	6' Height	B&B	(3) Min. Heavy Stock Multi-stem
7	AM AU	Amelanchier 'Autumn Brilliance' Autumn Brilliance Serviceberry	6' Height	B&B	(3) Min. Heavy Stock Multi-stem
4	BE NI	Betula nigra River Birch	7' Height	B&B	(3) Min. Heavy Stock Multi-stem
2	CA CA	Carpinus caroliniana American Hornbeam	2.5" Cal.	B&B	AS SHOWN
3	MA MO	Magnolia v. 'Moonglow' Moonglow Sweetbay Magnolia	7' Height	B&B	(3) Min. Heavy Stock Multi-stem
3	QU FA	Quercus r. 'Fastigiata' Pyramidal English Oak	7' Height	B&B	AS SHOWN
3	SY RE	Syringa reticulata Japanese Tree Lilac	2.5" Cal.	B&B	AS SHOWN
8	UL FR	Ulmus x. 'Frontier' Frontier Elm	2.5" Cal.	B&B	AS SHOWN
8	TI AM	Tilia americana Basswood	2.5" Cal.	B&B	AS SHOWN


QTY	SYMBOL	BOTANICAL & COMMON NAMES	SIZE	COND	REMARKS
SHRUBS					
3	BU GR	Buxus x. 'Green Velvet' Green Velvet Boxwood	18" ht. min.	#3 cont.	3' O.C.
42	CO IS	Cornus s. 'Banti' Banti Dogwood	24" ht. min.	#5 cont.	5' O.C.
24	FO RE	Fothergilla x 'Red Licorice' Red Licorice Fothergilla	24" ht. min.	#3 cont.	4.5' O.C.
15	IL GL	Ilex glabra 'compacta' Compact Inkberry	24" ht.	#5 cont.	4.5' o.c.
95	JU GR	Juniperus v. 'Grey Owl' Grey Owl Juniper	24" min. spread	#3 cont.	6' o.c.
19	RH AR	Rhus aromatica 'Lo Gro' Lo Gro Fragrant sumac	24" min. spread	#3 cont.	5.5' o.c.
67	SP GO	Spiraea 'Goldflame' Goldflame Spirea	24" min. spread	#3 cont.	3' o.c.
20	VIBU	Viburnum x burkwoodii Burkwood Viburnum	24" min. spread	#3 cont.	6' o.c.
PERENNIALS AND NATIVE GRASSES : REFER TO PLANTING PLAN					
7	AM HU	Amsonia hubrichtii Threadleaf Blue Star	1 gal.	Cont.	Min. 2.5' o.c.
255	AL MI	Allium 'Millenium' Millenium Ornamental onion	1 gal.	Cont.	Min. 18" o.c.
22	BO GR	Bouteloua gracilis 'Blonde Ambition' Blonde Ambition blue grama	1 gal.	Cont.	Min. 3' o.c.
10	MU CA	Muhlenbergia reverchonii Undaunted'	1 gal.	Cont.	Min. 3' o.c.
32	PA VI	Panicum virgatum 'Shenandoah' Shenandoah switchgrass	1 gal.	Cont.	Min. 4' o.c.
13	PE CA	Penstemon calycosus Bead Tongue	1 gal.	Cont.	Min. 3' o.c.
35	SC SC	Schizachyrium scoparium Standing Ovation'	1 gal.	Cont.	Min. 18" o.c.
127	SO SO	Solidago x 'Solar Cascade' Solar Cascade Goldenrod	1 gal.	Cont.	Min. 2.5' o.c.
SEED AND SOD MIXES					
SEED MIX TYPE A	TURF: SCOTTS PROVETA KENTUCKY BLUEGRASS CONTACT: CHRISTIAN BALDWIN 937.578.5994		FOLLOW SUPPLIERS INSTALLATION DIRECTIONS FOR OPTIMAL GROWTH	APPLICATION RATE AS PER SUPPLIERS DIRECTIONS	
SEED MIX TYPE B	SPENCE NURSERY 'NET MESC' NATIVE SEED MIX		FOLLOW SUPPLIERS INSTALLATION DIRECTIONS FOR OPTIMAL GROWTH	APPLICATION RATE AS PER SUPPLIERS DIRECTIONS	

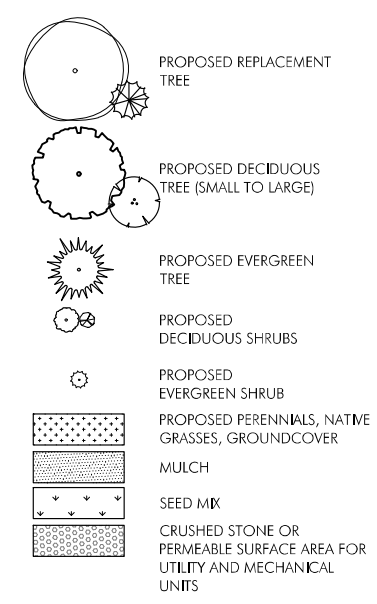


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SCALE: 1" = 30'-0"

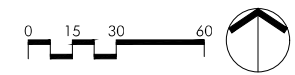

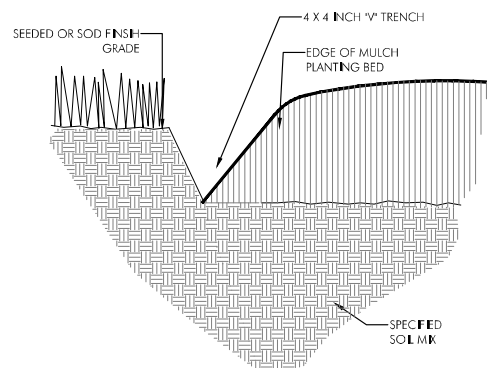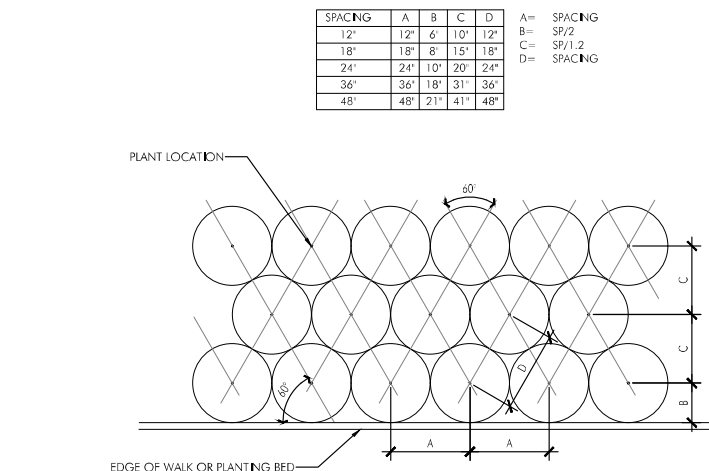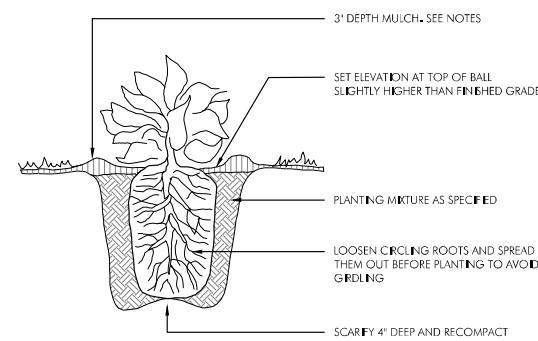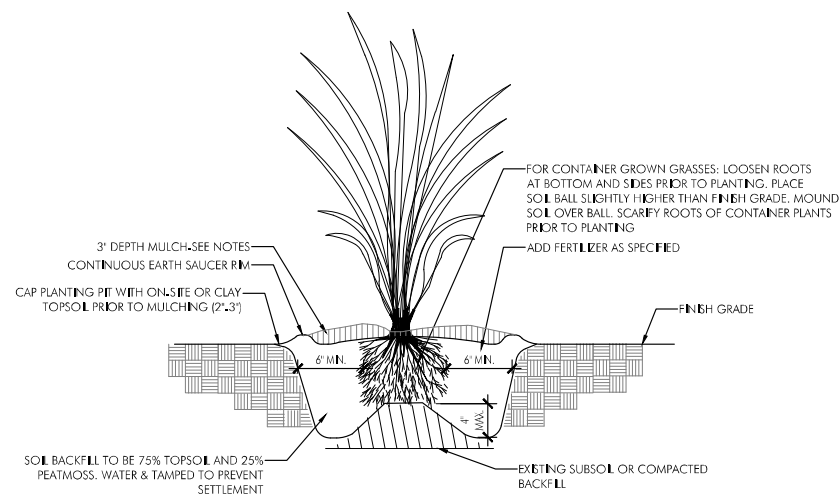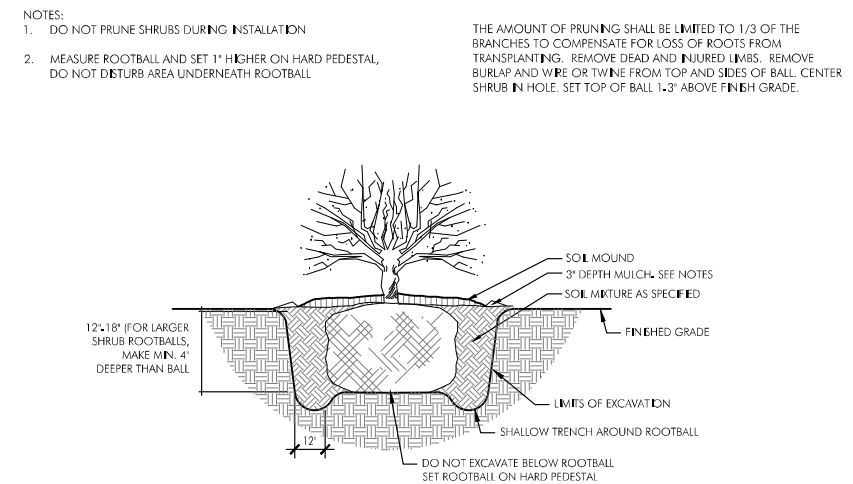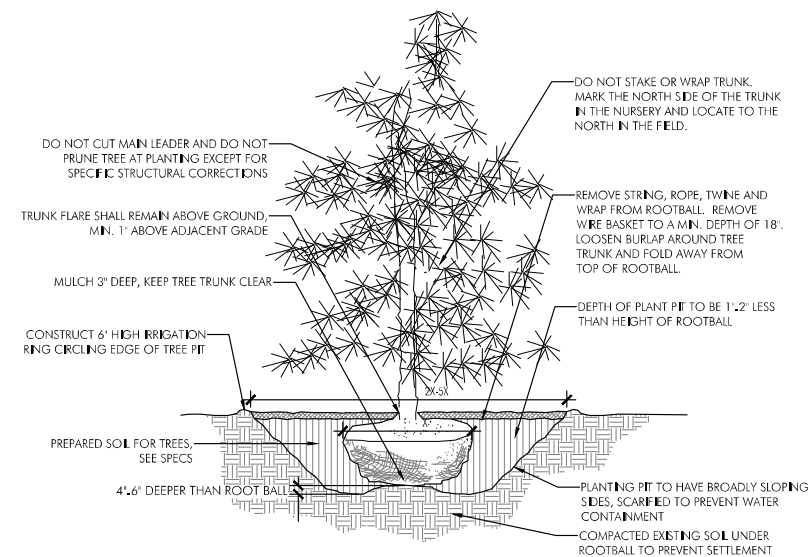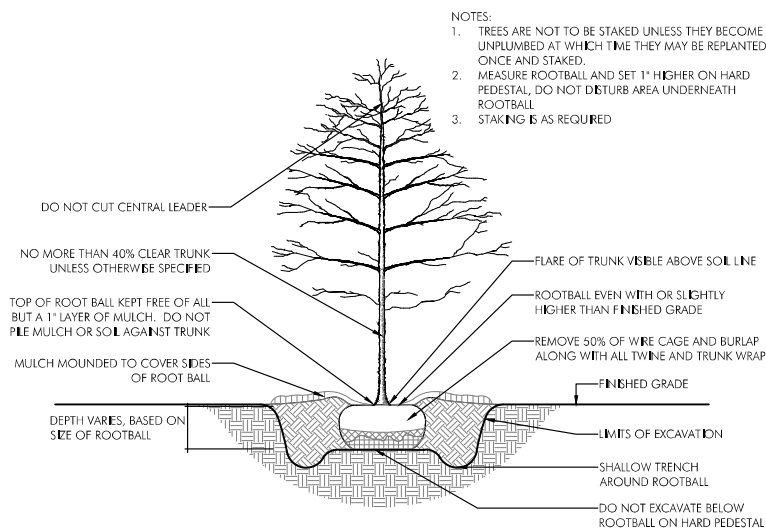


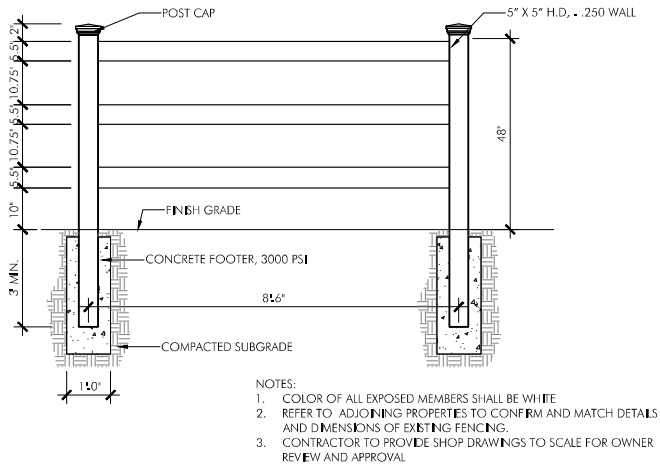

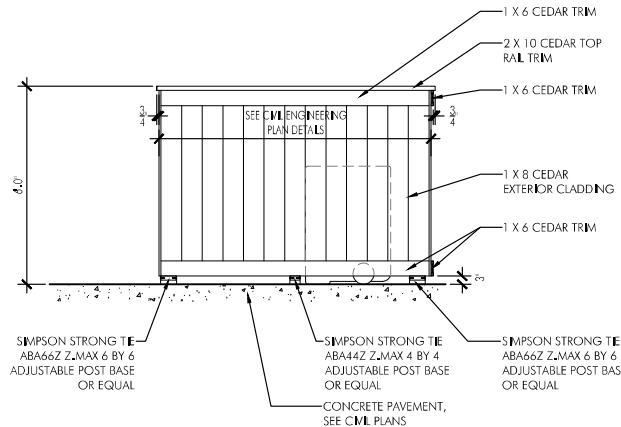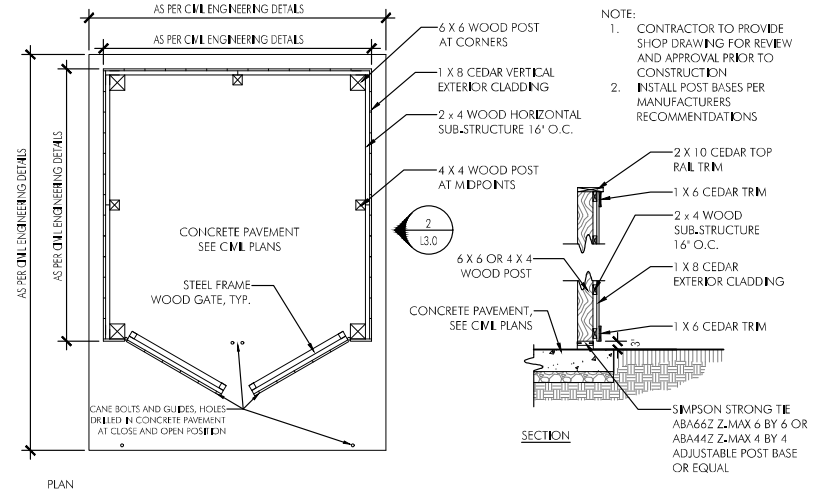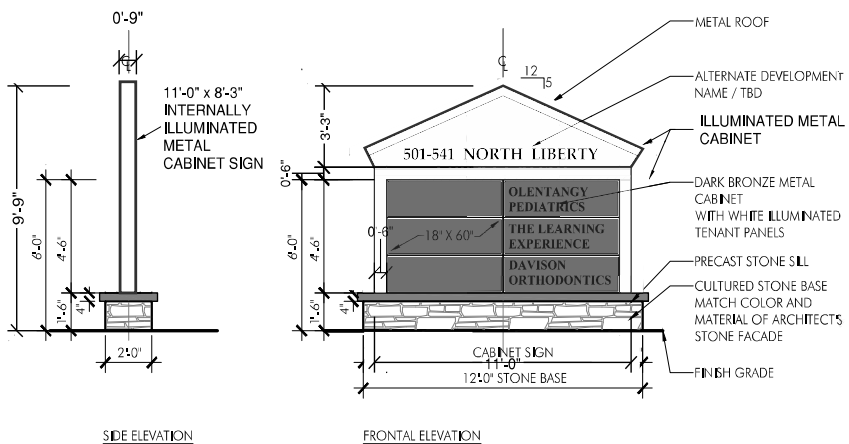
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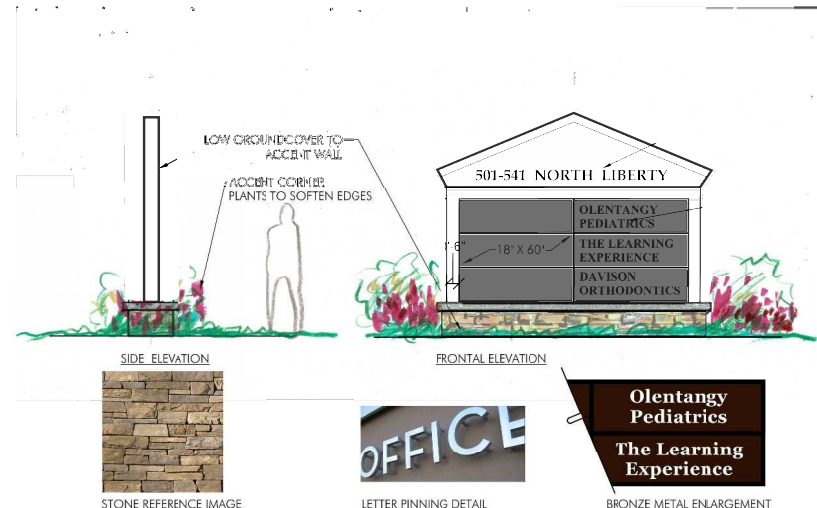
2 6' High Wooden Refuse Enclosure Elevation
3/8"=1'-0"




3 6' High Wooden Refuse Enclosure
3/8"=1'-0"




4 Powell Office Condominium Monument Preliminary Sign
1/4"=1'-0"



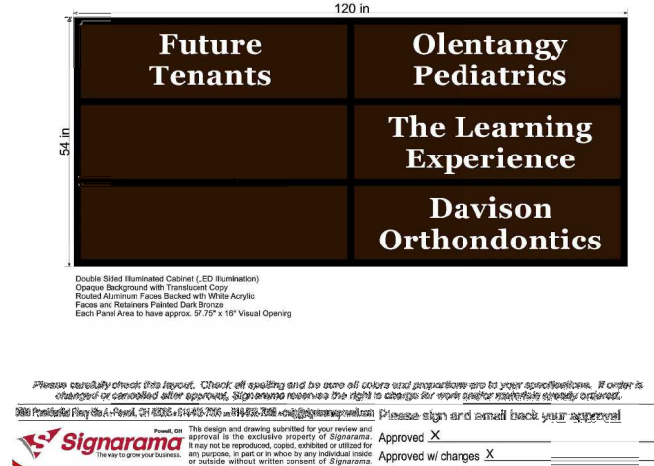5 Powell Office Condominium Monument Preliminary Sign: Rendering
1/4"=1'-0"



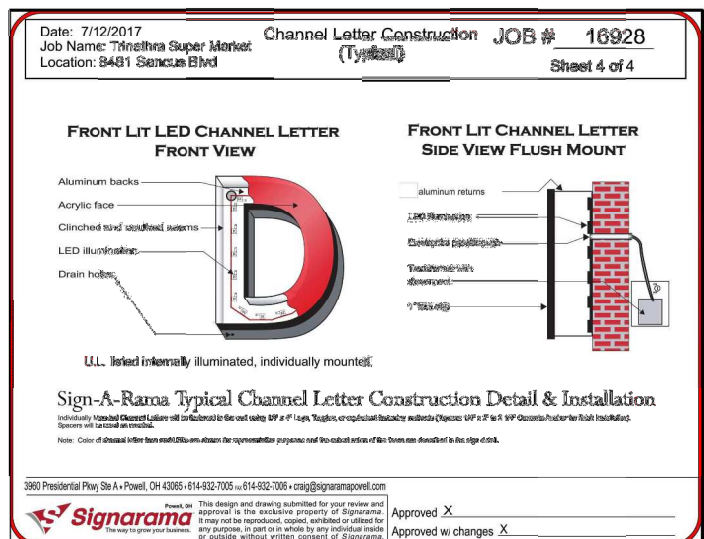6 Powell Office Condominium Monument Preliminary Sign Detail
NTS



7 Powell Office Condominium Monument Preliminary Sign Detail
NTS



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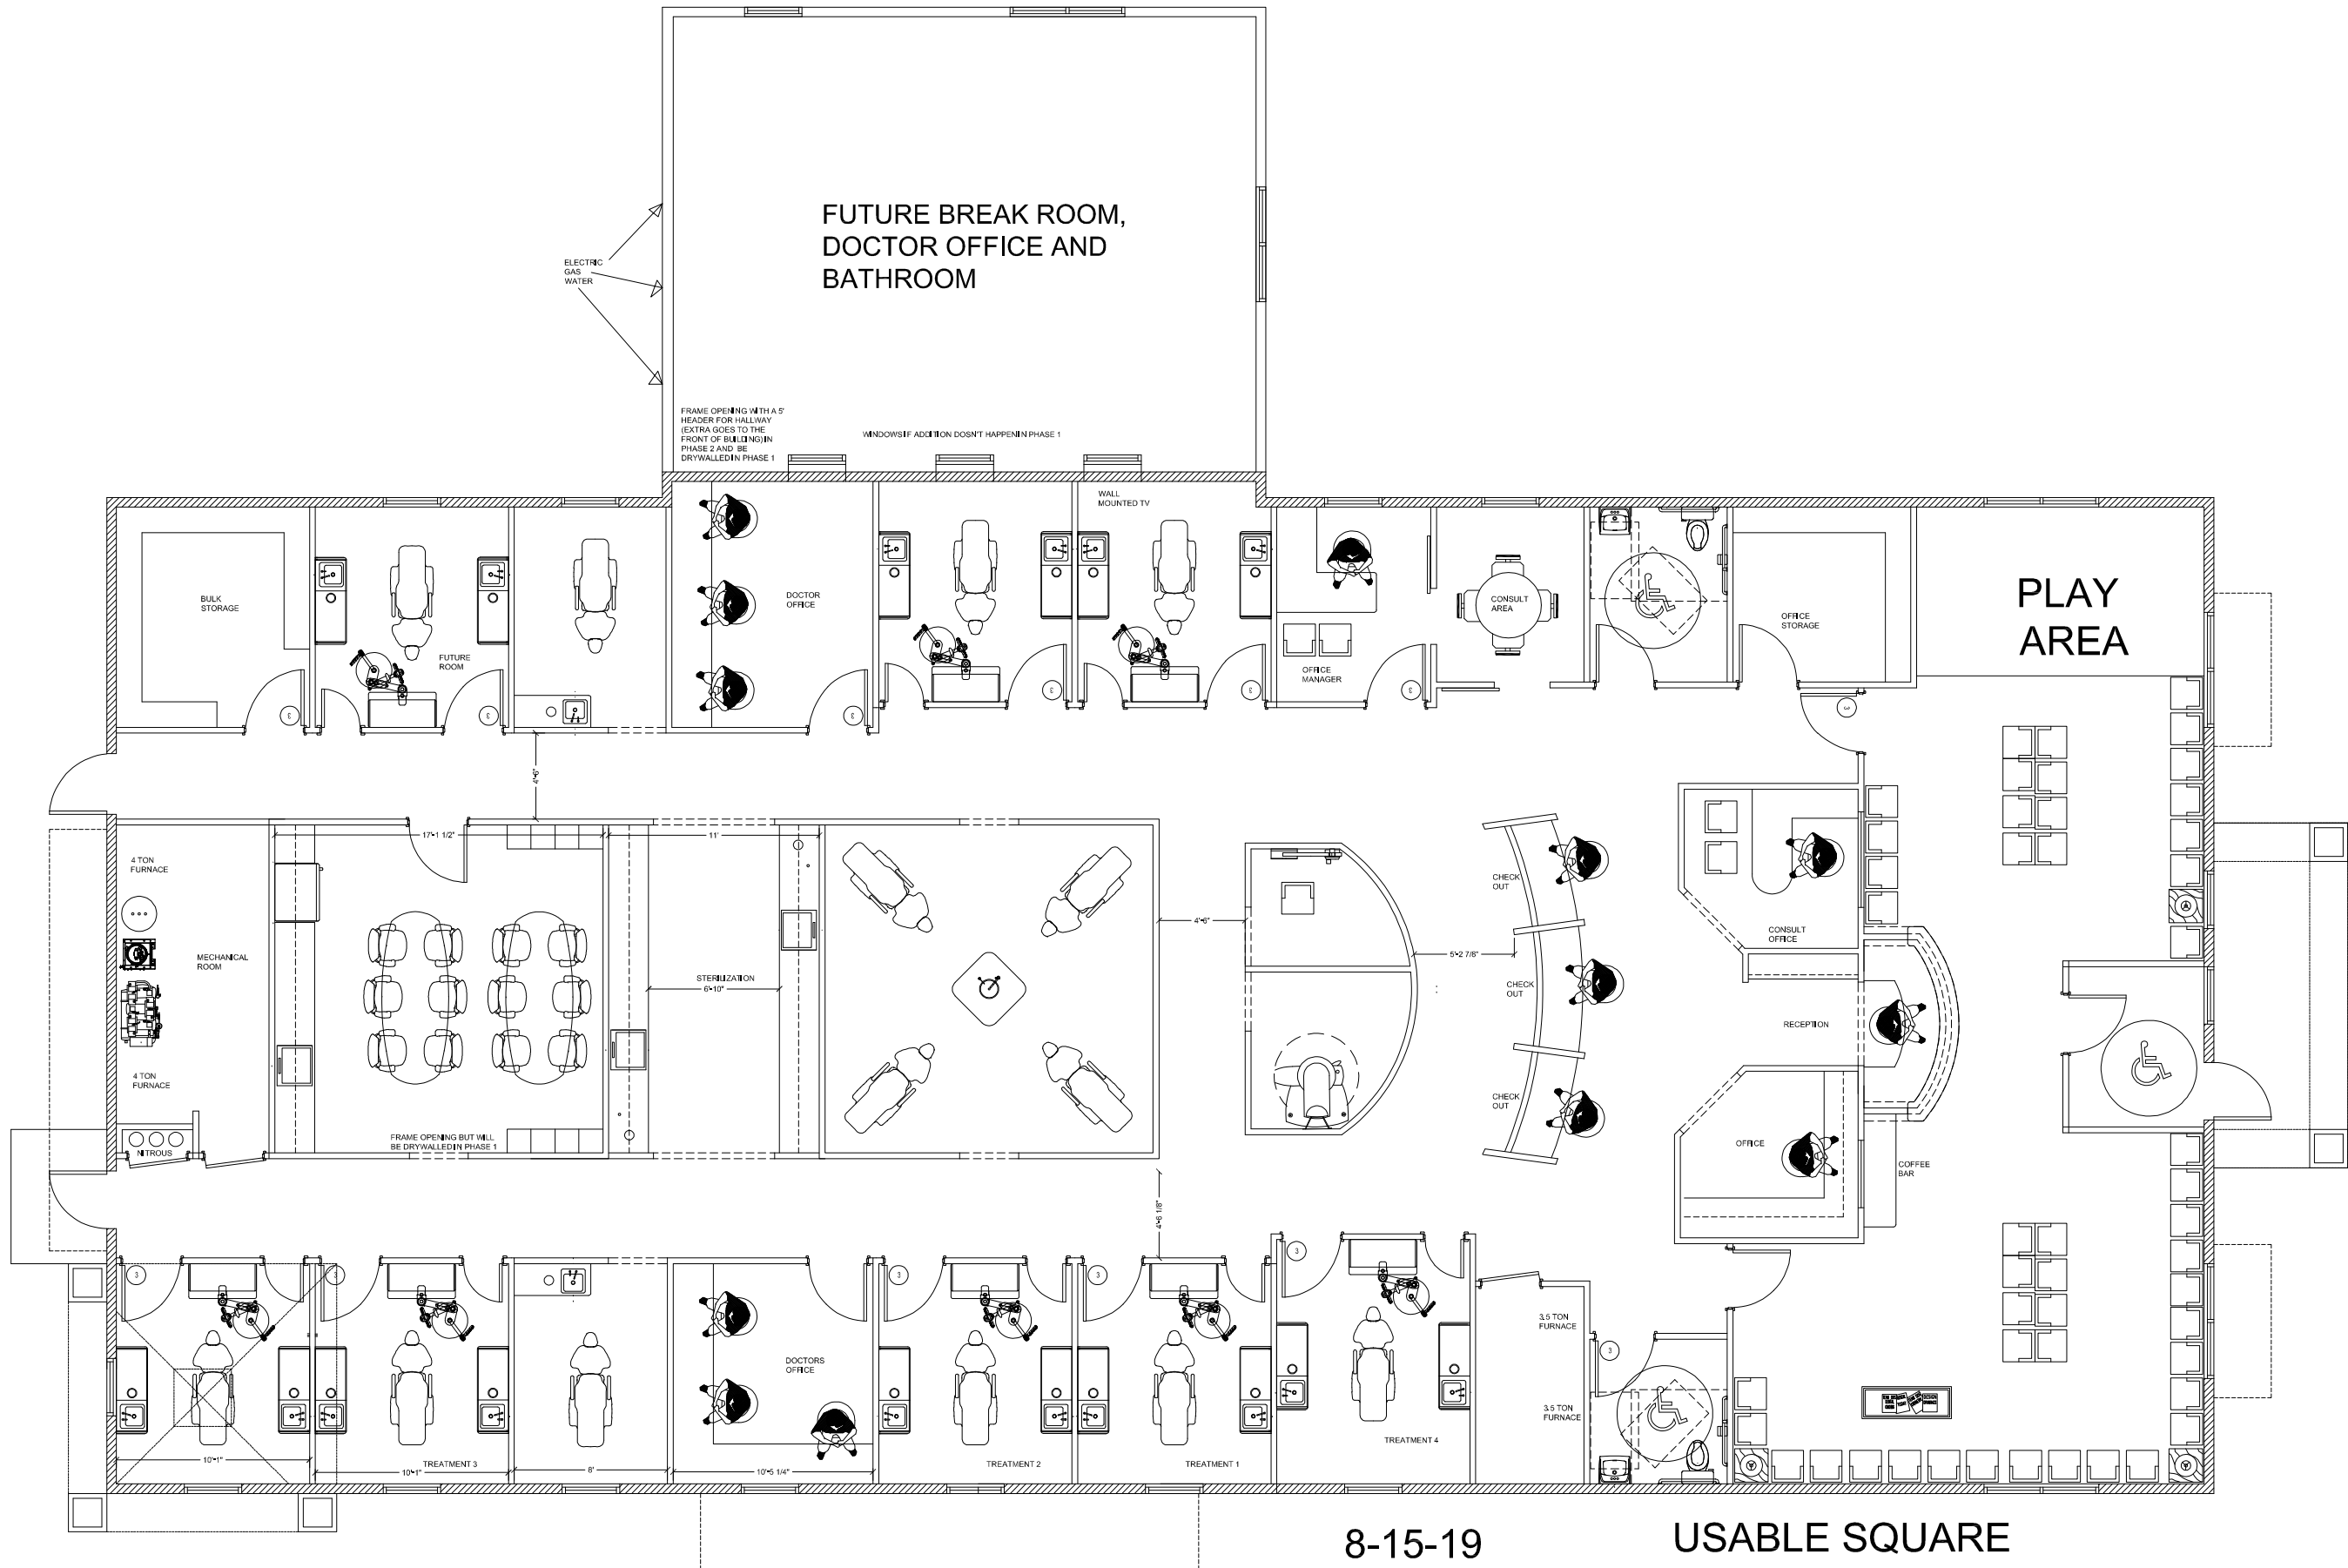
Prepared For
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Project Info
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Revisions

Sheet Title
FINAL DEVELOPMENT DETAILS

Sheet #
L3.0



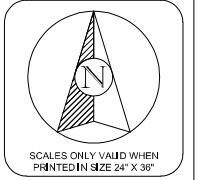
8-15-19

USABLE SQUARE
FEET 5600

1 FIRST FLOOR - FLOOR PLAN
SCALE: 1/4" = 1' on 24"x 36" PAPER

TEAM DDS
7895 DOVE PARKWAY
CANAL WINCHESTER, OHIO 43110
(614) 721-7291
WWW.TEAMDDS.COM

TEAM DDS INC.
BRIAN SOHNER
EMAIL: brian@teamdds.com
FAX: (614) 206-3153
(866) 596-5385
DENTAL EQUIPMENT SUPPLIER
EQUIPMENT SPECIALIST
DENTAL COMPANY




TENANT BUILD OUT/REMODEL FOR PROFESSIONAL OFFICE FACILITIES:
JEFF MILTON DDS
POWELL OHIO

DRAWN BY: SND
CHECKED BY: AJO
TEAM DDS #:
XXXX

RELEASE:
5-9-19

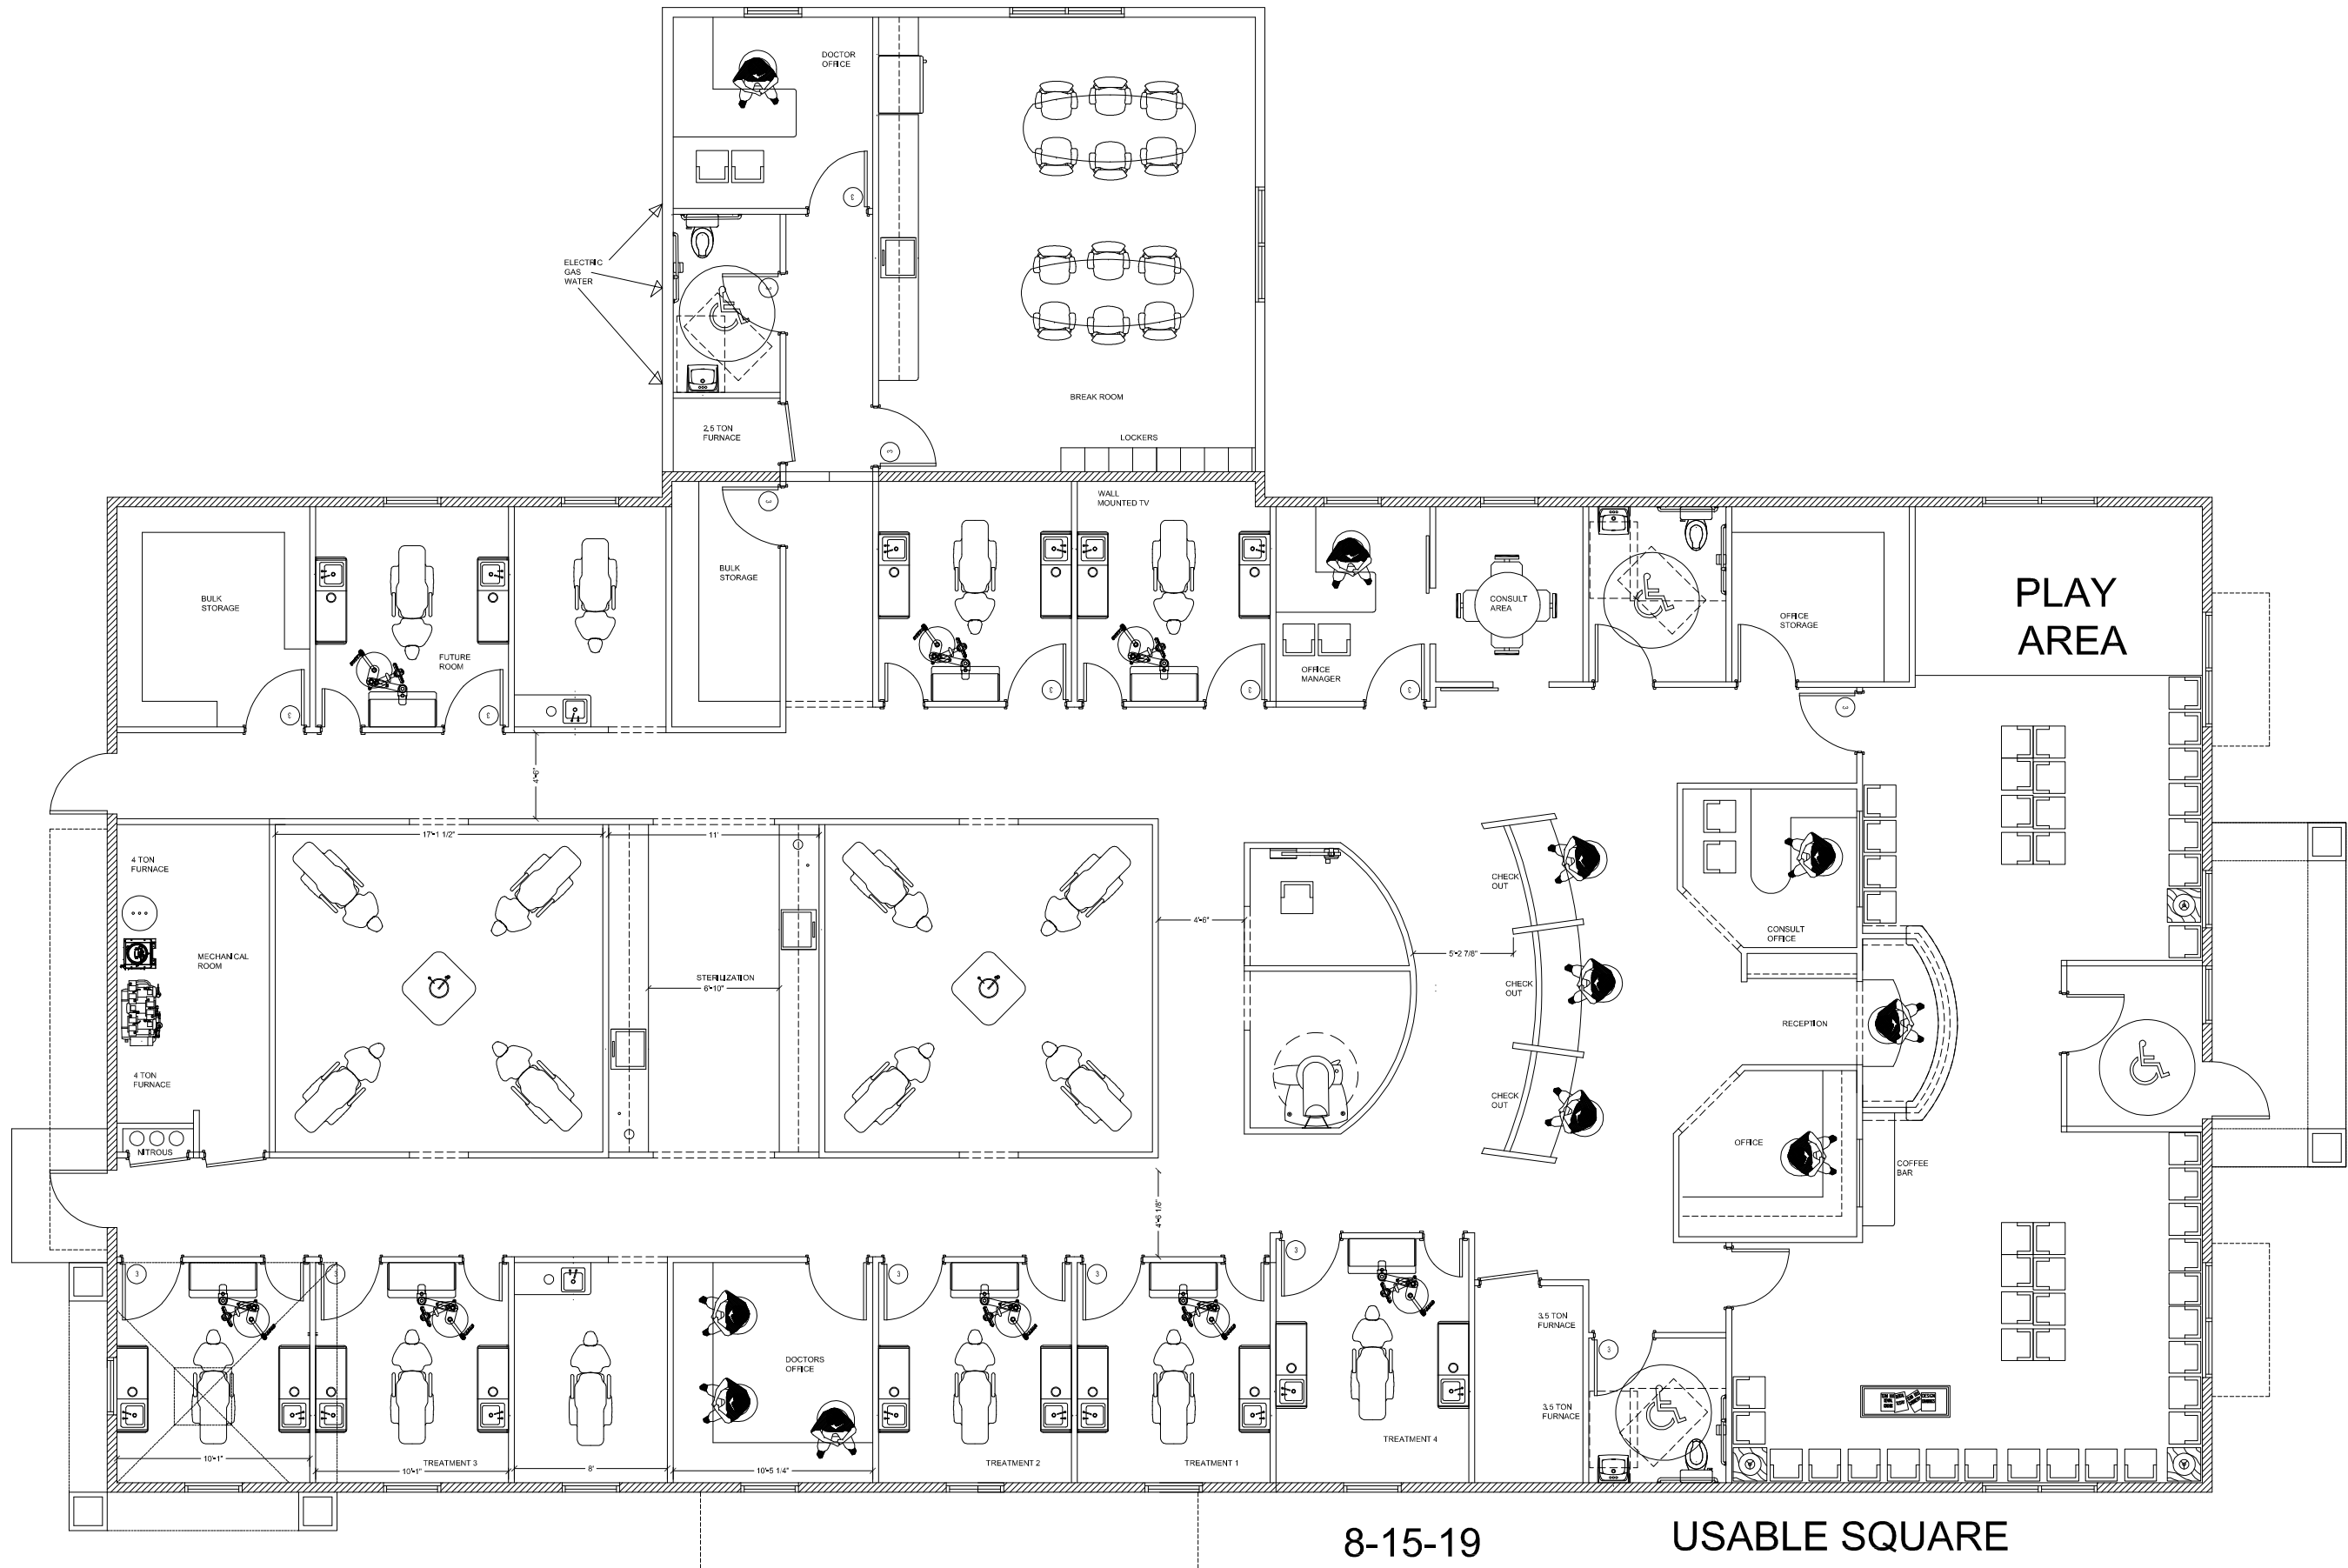A-2
FLOOR PLAN




8-15-19

USABLE SQUARE
FEET 6338

1 FIRST FLOOR - FLOOR PLAN
SCALE: 1/4" = 1' on 24"x 36" PAPER

TEAM DDS
7895 DOVE PARKWAY
CANAL WINCHESTER, OHIO 43110
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TENANT BUILD OUT/REMODEL FOR PROFESSIONAL OFFICE FACILITIES:

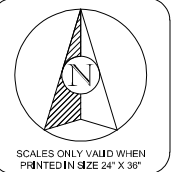
JEFF MILTON DDS

POWELL OHIO

DRAWN BY: SND
CHECKED BY: AJO
TEAM DDS #:
XXXX

RELEASE:
5-9-19

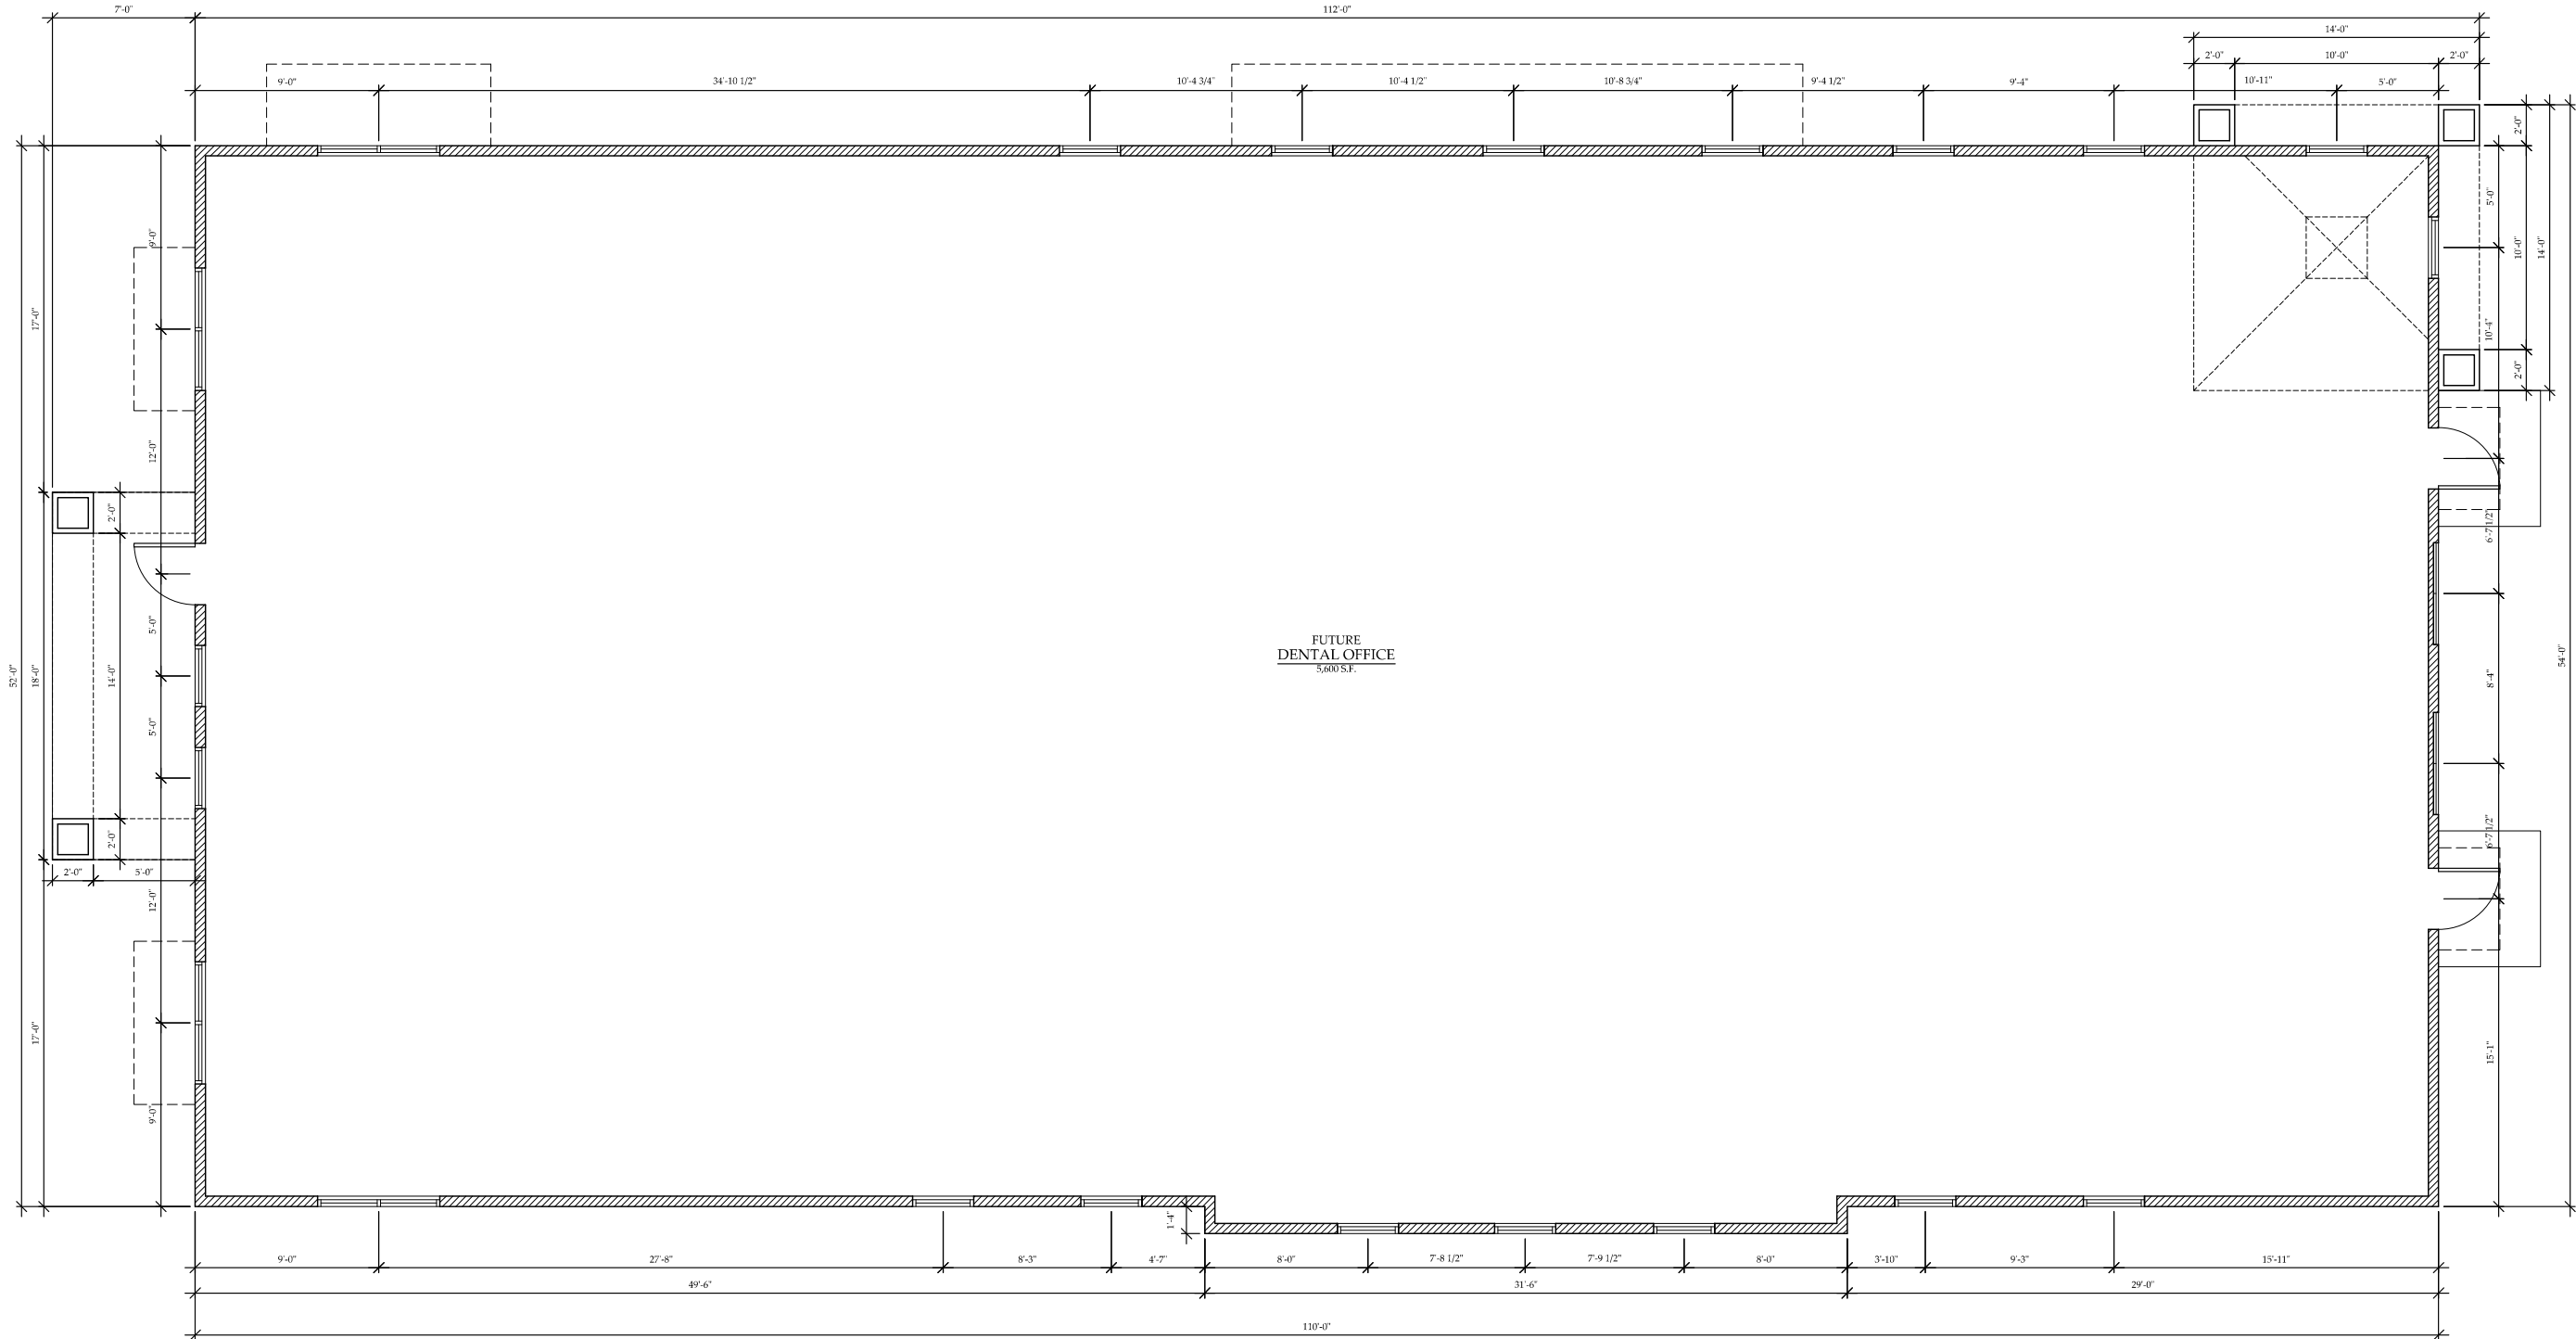A-2
FLOOR PLAN



FUTURE
DENTAL OFFICE
5,600 S.F.



A NEW FLOOR PLAN

SCALE: 1/4" = 1'-0"

5,762 S.F. BUILDING
126 S.F. PORCHES
5,846 S.F. TOTAL

JCKL
ARCHITECTS

P.O. BOX 340037
COLUMBUS, OHIO 43234
PHONE: (614) 764-1996



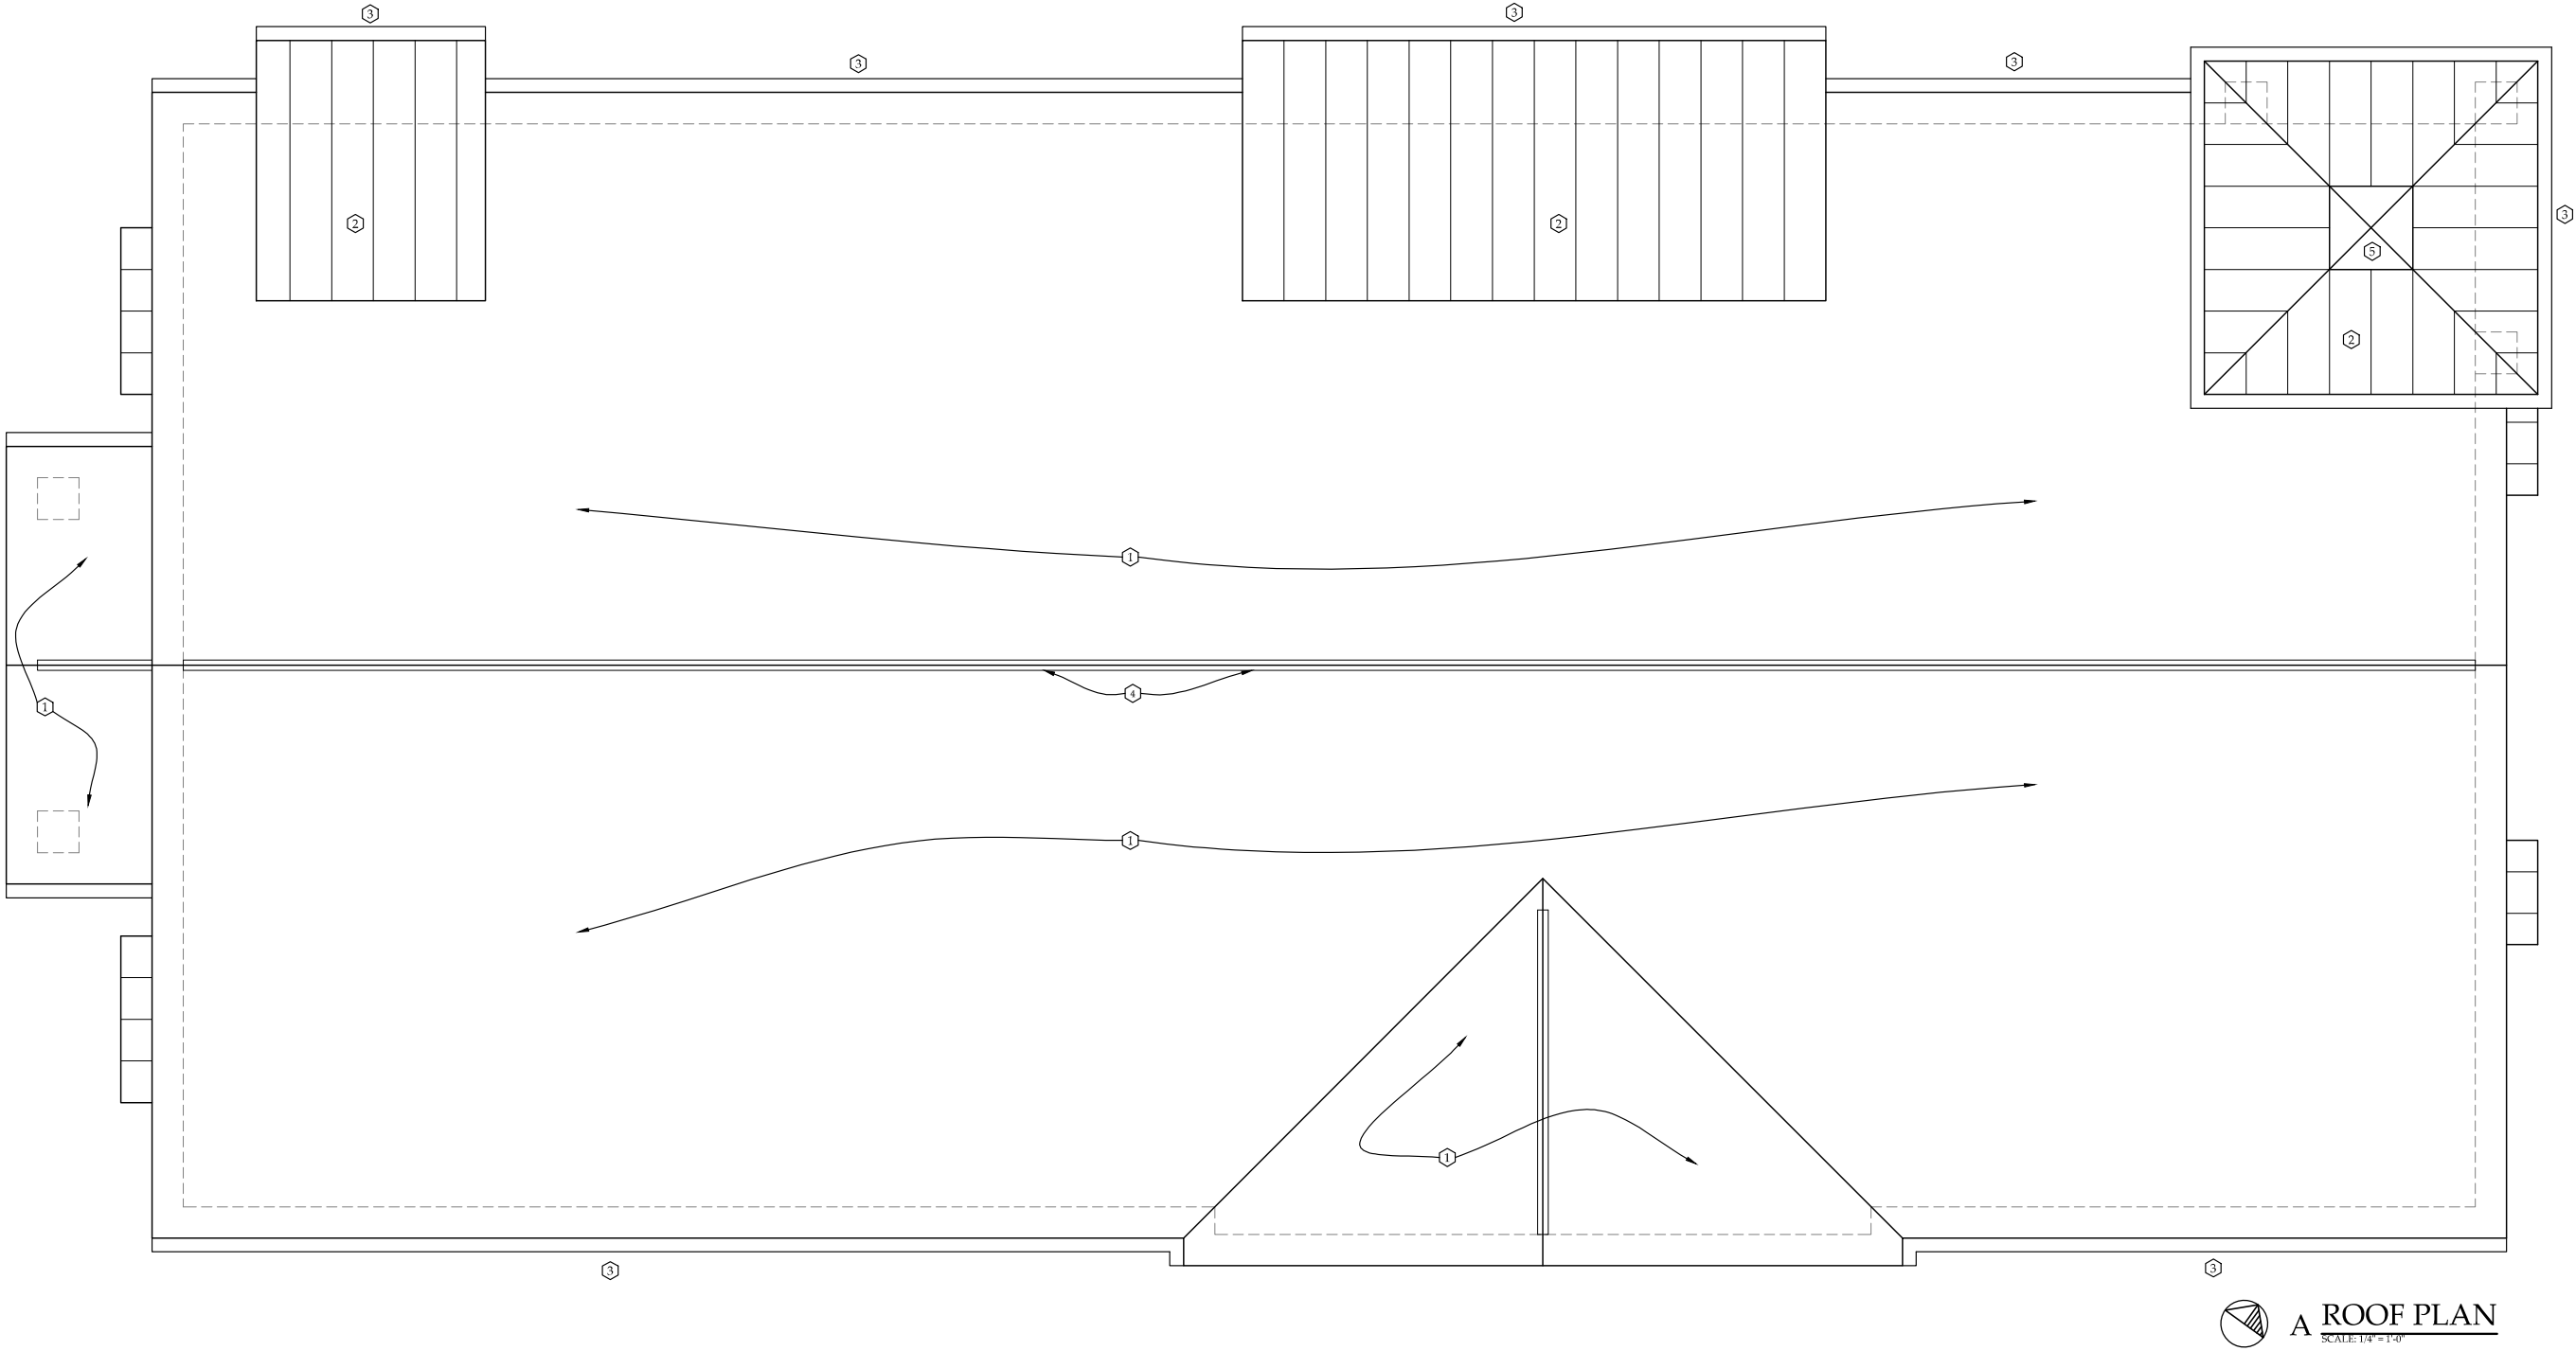
THOMAS W. COFFEY, LICENSE #08779
EXPIRATION DATE 12/31/19

PROJECT

POWELL OFFICE CONDOMINIUMS
PHASE II DEVELOPMENT DESIGN REVIEW
8930 LIBERTY ROAD
POWELL, OHIO 43065

- ☒ PRELIMINARY 11-20-18
8-15-19
8-22-19
- ☒ SKETCH PLAN 11-26-18
SUBMITTAL 12-7-18
- ☒ DEVELOPMENT PLAN 8-27-19
SUBMITTAL
- ☒ FINAL 9-24-19
DEVELOPMENT PLAN
SUBMITTAL
- ☐ BID SET
- ☐ PERMIT SET
- ☐ CONSTRUCTION
- ☐ REVISION


A1.0



A **ROOF PLAN**
SCALE: 1/4" = 1'-0"

ROOF PLAN FINISHES:

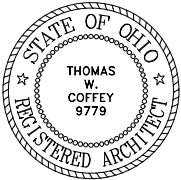- SPECIFIC ②
- 1. ASPHALT SHINGLES - OWENS CORNING® COLOR: ESTATE GREY
 - 2. STANDING SEAM METAL ROOF AWNING - GALVALUTTE®
 - 3. HALF ROUND ALUMINIUM GUTTER COLOR: WHITE
 - 4. CONTINUOUS RIDGE VENT.
 - 5. 3'-0" x 3'-0" x 5'-0" HIGH CUPOLA w/ SMART TRIM® BASE & ALUMINUM LOUVERS ON ALL (4) SIDES w/ STANDING SEAM ROOF.



THOMAS W. COFFEY, LICENSE #09779
EXPIRATION DATE 12/31/19


PROJECT

POWELL OFFICE CONDOMINIUMS
PHASE II DEVELOPMENT DESIGN REVIEW
8930 LIBERTY ROAD
POWELL, OHIO 43065

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<input checked="" type="checkbox"/>	SKETCH PLAN SUBMITTAL	11-26-18 12-7-18
<input checked="" type="checkbox"/>	DEVELOPMENT PLAN SUBMITTAL	8-27-19
<input checked="" type="checkbox"/>	FINAL DEVELOPMENT PLAN SUBMITTAL	9-24-19
<input type="checkbox"/>	BID SET	
<input type="checkbox"/>	PERMIT SET	
<input type="checkbox"/>	CONSTRUCTION	
<input type="checkbox"/>	REVISION	



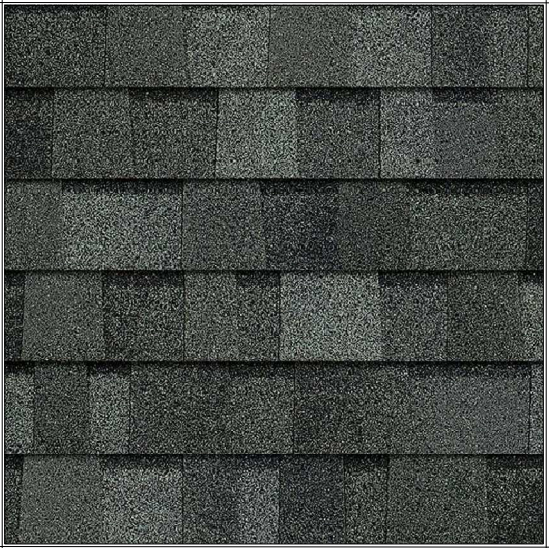STANDING SEAM AWNING
'GALVALUME'



'OWENS CORNING'
ASPHALT SHINGLE
'ESTATE GREY'



'THERMA-TRU'
FRENCH ENTRY DOORS
'BENCHMARK'



BOARD and BATTEN SIDING
'HARDI PLANK'- WHITE



LEDGER STONE
'CULTURED STONE'- HUDSON BAY
w/ GRAY MORTAR



VINYL DOUBLE-HUNG WINDOW
'WHITE'- 4 - 1



WALL MOUNT LIGHT
'KICHLER'- 9142 NI

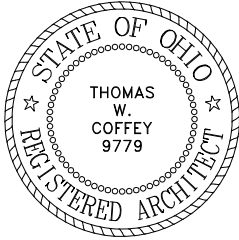


GOOSE NECK SIGN LIGHT
'MILLENNIUM LIGHTING'- RAS10-GA

PROPOSED
EXTERIOR SAMPLE BOARD

JCKL
ARCHITECTS

P.O. BOX 340037
COLUMBUS, OHIO 43234
PHONE: (614) 764-1996




THOMAS W. COFFEY, LICENSE #09779
EXPIRATION DATE 12/31/19

PROJECT

POWELL OFFICE CONDOMINIUMS
PHASE II DEVELOPMENT DESIGN
8930 LIBERTY ROAD
POWELL, OHIO 43065

- ☒ SKETCH PLAN SUBMITTAL 11-26-18
- ☒ DEVELOPMENT PLAN SUBMITTAL 8-27-19
- ☒ FINAL DEVELOPMENT PLAN SUBMITTAL 9-24-19
- ☐ REVISION

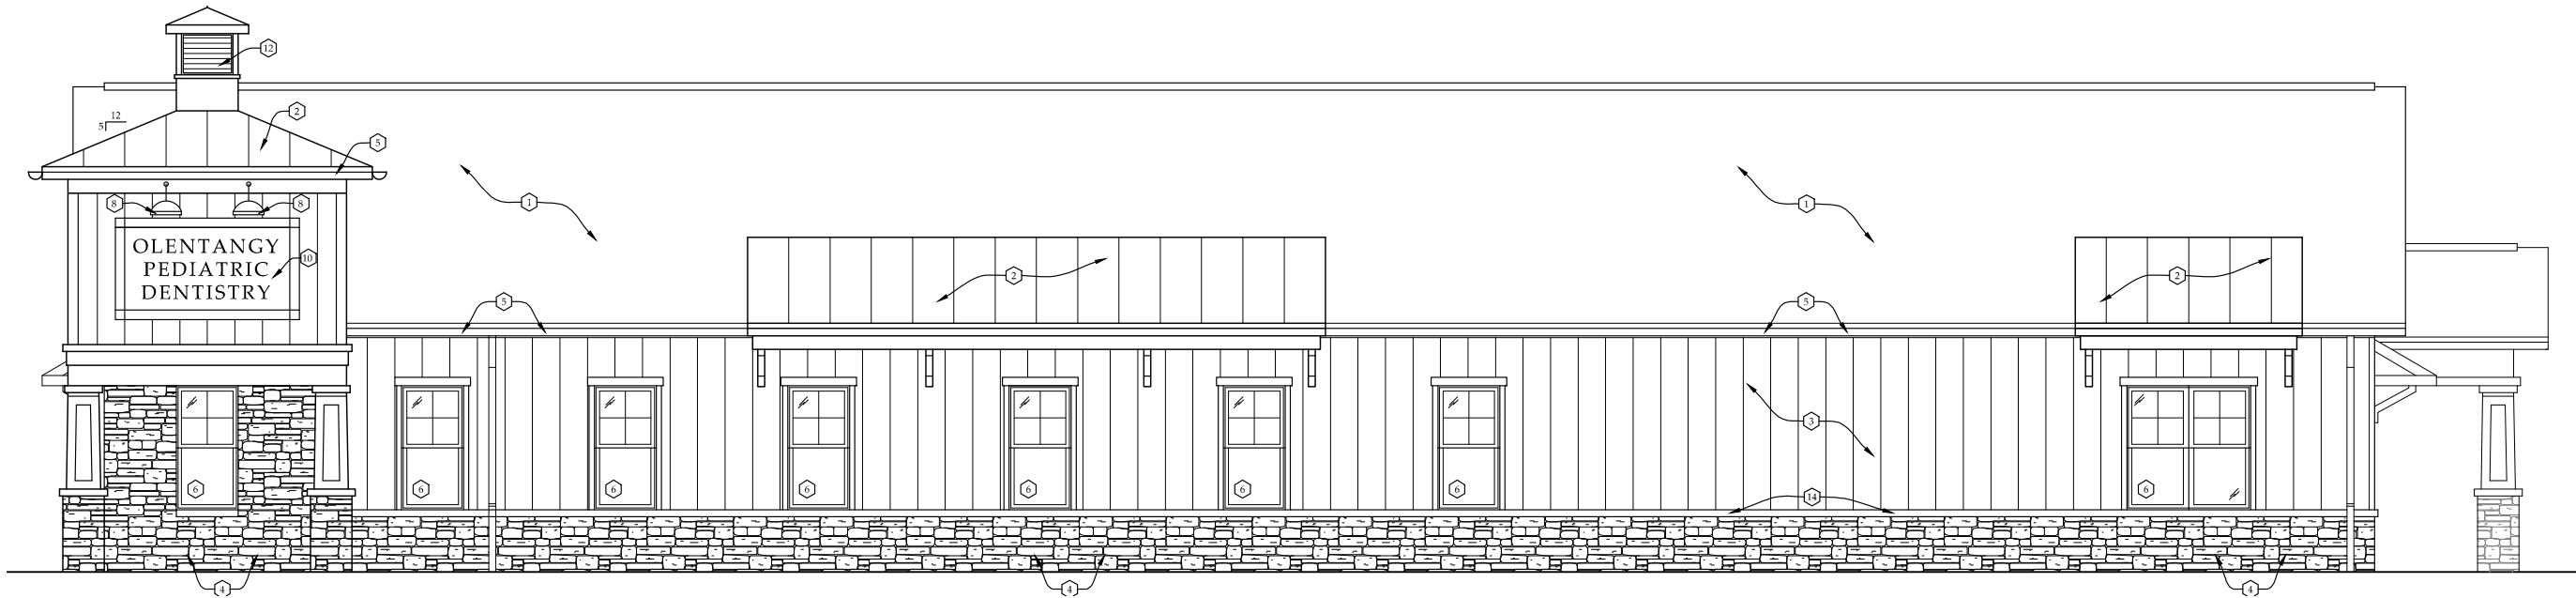A2.0




A WEST ELEVATION
SCALE: 1/4"=1'-0"

EXTERIOR ELEVATION FINISHES:

SPECIFIC

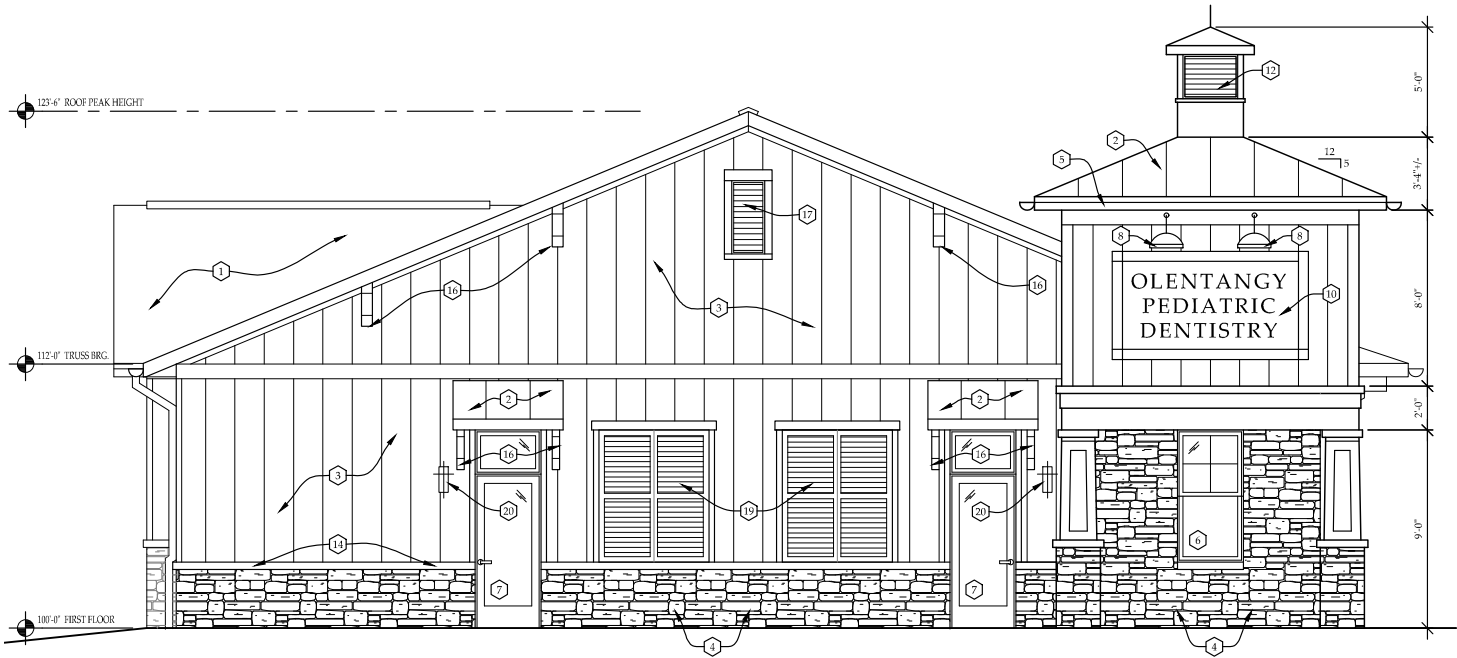
1. ASPHALT SHINGLES - 'OWENS CORNING' COLOR: ESTATE GREY
2. STANDING SEAM METAL ROOF AWNING - 'GALVALUTTE'
3. BOARD & BATTEN SIDING - 'HARDI PLANK' COLOR: WHITE
4. LEDGER STONE - 'CULTURED STONE' COLOR: HUDSON BAY WITH 'GRAY' MORTAR.
5. HALF ROUND ALUMINIUM GUTTER COLOR: WHITE
6. VINYL DOUBLE HUNG WINDOW - 4 OVER 1 COLOR: WHITE
7. FRENCH STYLE ALUMINIUM ENTRY DOOR - 'THERMA TRU' COLOR: WHITE
8. GOOSE NECK LIGHT - WITH ANGLED GALVANIZED SHADE- MODEL# RAS10-GA www.millenniumlighting.com
9. 17'-0" WIDE x 8" HIGH NON-ILLUMINATED PIN-MOUNTED LETTERS OVER A SOLID "WHITE" 'SMART TRIM' PANEL
10. 8'-0" WIDE x 4'-0" HIGH NON-ILLUMINATED PIN-MOUNTED LETTERS OVER A SOLID "WHITE" 'SMART TRIM' PANEL TRIMMED OUT IN 5/4x6 "WHITE" 'SMART TRIM'
11. 8'-0" WIDE x 4'-0" SOLID "WHITE" 'SMART TRIM' PANEL TRIMMED OUT IN 1x6 "WHITE" 'SMART TRIM'
12. 3'-0" x 3'-0" x 5'-0" HIGH CUPOLA w/ 'SMART TRIM' BASE & ALUMINIUM LOUVERS ON ALL (4) SIDES w/ STANDING SEAM ROOF.
13. 5/4 'SMART TRIM/ ACCENT BOARD- 'WHITE'
14. 4" SANDSTONE SLOPED CAP.
15. "WHITE" 'SMART TRIM' TAPERED ACCENT COLUMN WRAP
16. "WHITE" 'FYPON' DECORATIVE BRACKET
17. 1'-4" WIDE x 3'-4" HIGH 'WHITE' ALUMINIUM FUNCTIONAL ATTIC VENT TRIMED-OUT WITH A 5/4x4 ON (3) SIDES, 5/4x6 'SMART TRIM' AT THE TOP.
18. 1'-4" WIDE x 2'-4" HIGH 'WHITE' ALUMINIUM FUNCTIONAL ATTIC VENT TRIMED-OUT WITH A 5/4x4 ON (3) SIDES, 5/4x6 'SMART TRIM' AT THE TOP.
19. (2) 30"x 6'-0" RAISED PANEL VINYL SHUTTERS SECURED TO WALL PANEL BEHIND. REFER TO DETAIL 'C' THIS SHEET.
20. WALL MOUNTED LIGHT FIXTURE - 'KICHLER' 17 INCH "BRUSHED NICKEL" MODEL# 9142NI .



B NORTH ELEVATION
SCALE: 1/4"=1'-0"

JCKL ARCHITECTS

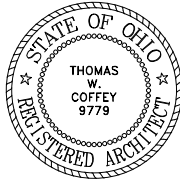P.O. BOX 340037
COLUMBUS, OHIO 43234
PHONE: (614) 764-1996



THOMAS W. COFFEY, LICENSE #09779
EXPIRATION DATE 12/31/19

PROJECT

POWELL OFFICE CONDOMINIUMS
PHASE II DEVELOPMENT DESIGN REVIEW
8930 LIBERTY ROAD
POWELL, OHIO 43065

<input checked="" type="checkbox"/> PRELIMINARY	11-20-18 8-15-19 8-22-19
<input checked="" type="checkbox"/> SKETCH PLAN SUBMITTAL	11-26-18 12-7-18
<input checked="" type="checkbox"/> DEVELOPMENT PLAN SUBMITTAL	8-27-19
<input checked="" type="checkbox"/> FINAL DEVELOPMENT PLAN SUBMITTAL	9-24-19
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<input type="checkbox"/> CONSTRUCTION	
<input type="checkbox"/> REVISION	


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THOMAS W. COFFEY, LICENSE #09779
EXPIRATION DATE 12/31/19

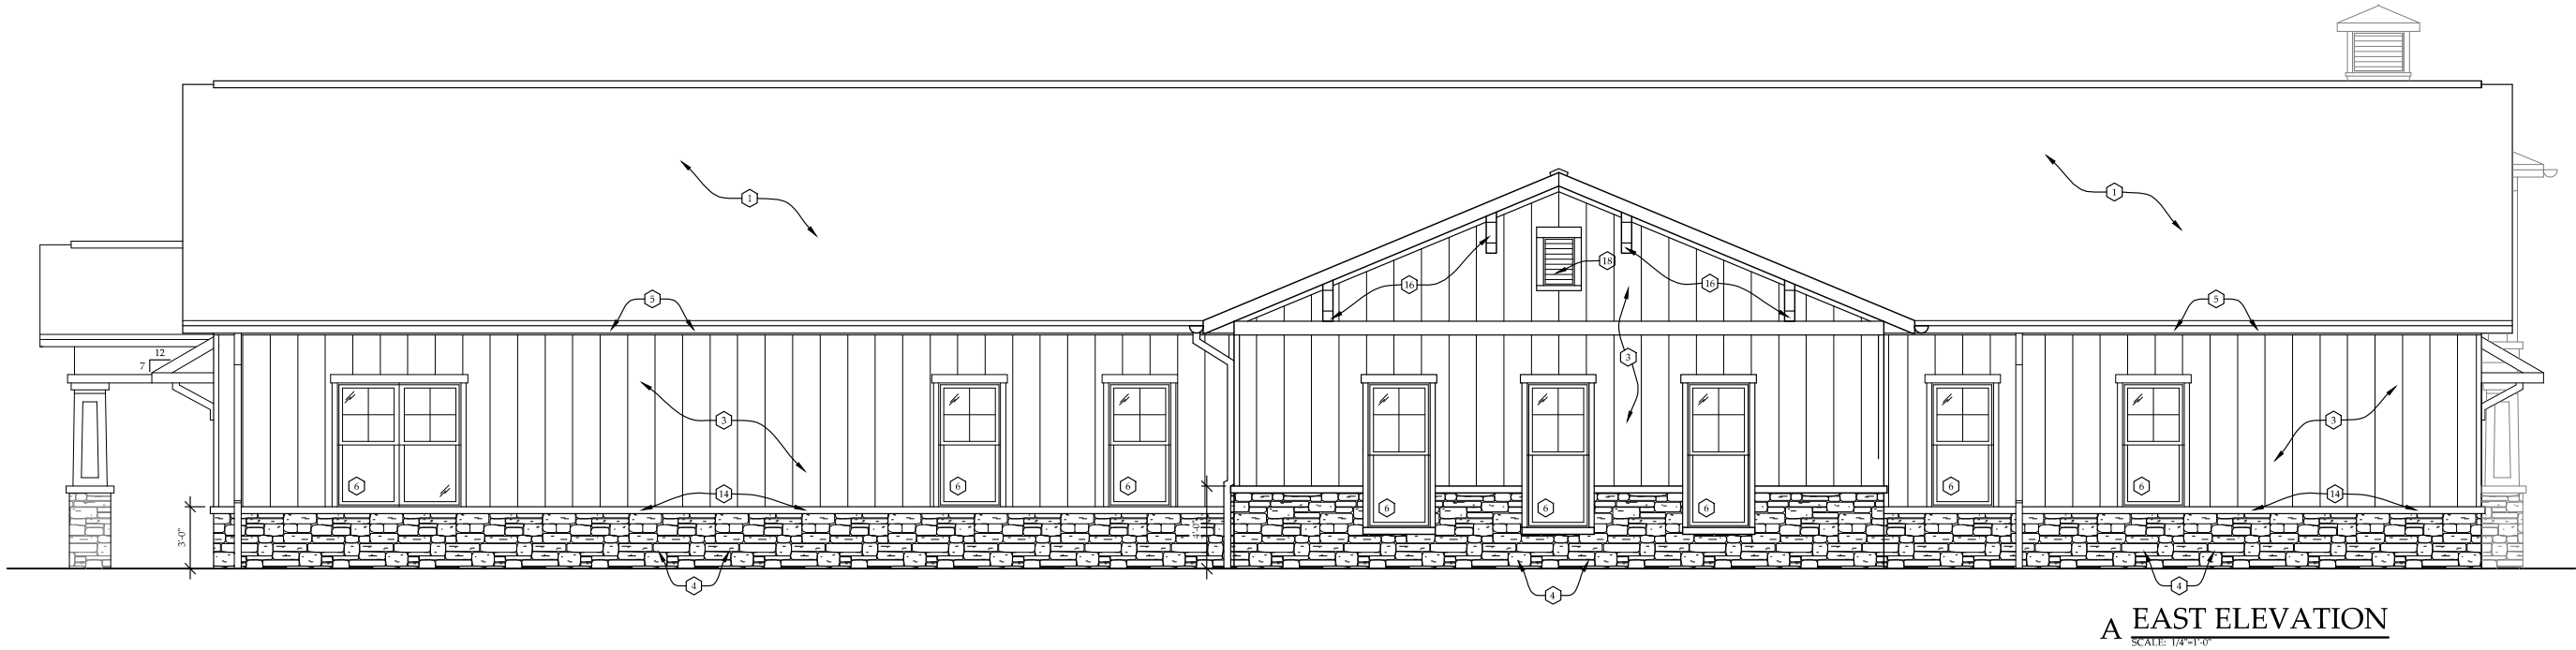PROJECT
POWELL OFFICE CONDOMINIUMS
PHASE II DEVELOPMENT DESIGN REVIEW
8930 LIBERTY ROAD
POWELL, OHIO 43065

<input checked="" type="checkbox"/> PRELIMINARY	11-20-18 8-15-19 8-22-19
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<input checked="" type="checkbox"/> FINAL DEVELOPMENT PLAN SUBMITTAL	9-24-19
<input type="checkbox"/> BID SET	
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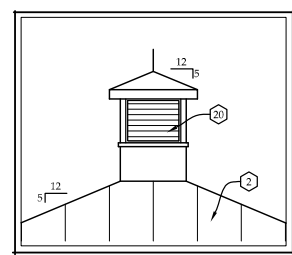
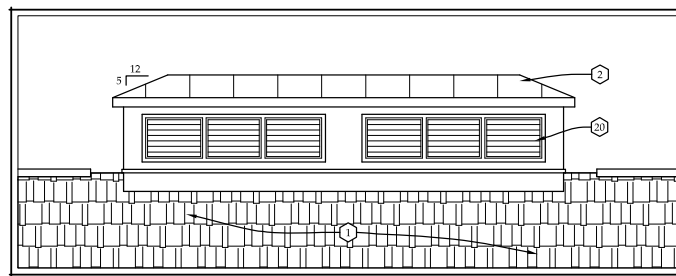
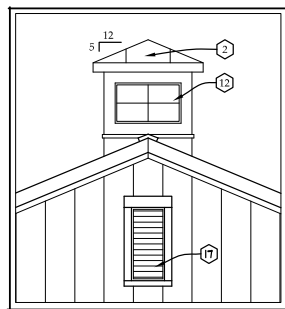
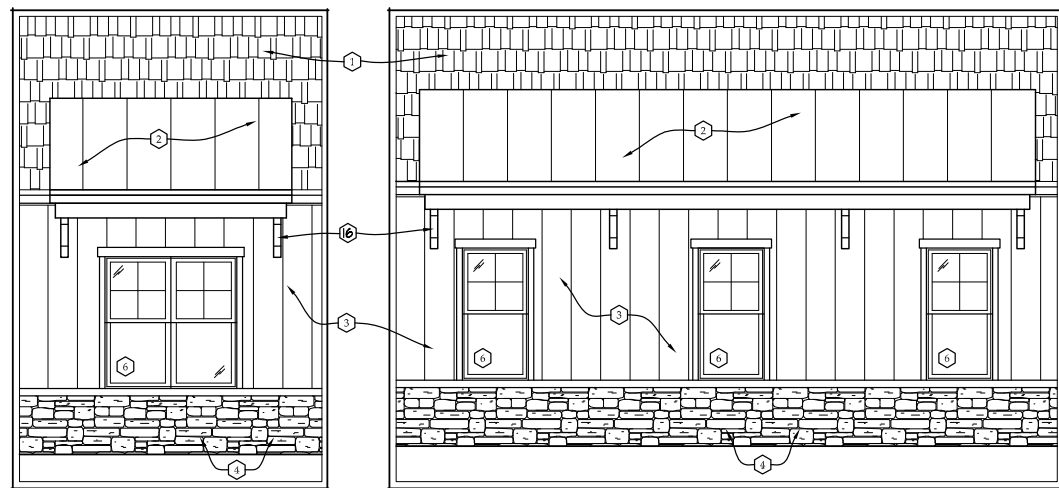
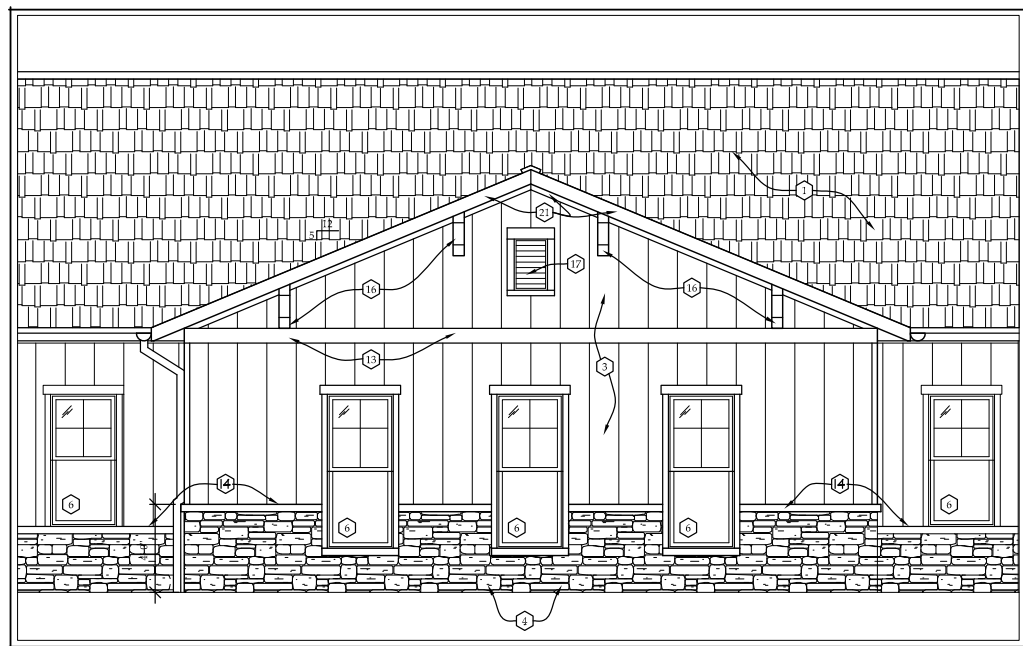
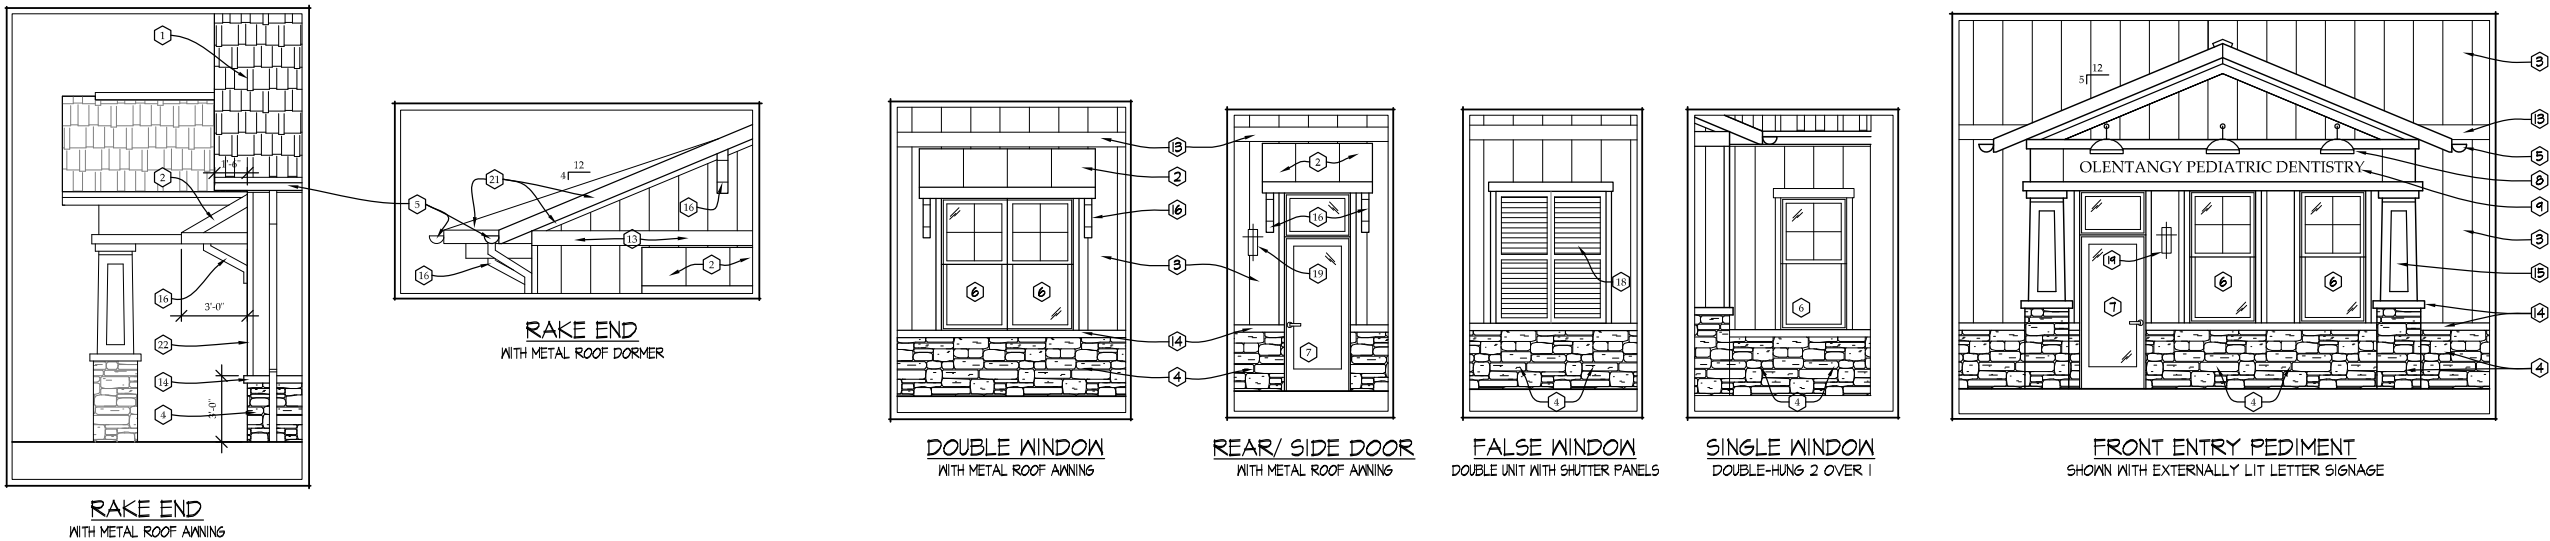


EXTERIOR ELEVATION FINISHES:

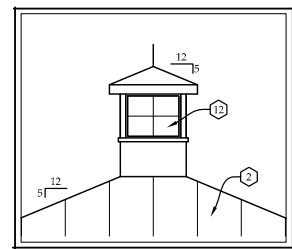
SPECIFIC

1. ASPHALT SHINGLES - 'OWENS CORNING' COLOR: ESTATE GREY
2. STANDING SEAM METAL ROOF AWNING - 'GALVALUTTE'
3. BOARD & BATTEN SIDING - 'HARDI PLANK' COLOR: WHITE
4. LEDGER STONE - 'CULTURED STONE' COLOR: HUDSON BAY
5. HALF ROUND ALUMINIUM GUTTER COLOR: WHITE
6. VINYL DOUBLE HUNG WINDOW - 4 OVER 1 COLOR: WHITE
7. FRENCH STYLE ALUMINIUM ENTRY DOOR - 'THERMA TRU' COLOR: WHITE
8. GOOSE NECK LIGHT - WITH ANGLED GALVANIZED SHADE- MODEL# RAS10-GA www.millenniumlighting.com
9. 17'-0" WIDE x 8" HIGH NON-ILLUMINATED PIN-MOUNTED LETTERS OVER A SOLID "WHITE" SMART TRIM PANEL
10. 8'-0" WIDE x 4'-0" HIGH NON-ILLUMINATED PIN-MOUNTED LETTERS OVER A SOLID "WHITE" SMART TRIM PANEL TRIMMED OUT IN 5/4x6 "WHITE" SMART TRIM
11. 8'-0" WIDE x 4'-0" SOLID "WHITE" SMART TRIM PANEL TRIMMED OUT IN 1x6 "WHITE" SMART TRIM
12. 3'-0" x 3'-0" x 5'-0" HIGH CUPOLA w/ 'SMART TRIM' BASE & ALUMINIUM LOUVERS ON ALL (4) SIDES w/ STANDING SEAM ROOF.
13. 5/4 'SMART TRIM' ACCENT BOARD- "WHITE"
14. 4" SANDSTONE SLOPED CAP.
15. "WHITE" SMART TRIM TAPERED ACCENT COLUMN WRAP
16. "WHITE" 'FYFON' DECORATIVE BRACKET
17. 1'-4" WIDE x 3'-4" HIGH 'WHITE' ALUMINIUM FUNCTIONAL ATTIC VENT TRIMED-OUT WITH A 5/4x4 ON (3) SIDES, 5/4x6 'SMART TRIM' AT THE TOP.
18. 1'-4" WIDE x 2'-4" HIGH 'WHITE' ALUMINIUM FUNCTIONAL ATTIC VENT TRIMED-OUT WITH A 5/4x4 ON (3) SIDES, 5/4x6 'SMART TRIM' AT THE TOP.
19. WALL MOUNTED LIGHT FIXTURE- 'KICHLER' 17 INCH "BRUSHED NICKEL" MODEL# 9142NI .





ROOF CUPOLA
SHOWN WITH VENTILATION LOUVER OPTION



ROOF CUPOLA
SHOWN WITH ILLUMINATED GLASS OPTION

EXTERIOR ELEVATION FINISHES:

- COLORS AS APPROVED BY OWNER
- SPECIFIC 2
1. ASPHALT SHINGLES - 'OWENS CORNING'
 2. STANDING SEAM METAL ROOF ANNING
 3. BOARD & BATTEN SIDING - 'HARDI PLANK'
 4. LEDGER STONE - 'CULTURED STONE' COLOR: HUDSON BAY WITH GRAY MORTAR
 5. HALF ROUND ALUMINUM GUTTER
 6. VINYL DOUBLE HUNG WINDOW - 4 OVER 1 REQUIRED. TRIMMED-OUT IN 'SMART' TRIM
 7. FRENCH STYLE ALUMINUM ENTRY DOOR - 'THERMA TRU' WITH GLASS TRANSOM ABOVE.
 8. GOOSE NECK LIGHT - WITH ANGLED GALVANIZED SHADE- MODEL# RASIO-GA www.millenniumlighting.com (REQUIRED)
 9. 14'-0" WIDE x 8" HIGH NON-ILLUMINATED PIN-MOUNTED LETTERS OVER A SOLID 'SMART' TRIM PANEL
 10. 1'-4" WIDE x DESIGNATED HIGH 'WHITE' ALUMINUM FUNCTIONAL ATTIC VENT TRIMMED-OUT WITH A 5/4x4 ON (2) SIDES, 5/4x6 'SMART' TRIM' AT THE TOP.
 11. 8'-0" WIDE x 4'-0" SOLID 'SMART' TRIM PANEL TRIMMED OUT IN 5/4x6 'WHITE' 'SMART' TRIM
 12. 3'-0" x 3'-0" x 5'-0" HIGH CUPOLA w/ 'SMART' TRIM BASE & GLASS TOP ON ALL (4) SIDES ILLUMINATED w/ STANDING SEAM ROOF
 13. 1x6 x 5/4 'SMART' TRIM/ ACCENT BOARD
 14. 4" SANDSTONE SLOPED CAP.
 15. 'SMART' TRIM/ TAPERED ACCENT COLUMN WRAP
 16. PYPON DECORATIVE BRACKET
 17. 1'-4" WIDE x 3'-0" HIGH ALUMINUM FUNCTIONAL ATTIC VENT TRIMMED-OUT WITH A 5/4x4 ON (2) SIDES, 5/4x6 'SMART' TRIM' AT THE TOP.
 18. (2) 30"x 6'-0" RAISED PANEL VINYL SHUTTERS SECURED TO MALL PANEL BEHIND.
 19. WALL MOUNTED LIGHT FIXTURE- 'KICHLER' 17 INCH 'BRUSHED NICKEL' MODEL# 9142N1 (REQUIRED)
 20. 3'-0" x 3'-0" x 5'-0" HIGH CUPOLA w/ 'SMART' TRIM BASE & ALUMINUM LOUVERS ON ALL (4) SIDES w/ STANDING SEAM ROOF.
 21. 'SMART' TRIM RAKE and EAVE TRIM
 22. 1x4 x 5/4 'SMART' TRIM/ ACCENT BOARD



WALL MOUNT LIGHT (REQUIRED)
'KICHLER'- 9142 N1




GOOSE NECK SIGN LIGHT (REQUIRED)
MILLENNIUM LIGHTING'- RASIO-GA




SW 1005
'PURE WHITE'



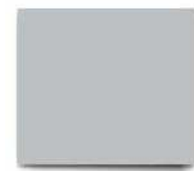SW 1011
'NATURAL CHOICE'



SW 6254
'LAZY GRAY'

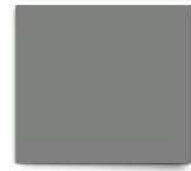


SW 1067
'CITYSCAPE'

EXTERIOR BUILDING COLORS
PLUS OTHER NEUTRAL COLORS AS APPROVED BY OWNER

PROPOSED EXTERIOR BUILDING ELEMENTS

JCKL ARCHITECTS

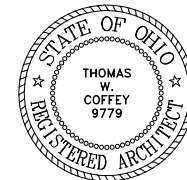P.O. BOX 340037
COLUMBUS, OHIO 43234
PHONE: (614) 764-1996




THOMAS W. COFFEY, LICENSE #09779
EXPIRATION DATE 12/31/19

PROJECT

POWELL OFFICE CONDOMINIUMS
PHASE II DEVELOPMENT DESIGN REVIEW
8930 LIBERTY ROAD
POWELL, OHIO 43065

<input checked="" type="checkbox"/>	PRELIMINARY	11-20-18 8-15-19 8-22-19
<input checked="" type="checkbox"/>	SKETCH PLAN SUBMITTAL	11-26-18 12-7-18
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<input checked="" type="checkbox"/>	FINAL DEVELOPMENT PLAN SUBMITTAL	9-24-19
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<input type="checkbox"/>	REVISION	

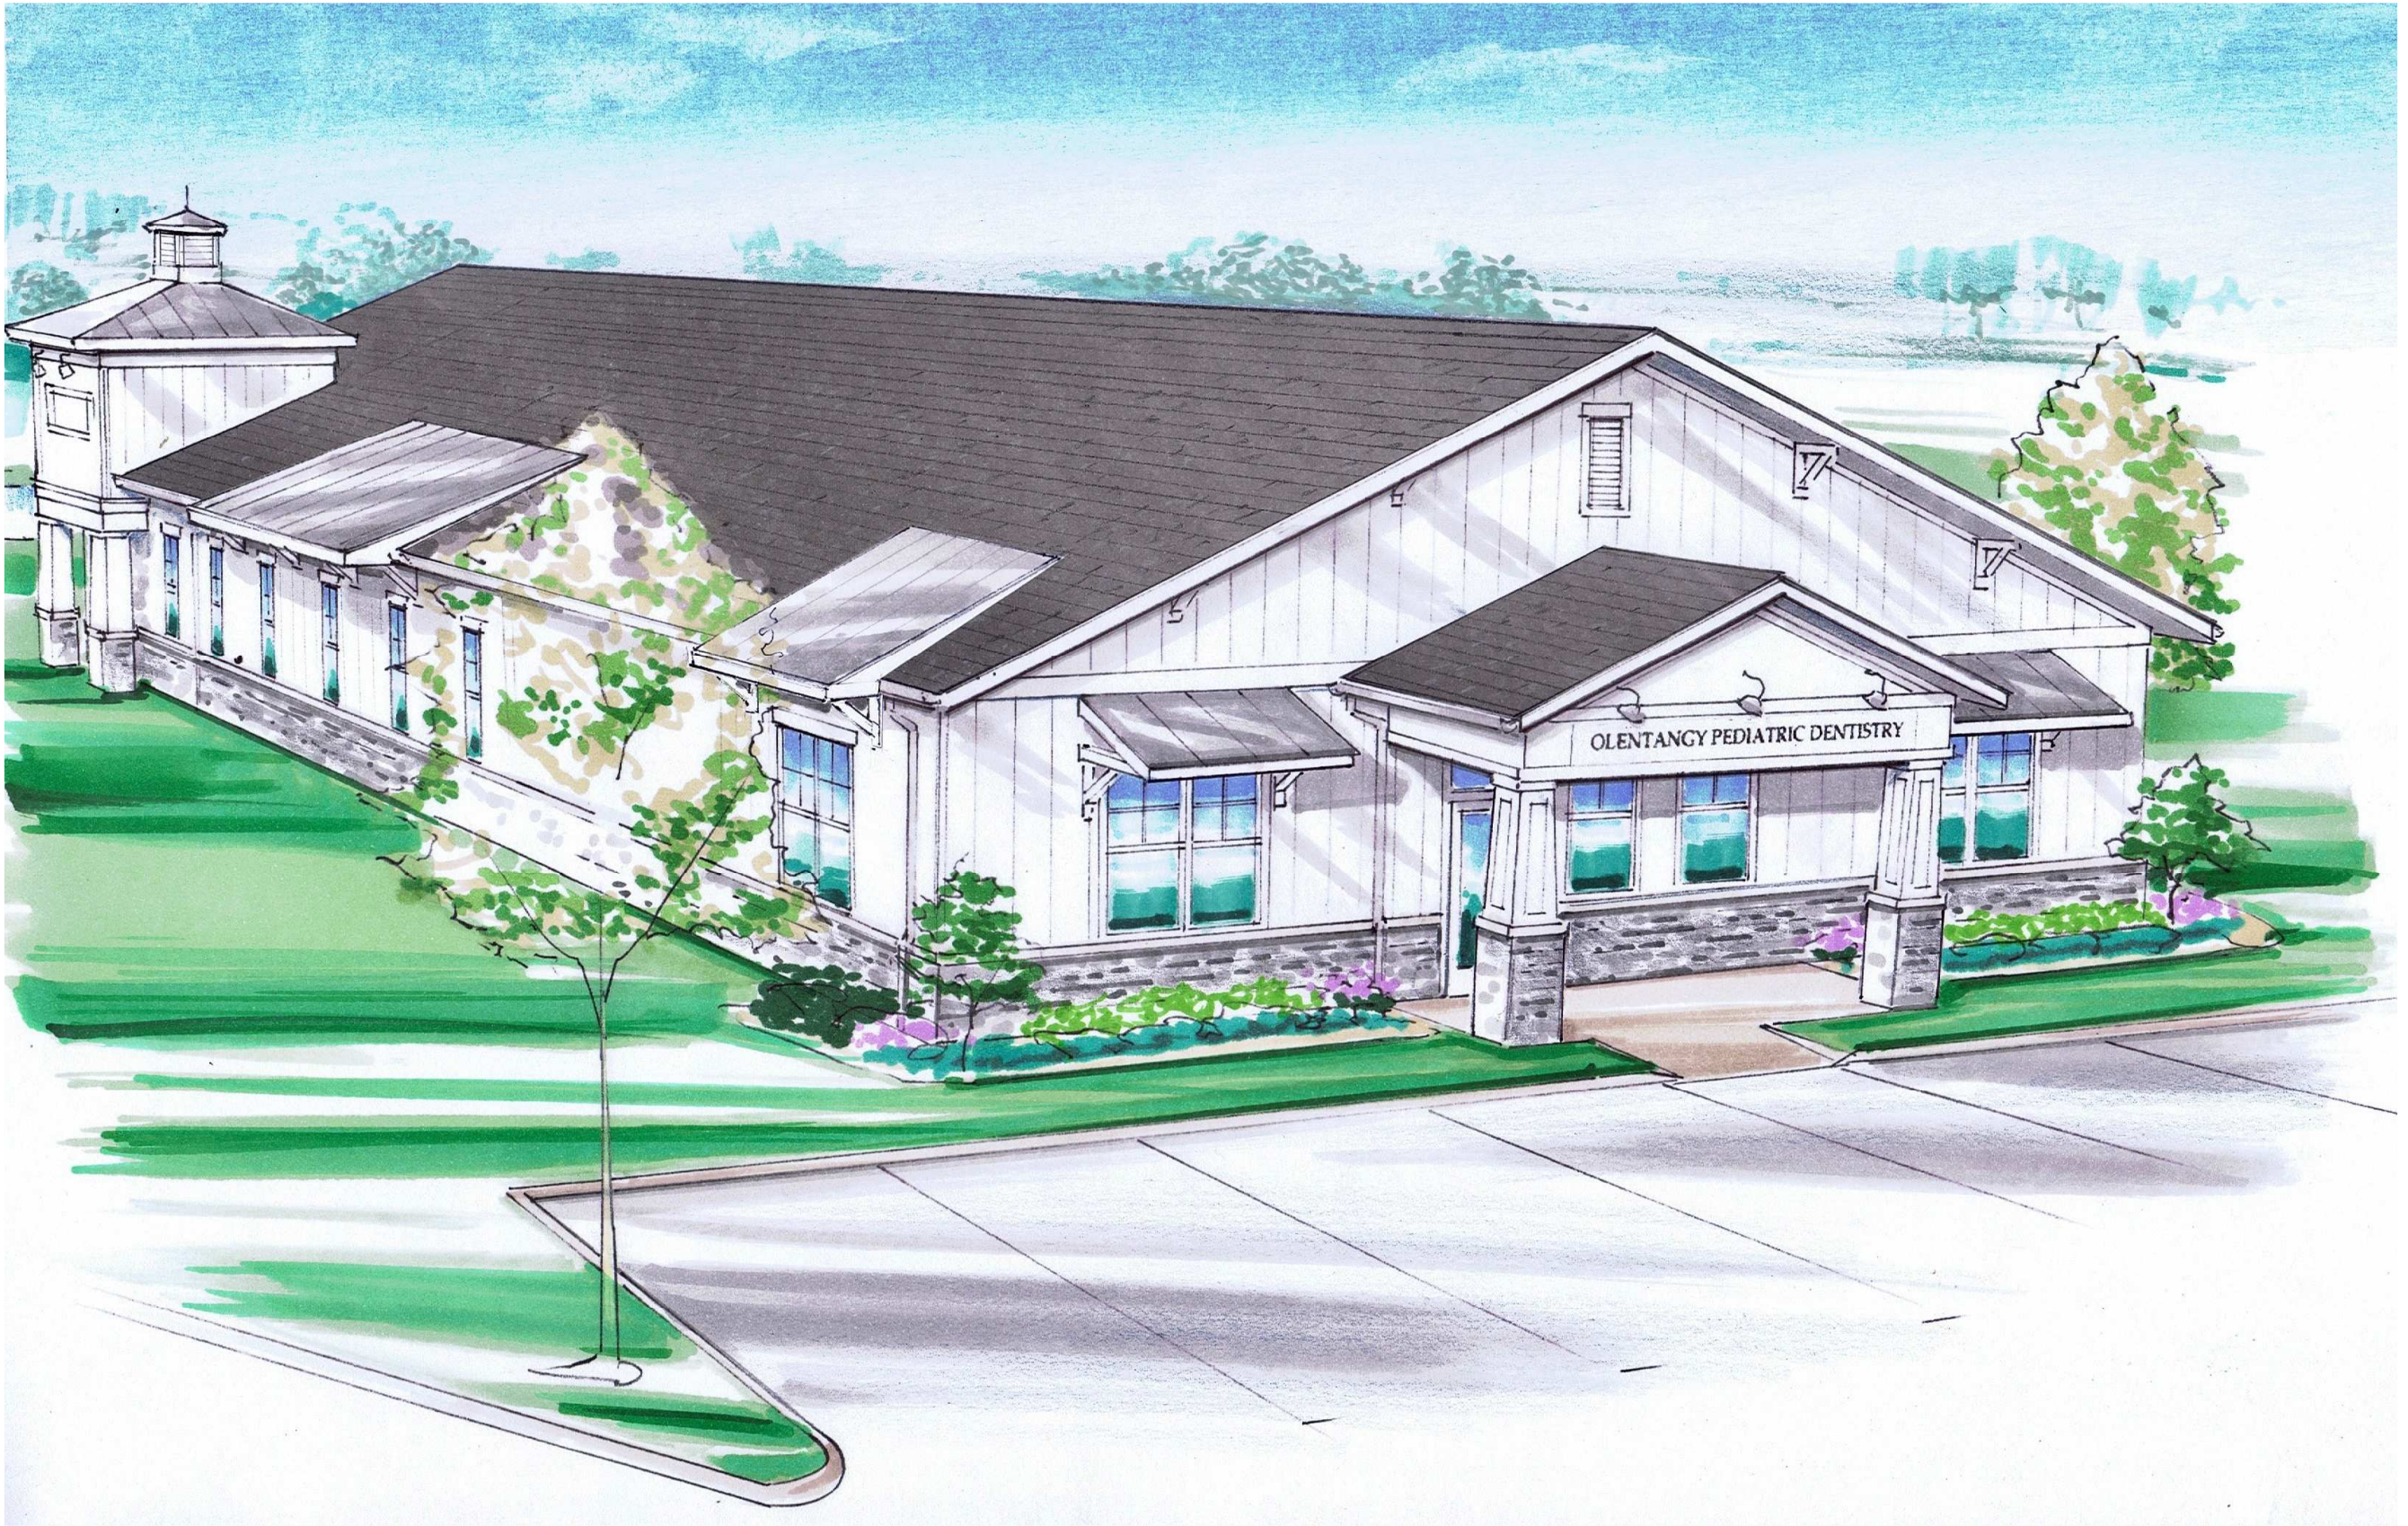
A2.3



A EXTERIOR RENDERING
SCALE: NTS
LOOKING FROM PARKING LOT

JCKL
ARCHITECTS

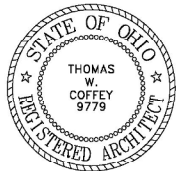P.O. BOX 340037
COLUMBUS, OHIO 43234
PHONE: (614) 764-1996



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PROJECT
POWELL OFFICE CONDOMINIUMS
PHASE II DEVELOPMENT DESIGN REVIEW
8930 LIBERTY ROAD
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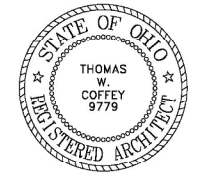
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8-15-19
8-22-19 |
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SUBMITTAL | 11-26-18
12-7-18 |
| <input checked="" type="checkbox"/> DEVELOPMENT PLAN
SUBMITTAL | 8-27-19 |
| <input checked="" type="checkbox"/> FINAL
DEVELOPMENT PLAN
SUBMITTAL | 9-24-19 |
| <input type="checkbox"/> BID SET | |
| <input type="checkbox"/> PERMIT SET | |
| <input type="checkbox"/> CONSTRUCTION | |
| <input type="checkbox"/> REVISION | |

A3.0



JCKL
ARCHITECTS

P.O. BOX 340037
COLUMBUS, OHIO 43234
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<input checked="" type="checkbox"/>	FINAL DEVELOPMENT PLAN SUBMITTAL	9-24-19
<input type="checkbox"/>	BID SET	
<input type="checkbox"/>	PERMIT SET	
<input type="checkbox"/>	CONSTRUCTION	
<input type="checkbox"/>	REVISION	

A3.1

B

B EXTERIOR RENDERING
SCALE: NTS
LOOKING FROM ROAD

1. CONTRACTOR SHALL SUPERVISE AND DIRECT THE WORK USING THE CONTRACTOR'S BEST SKILL AND ATTENTION. THE CONTRACTOR SHALL BE SOLELY RESPONSIBLE AND HAVE CONTROL OVER CONSTRUCTION MEANS, METHODS, TECHNIQUES, SEQUENCE, AND JOB SITE SAFETY.

2. GC MUST PROVIDE & INSTALL ALL PRODUCTS PER PLANS. ONLY SUBSTITUTED PRODUCTS NEED TO BE SUBMITTED TO THE ARCHITECT FOR APPROVAL. UNAPPROVED SUBSTITUTIONS WILL BE REPLACED AT THE EXPENSE OF THE GC.

3. VERBAL REPRESENTATION HAS NO VALUE AND ALL REQUESTS TO CHANGE ANY PRODUCTS OR SPECIFICATIONS PER PLANS, MUST BE SUBMITTED IN WRITING TO THE ARCHITECT & TIE FOR APPROVAL.



Jarmel Kizel
ARCHITECTS AND ENGINEERS INC.
42 OKNER PARKWAY
LIVINGSTON, NEW JERSEY 07039
TEL: 973-994-9669
FAX: 973-994-4069
www.jarmelkizel.com

Architecture
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Interior Design
Implementation Services

THE LEARNING
EXPERIENCE

ACADEMY OF
EARLY EDUCATION

POWELL COMMONS
POWELL, OHIO



ISSUE			
NO.	DATE	DESCRIPTION	INT.
REVISION			
NO.	DATE	DESCRIPTION	INT.


PROFESSIONAL CERTIFICATION
LICENSE NUMBER: 12444
EXPIRATION DATE: 31 DEC 2019
MATTHEW B. JARMEL, AIA, MBA

Project Number: TLEOH19-071	Scale: 1/8" = 1'-0"
Drawn By: CS	Approved By: MBJ

PROPOSED FLOOR PLAN

Drawing Number: SA-3.1	
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LICENSING CALCULATIONS Learning Experience, Powell, OHIO								
ROOM	STATE REQUIRED S.F. (35 S.F. PER CHILD)	NET* S.F.	ACTUAL S.F.	RATIO CHILD PER S.F.	# OF CHILDREN	# OF TEACHERS	TEACHER RATIO	AGE GROUP
INFANT A	660	663	717	1/55	12	2	2/12	6 WK-12 MO.
INFANT B	660	660	714	1/55	12	2	1/6	12 MO.-18 MO.
TODDLER	490	495	549	1/35	14	2	1/7	18-24 MO.
TWADDLER	490	491	545	1/35	14	2	1/7	24-30 MO.
PREPPERS	560	561	573	1/35	16	2	1/8	30-36 MO.
PREPPERS/MBB	560	832	844	1/35	16	2	1/8	30-36 MO.
PRE-SCHOOL #1	840	845	857	1/35	24	2	1/12	3 YRS.
PRE-SCHOOL #2a	490	505	517	1/35	14	1	1/14	4-5 YRS.
PRE-SCHOOL #2b	490	494	506	1/35	14	1	1/14	4-5 YRS.
PRE K-K 1	630	635	683	1/35	18	1	1/18	5-6 YRS.
TOTALS	6,045	-	-	-	154	17	-	-
* CALCULATED LESS BUILT-IN ITEMS GROSS AREA 10,010 S.F. PLAY AREA 4,978 S.F.						+2 ADMIN. STAFF		
						TOTAL	173	

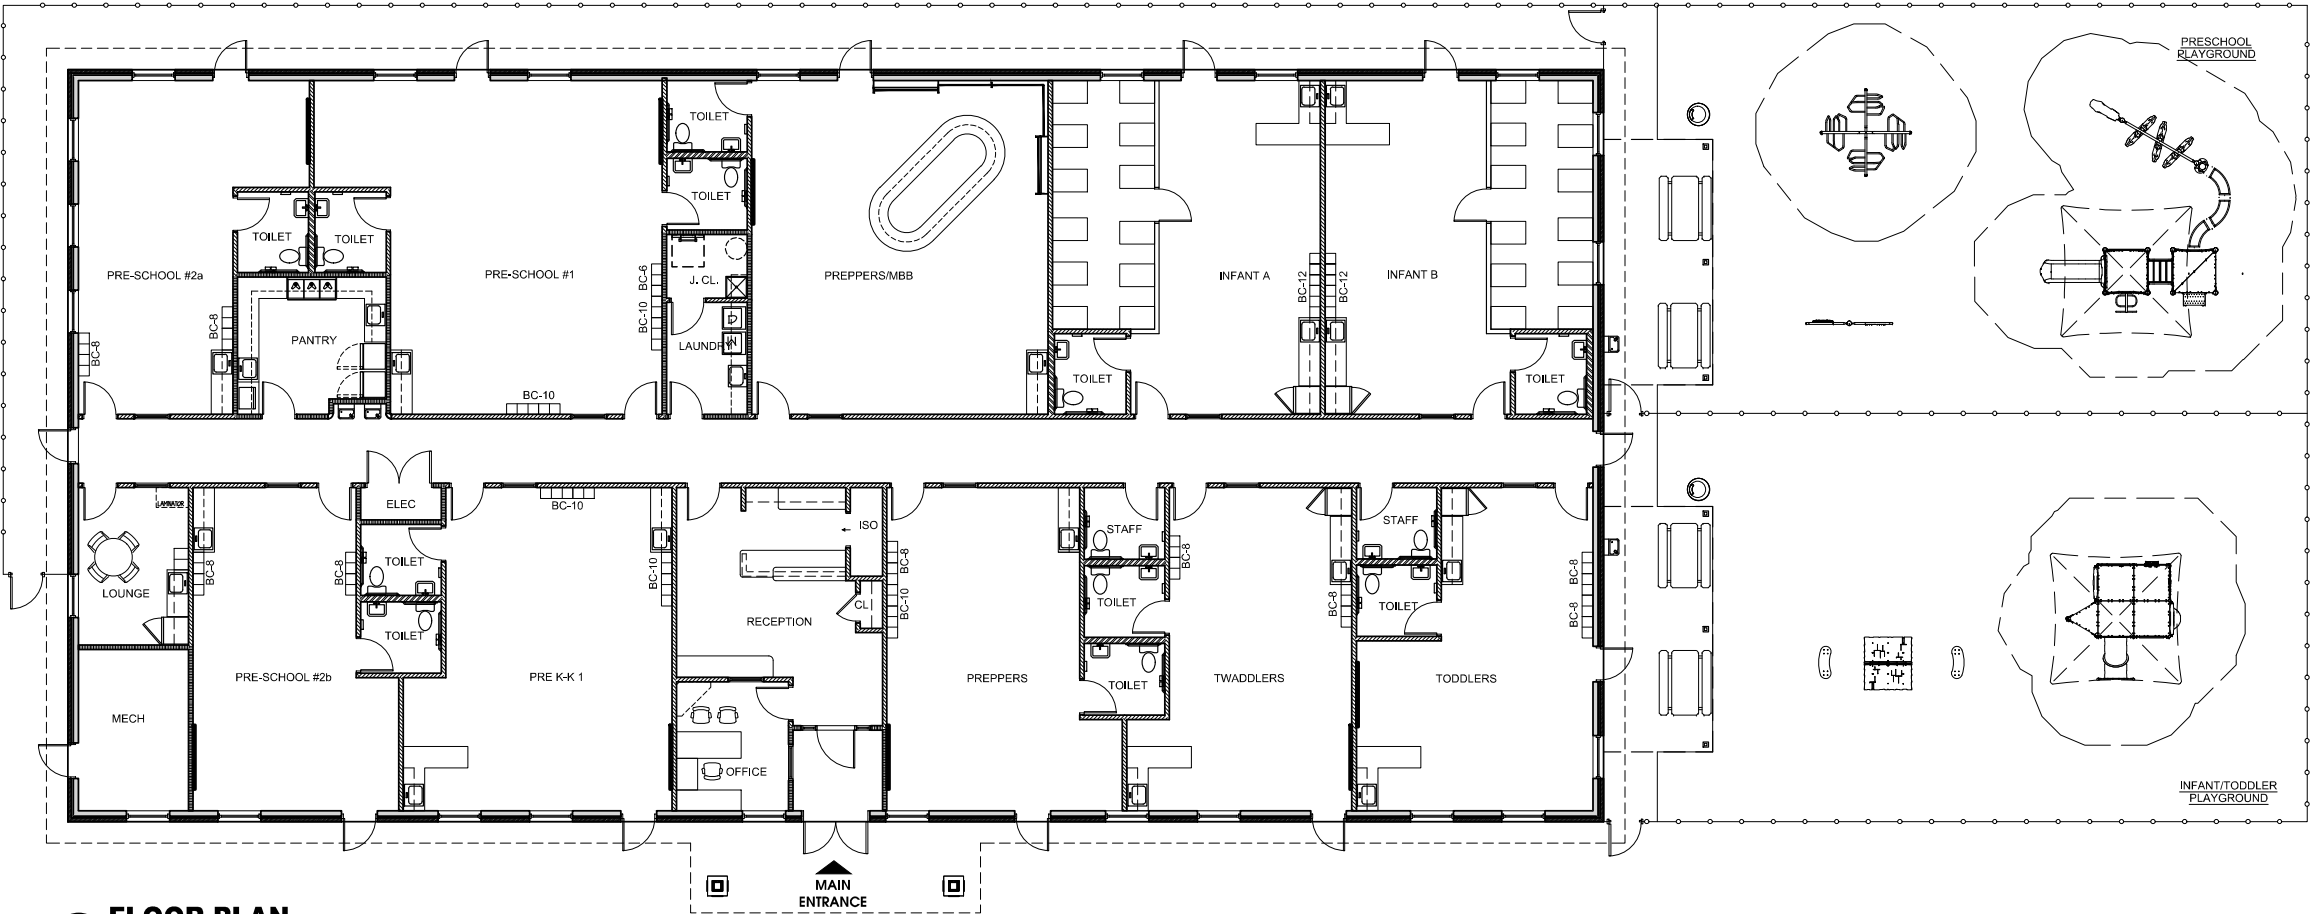

1 FLOOR PLAN
SCALE: 1/8" = 1'-0"



Architecture
Engineering
Interior Design
Implementation Services

[illegible][illegible]

MATTHEW B. JARMEL, AIA, MBA

JR	MBJ
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PROPOSED ELEVATIONS

SA-3.2



EXTERIOR MATERIAL SCHEDULE			
LABEL	MANUFACTURER	SIZE / TYPE	FINISH / COLOR
STOREFRONT	KAWNEER	TRIFAB 451T / 350 PER DOOR SCHEDULE	BONE WHITE
DOOR	-	PER DOOR SCHEDULE	FACTORY PRIMED
FIXED WINDOW	PLY GEM	SILVER LINE V1 SERIES PER WINDOW SCHEDULE	WHITE
STONE-1	HUDSON BAY	CULTURED STONE	LEDGER STONE
SILL-1	MODERN PRECAST	3 3/4"x6"W W/ 2" FLAT W/ 1/4" DRIP EDGE	REGULAR (LIGHT GREY)
SILL-2	MODERN PRECAST	CUSTOM SILL 3 3/4"x4"W W/ 2" FLAT REF. DTL. 6/A-032	REGULAR (LIGHT GREY)
SIDING-1	TBD	BOARD AND BATTEN SIDING	WHITE
TRIM-1	-	PT. WOOD 1X4	PAINT WHITE
TRIM-2	-	PT. WOOD 1X10	PAINT WHITE
TRIM-3	-	PT. WOOD 1X12	PAINT WHITE
ROOF-1	OWENS CORNING	ASPHALT SHINGLES	ESTATE GREY
ROOF-2	GALVALUME	STANDING SEAM AWNING	DOVE GRAY
GUTTER-1	-	6" ALUMINUM TYPE 'K' W/ LEAF SCREEN AND 6" LEADERS	WHITE
VINYL-1	ROYAL BUILDING PRODUCTS	COLORSCAPES TRIPLE 4 PERFORATED SOFFIT NOM. THICKNESS 0.042"	WHITE (REF. NOTE 2 BELOW)
KNOX-1	KNOX BOX	3200 SERIES W/ RECESSED MOUNT FLANGE, HINGE DOOR, & TAMPER SWITCH	DARK BRONZE (REF. NOTE 2 BELOW)
KNOX-2	KNOX BOX	1650 SERIES W/ RECESSED MOUNT FLANGE, HINGE DOOR, & TAMPER SWITCH	DARK BRONZE (REF. NOTE 2 BELOW)
FINISH SCHEDULE NOTES: 1. G.C. SHALL VERIFY KNOX BOX MODEL(S) AND LOCATION(S) WITH AUTHORITY HAVING JURISDICTION PRIOR TO ORDERING AND INSTALLATION. 2. G.C. SHALL ENSURE ALL EXTERIOR FINISHES ARE INSTALLED AND FINISHED IN COMPLIANCE WITH MANUFACTURERS' WARRANTY REQUIREMENTS. 3. IF BLOCKS ARE NOT PERMITTED, COLUMNS MUST MATCH EXTERIOR FINISH OF THE BUILDING.			



1. CONTRACTOR SHALL SUPPLY AND DIRECT THE WORK USING THE CONTRACTOR'S BEST SKILL AND ATTENTION. THE CONTRACTOR SHALL BE SOLELY RESPONSIBLE AND HAVE CONTROL OVER CONTRACT DURING MEETING, METHOD, TIME, SEQUENCE, AND JOB SITE SAFETY.

2. GC MUST PROVIDE A INSTALL ALL PRODUCTS PER PLANS. ONLY SUBSTITUTED PRODUCTS NEED TO BE SUBMITTED TO THE ARCHITECT FOR APPROVAL. UNAPPROVED SUBSTITUTIONS WILL BE REJECTED AT THE EXPENSE OF THE GC.


3. VERBAL REPRESENTATION HAS NO VALUE AND ALL REQUESTS TO CHANGE ANY PRODUCTS OR SPECIFICATIONS PER PLANS, MUST BE SUBMITTED IN WRITING TO THE ARCHITECT & TELL FOR APPROVAL.



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DETAILS

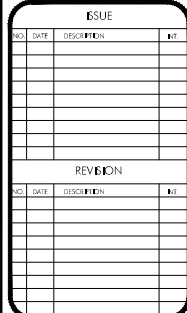Drawing Number:

SA-3.3