

CITY OF POWELL

PLANNING AND ZONING COMMISSION (P&Z)
FINAL DEVELOPMENT PLAN APPLICATION

ALL ITEMS ON THIS APPLICATION MUST BE COMPLETED.

Application Fee: \$600.00 + \$90.00 per acre

Applicant: Ford & Associates Architects Contact: Rob MacInnesAddress/City/State/Zip: 1500 West First Avenue / Columbus / Ohio / 43212Email Address: rmacinnnes@fordarchitects.comPhone No: 614.488.6252 Cell Phone No: - Fax No: 614.488.9963**Property Owner:** Dr. Ali KhahsarAddress/City/State/Zip: 5600 Heathrow Drive / Powell / Ohio / 43065Email Address: zelzeleh2@hotmail.comPhone No: 614.390.1124 Cell Phone No: - Fax No: -**Architect/Designer for Applicant:** Ford & Associates Architects Contact: Rob MacInnesAddress/City/State/Zip: 1500 West First Avenue / Columbus / Ohio / 43212Email Address: rmacinnnes@fordarchitects.comPhone No: 614.488.6252 Cell Phone No: - Fax No: 614.488.9963**Property Address:** SE corner of West Olentangy Street & Murphy Parkway / Powell / Ohio / 43065Lot Number/Subdivision: N/A Existing Use: Vacant Land
(Currently Zoned) Proposed Use: Multi-Tenant Commercial
Planned Commercial Development

Reason for Administrative Review (attach necessary documents):

Applicant is requesting FINAL review of the site plan, civil, landscaping, site lighting, and building elevations for the proposed commercial building planned for the southeast corner of Murphy Parkway and West Olentangy Street.Checklist:

- ☐ Preliminary Plan requirements set forth in Section 1143.11(c) and Final Plan requirements set forth in Section 1143.11(j).
- ☐ Provide any other information that may useful to the Planning and Zoning Commission or City Staff in the space below or attach additional pages.
- ☐ **5 copies** of all drawings, text, any other items, and application.
- ☐ Attach the required fee - \$600.00 + \$90.00 per acre.

(See Over)

**APPROVAL SHALL EXPIRE AND MAY BE REVOKED IF CONSTRUCTION DOES NOT BEGIN
WITHIN TWO (2) YEARS FROM THE DATE OF ISSUANCE OF APPROVAL.**

I agree to grant the Village Staff, the Commission, Board or Council considering this application access to the property that is the subject of this application for the purposes of reviewing this application and posting public notice for this application.

Signature of ~~Appellant:~~ ^{Applicant}  Date: 07-11-2017

Office Use
Received

Office Use
AMT _____
TYPE/DATE _____
RECEIPT # _____
PAYOR _____
Payment

City of Powell · 47 Hall Street · Powell, Ohio 43065 · (614) 885-5380 · (614) 885-5339 fax · www.cityofpowell.us

CITY OF POWELL, OHIO
FINAL DEVELOPMENT PLAN
FOR
POWELL RETAIL

ARCHITECT

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FORD & ASSOCIATES ARCHITECTS
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PLANNER/LANDSCAPE ARCHITECT


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GAHANNA, OHIO 43230
614-428-7750,
TWARNER@ADVANCEDCIVILDESIGN.COM


CITY OF POWELL

DAVID BETZ
47 HALL STREET
POWELL, OH 43065
614-885-5380 EXT 1033
DBETZ@CITYOFPOWELL.US



INDEX MAP

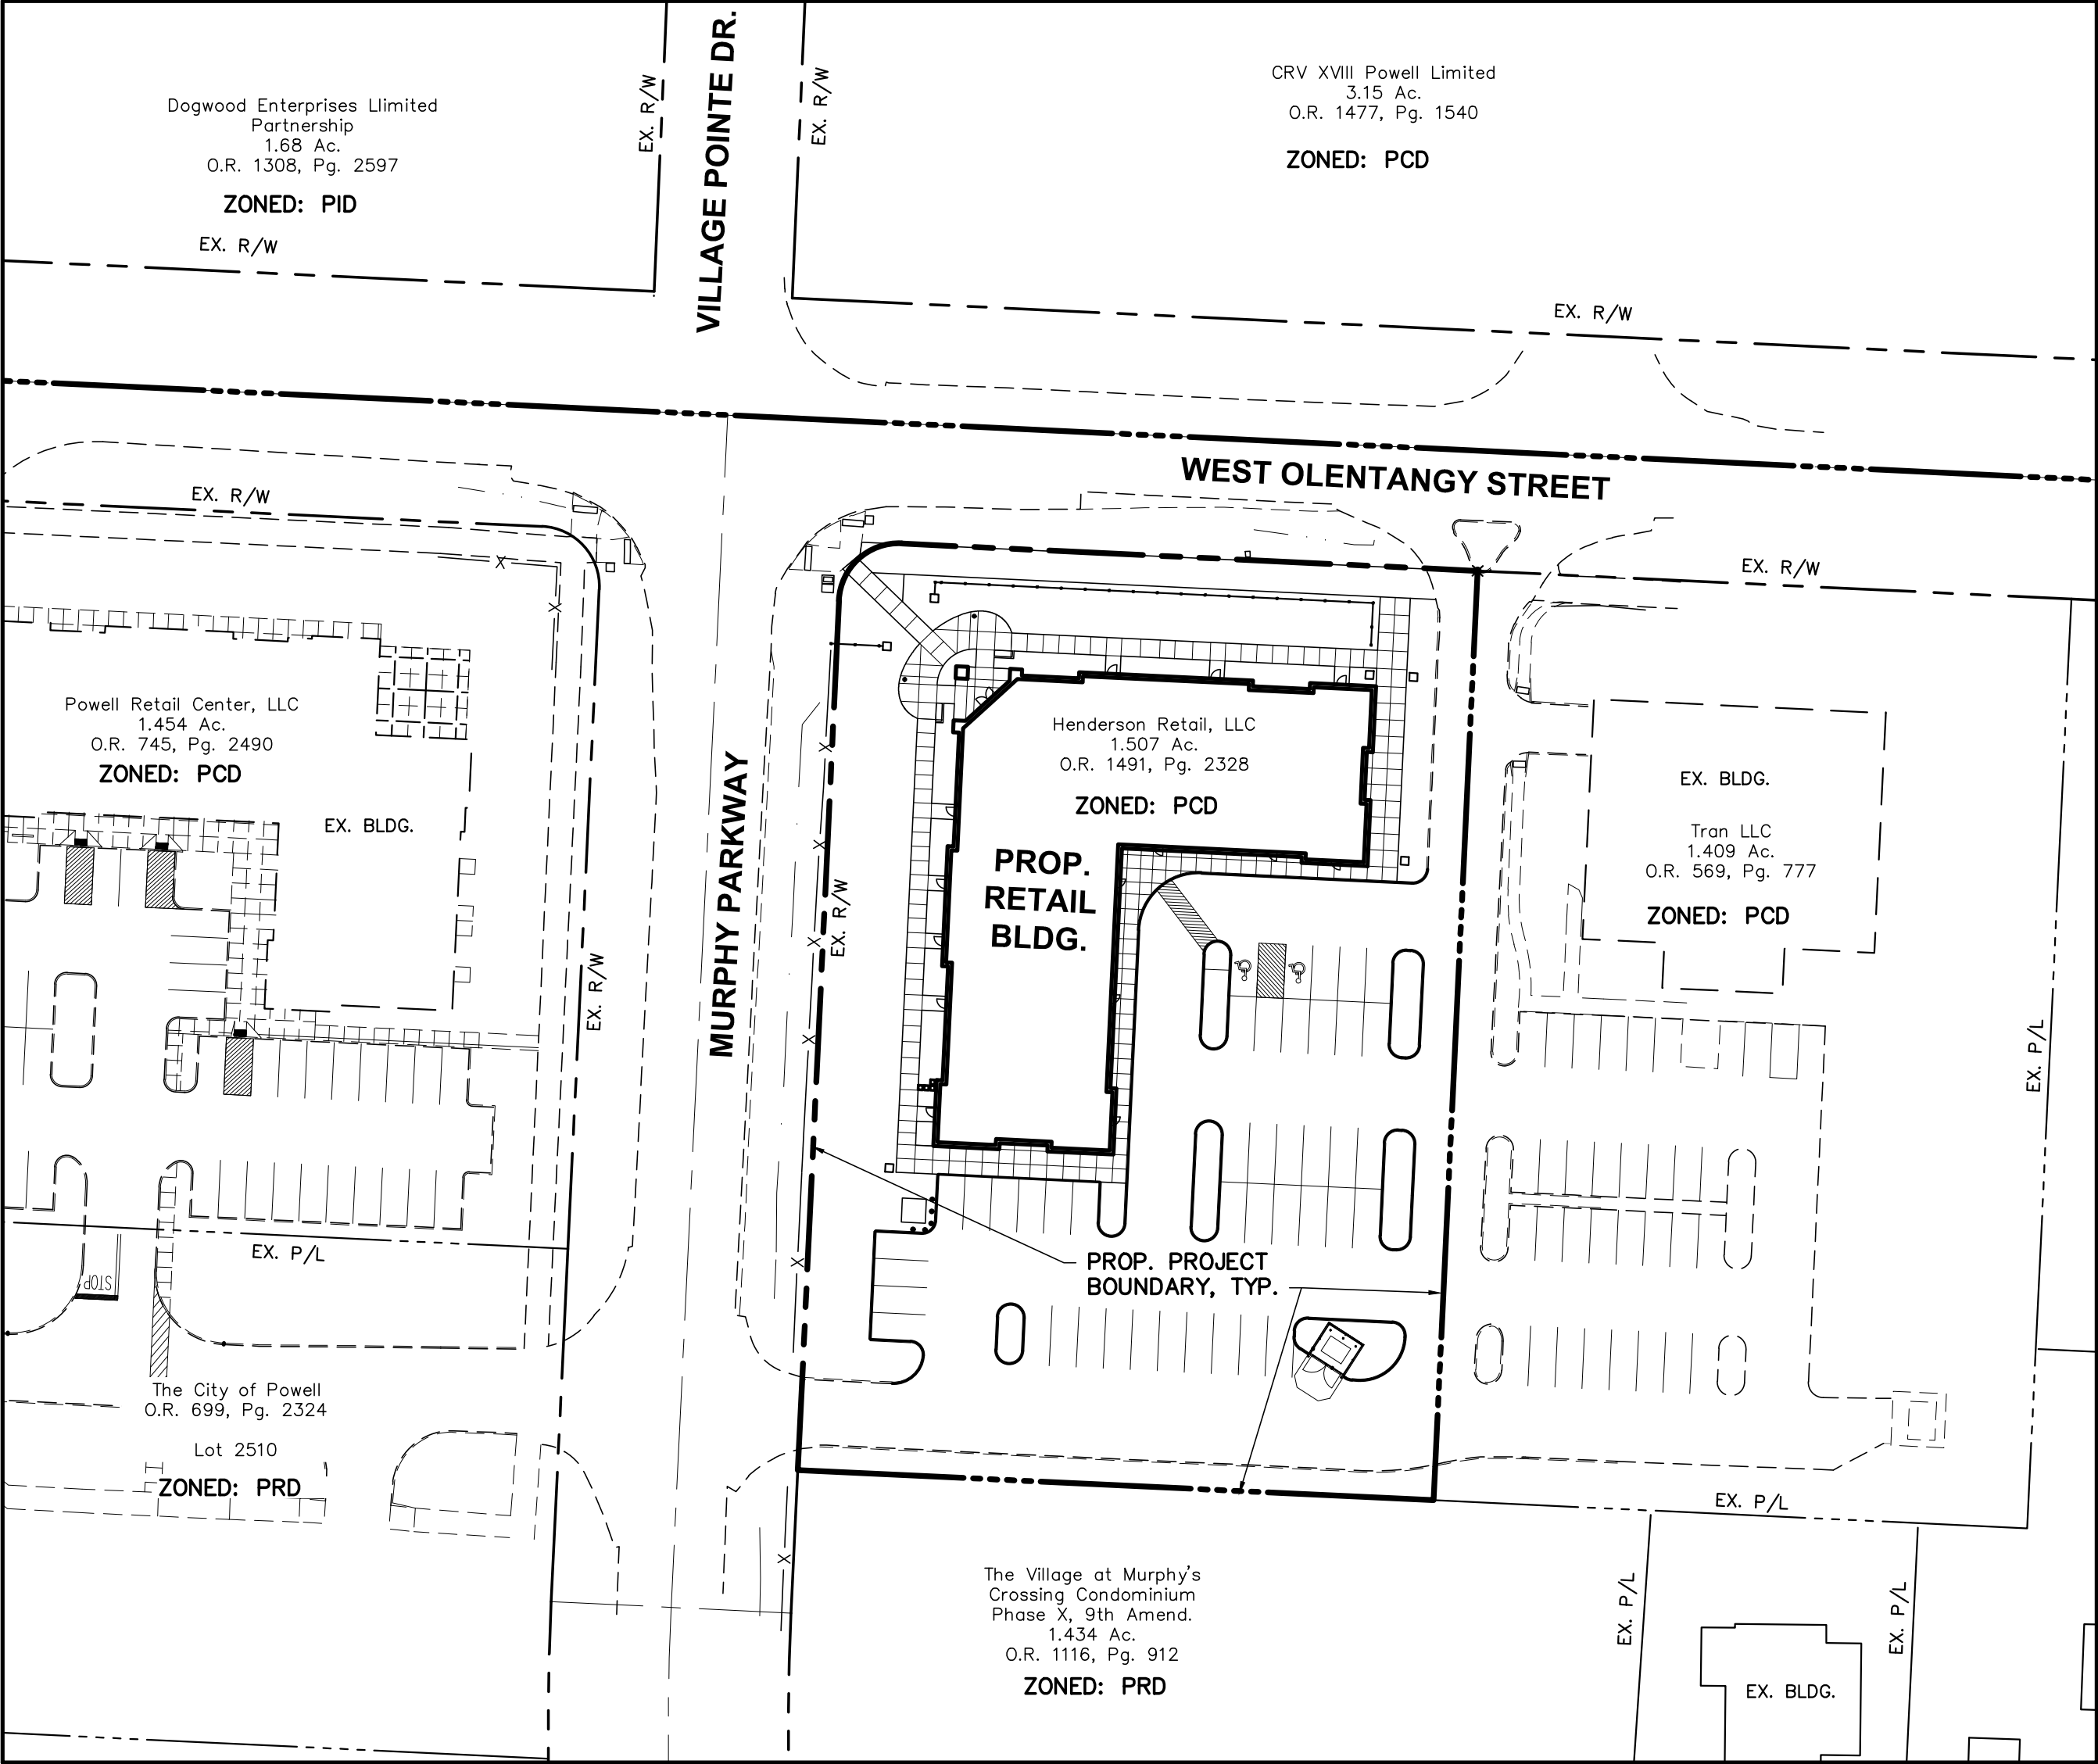SCALE: 1"=50'

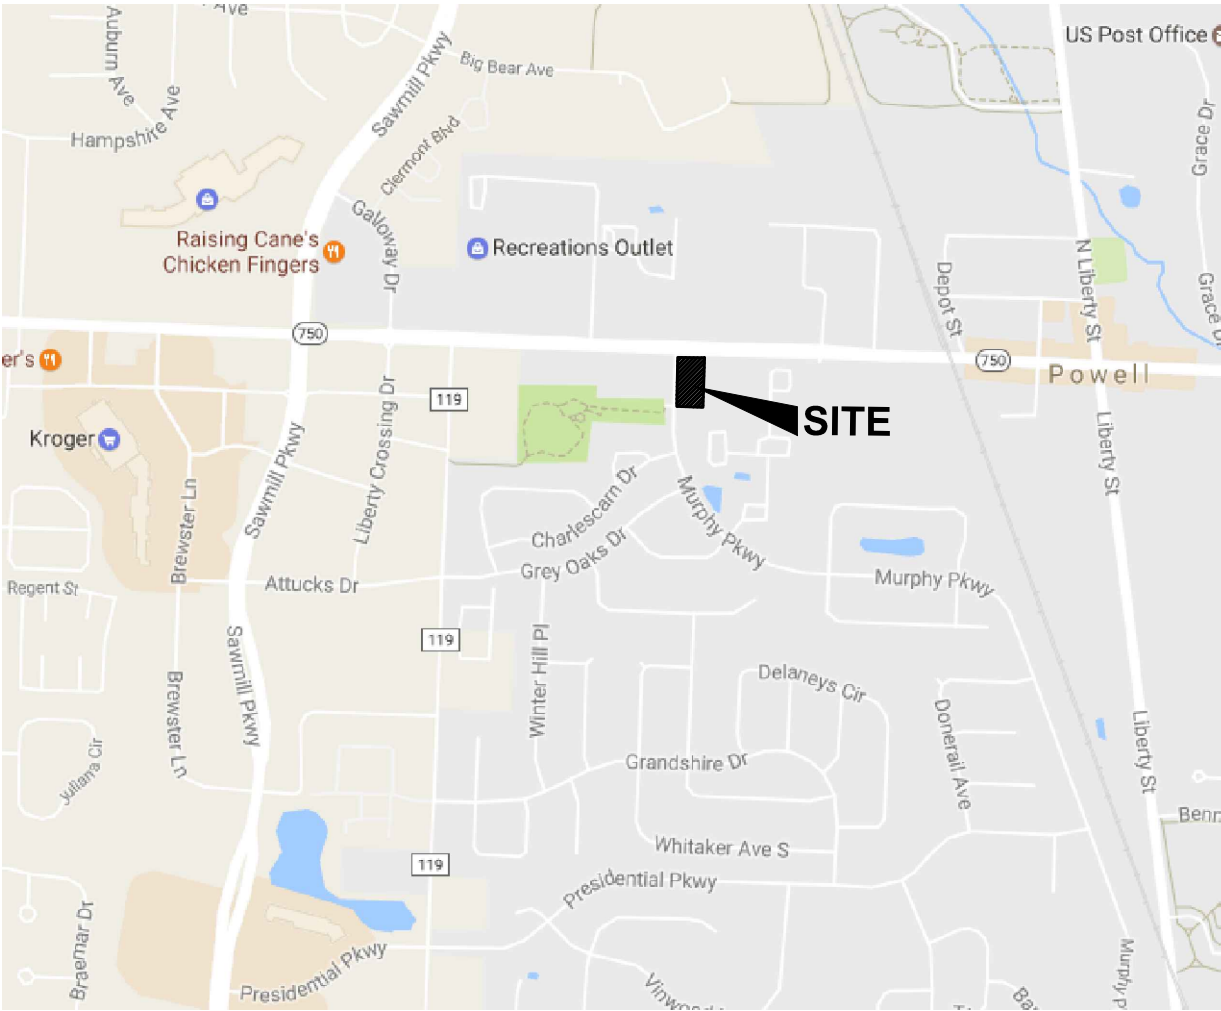


LOCATION MAP

Sheet List Table

Sheet Number	Sheet Title
1	TITLE SHEET
2	GENERAL NOTES
3	DETAILS
4	EXISTING CONDITIONS
5	SITE PLAN
6	UTILITY PLAN
7	GRADING PLAN
8	EROSION & SEDIMENTATION CONTROL NOTES



GRAPHIC SCALE

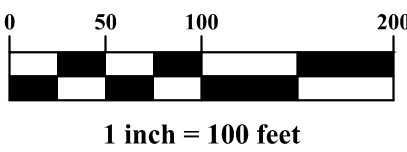

PREPARED BY:



CITY OF POWELL/ DELAWARE COUNTY, OHIO

POWELL RETAIL

FINAL DEVELOPMENT PLAN

FOR

DR. ALI KHAKSAR

TITLE SHEET

Issue Dates:

Date: 7/26/2017
Scale: N/A

Drawn By: CWH
Checked By: TMW

Project Number:
17-0011-168


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1 / 8


PLAN PREPARED BY:

PLAN PREPARED FOR:


DR. ALI KHAKSAR
5600 HEATHROW DRIVE
POWELL, OHIO 43065

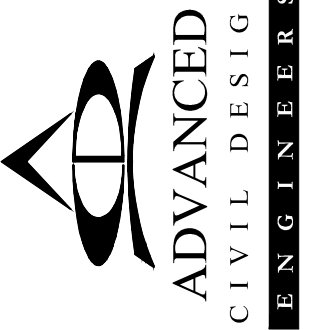


Z:\17-0011-168\DWG\PRODUCTION DRAWINGS\FINAL DEVELOPMENT PLAN\ex_cond.dwg EXISTING CONDITIONS Jul 11, 2017 - 2:46:19pm dstorck

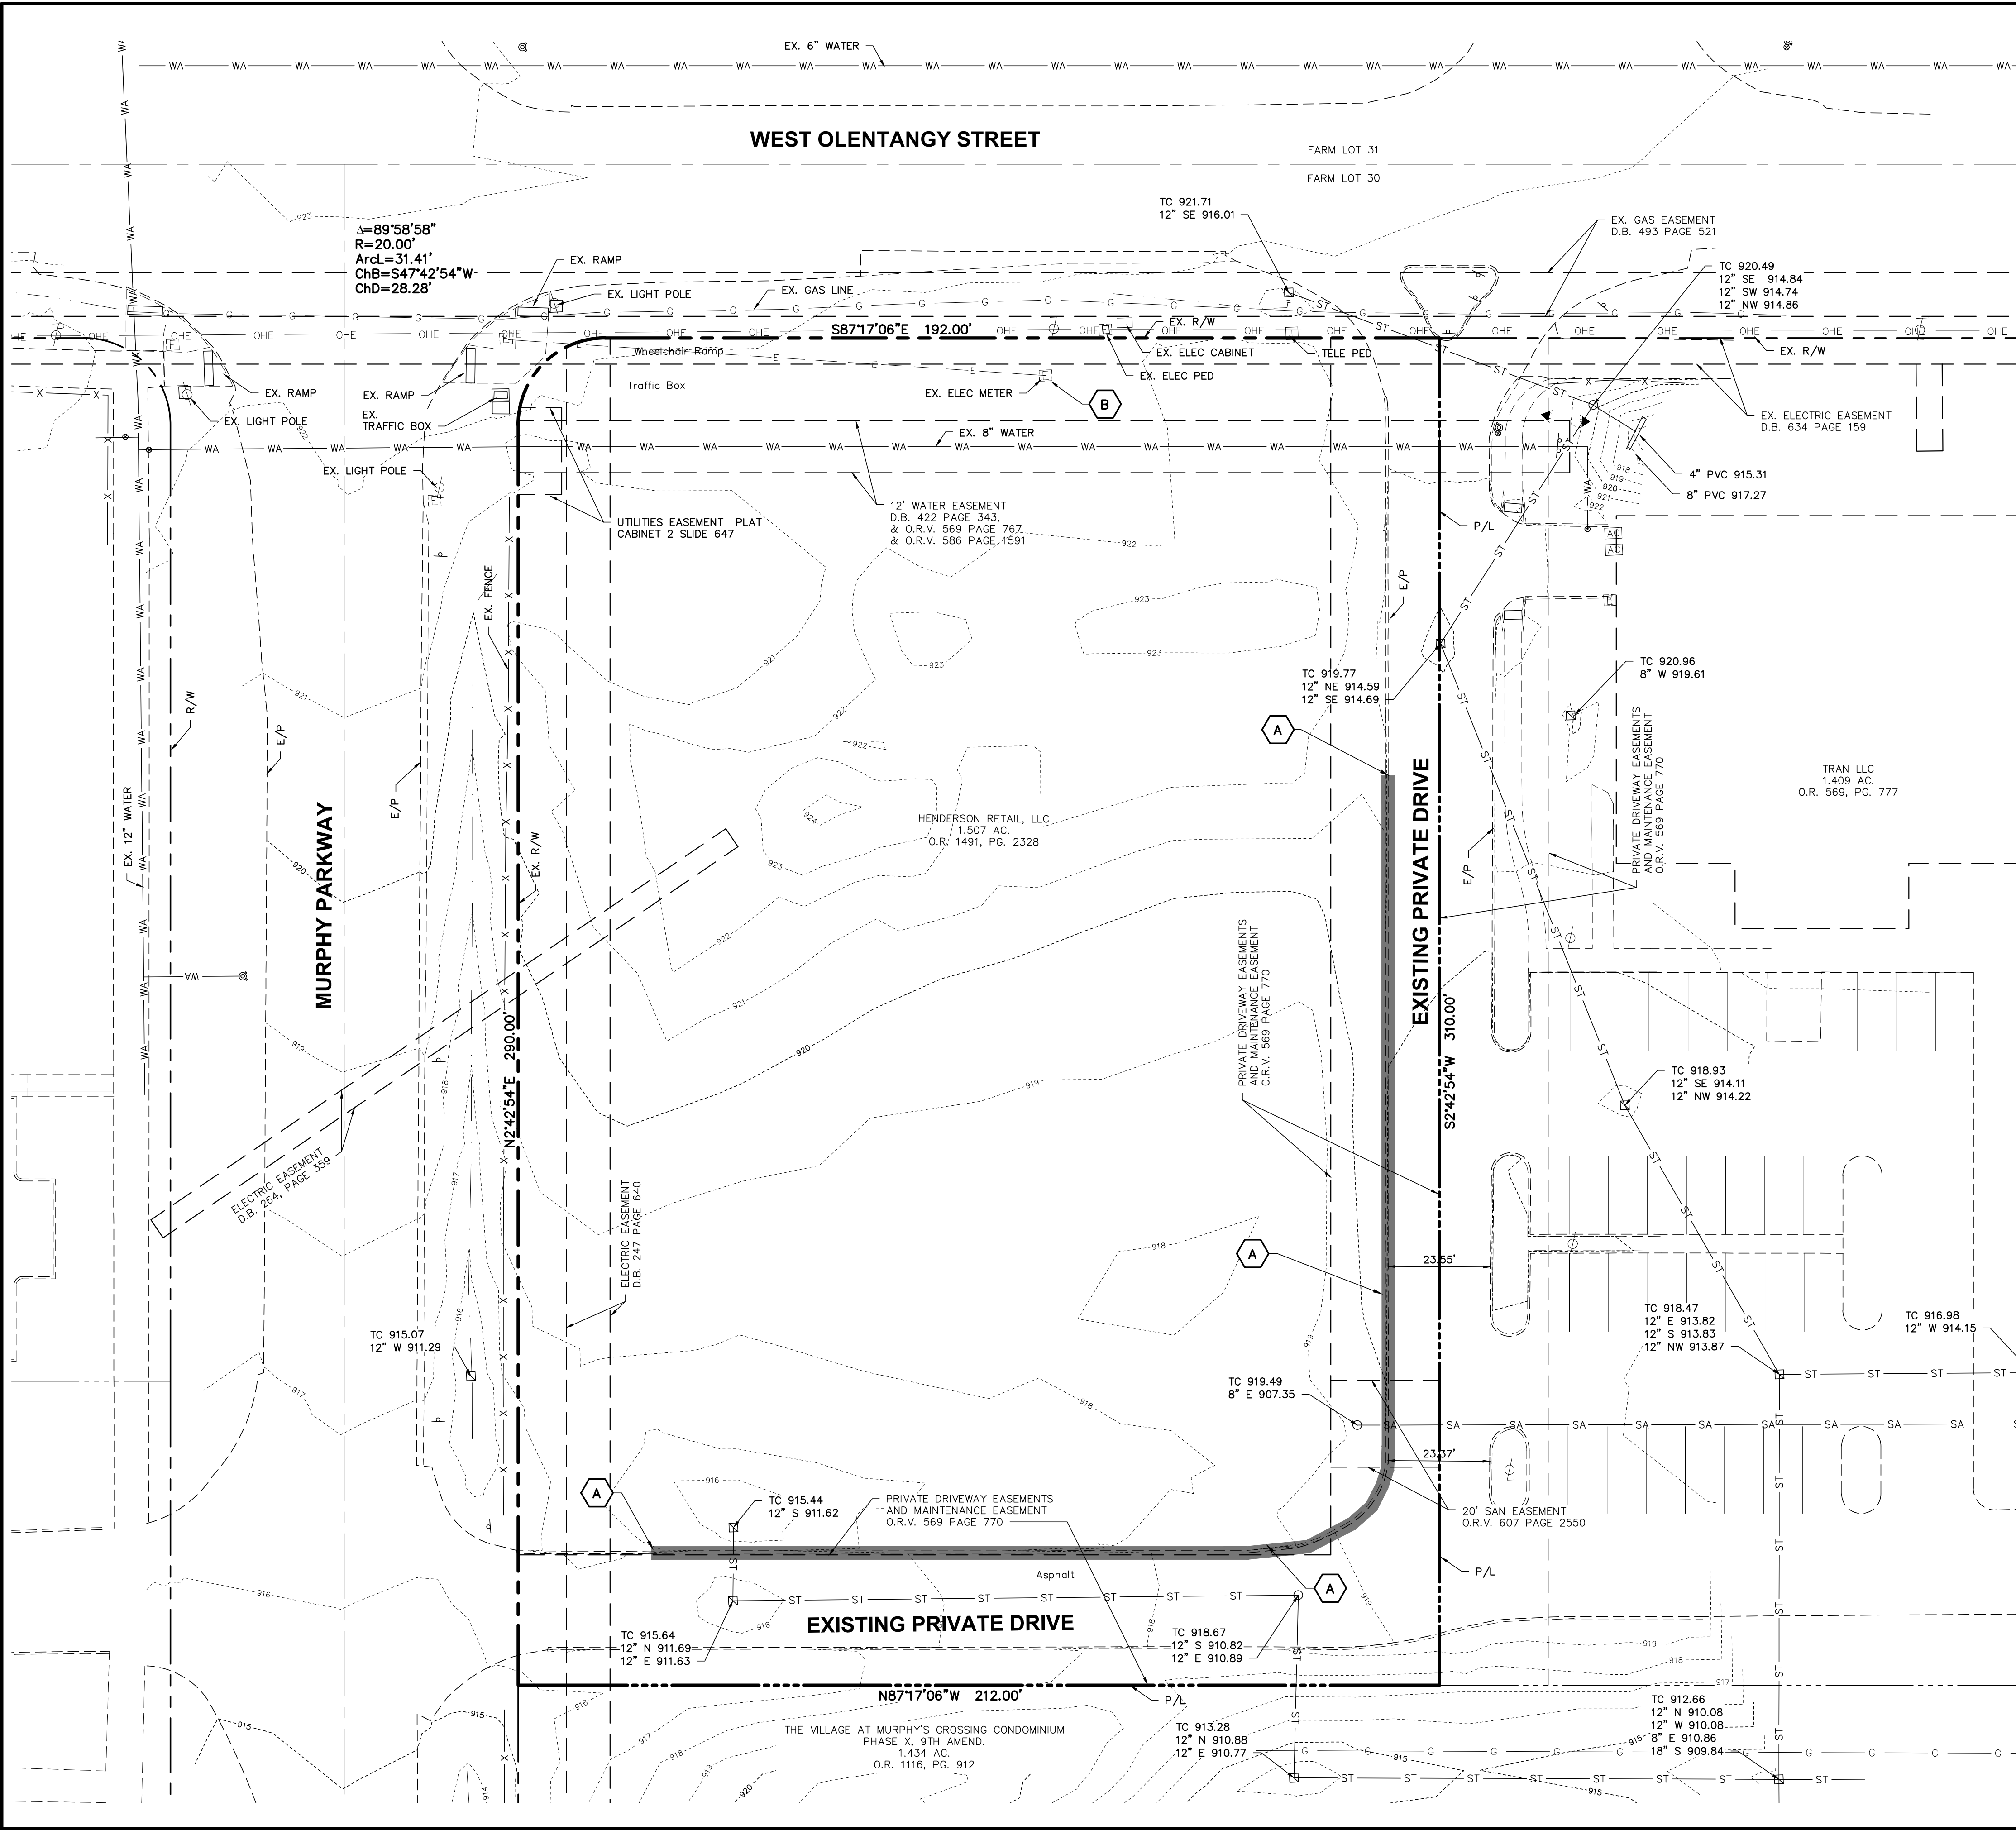

- CODED NOTES**
- A** 340' EX. CURB TO BE REMOVED & DISPOSED OF
 - B** COORDINATE REMOVAL OF EX. ELECTRIC METER WITH UTILITY PROVIDER

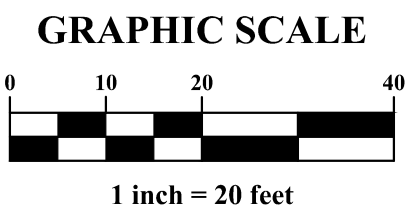

PLAN PREPARED BY: ADVANCED CIVIL DESIGN ENGINEERS	CITY OF POWELL/ DELAWARE COUNTY, OHIO	
	DR. ALI KHAKSAR 5600 HEATHROW DRIVE POWELL, OHIO 43065	
PLAN PREPARED FOR:	POWELL RETAIL FINAL DEVELOPMENT PLAN	
	FOR DR. ALI KHAKSAR	
Issue Dates:	EXISTING CONDITIONS	
Date: 7/26/2017 Scale: N/A		
Drawn By: CWH Checked By: TMW		
Project Number: 17-0011-168		
Drawing Number: 4 / 8		

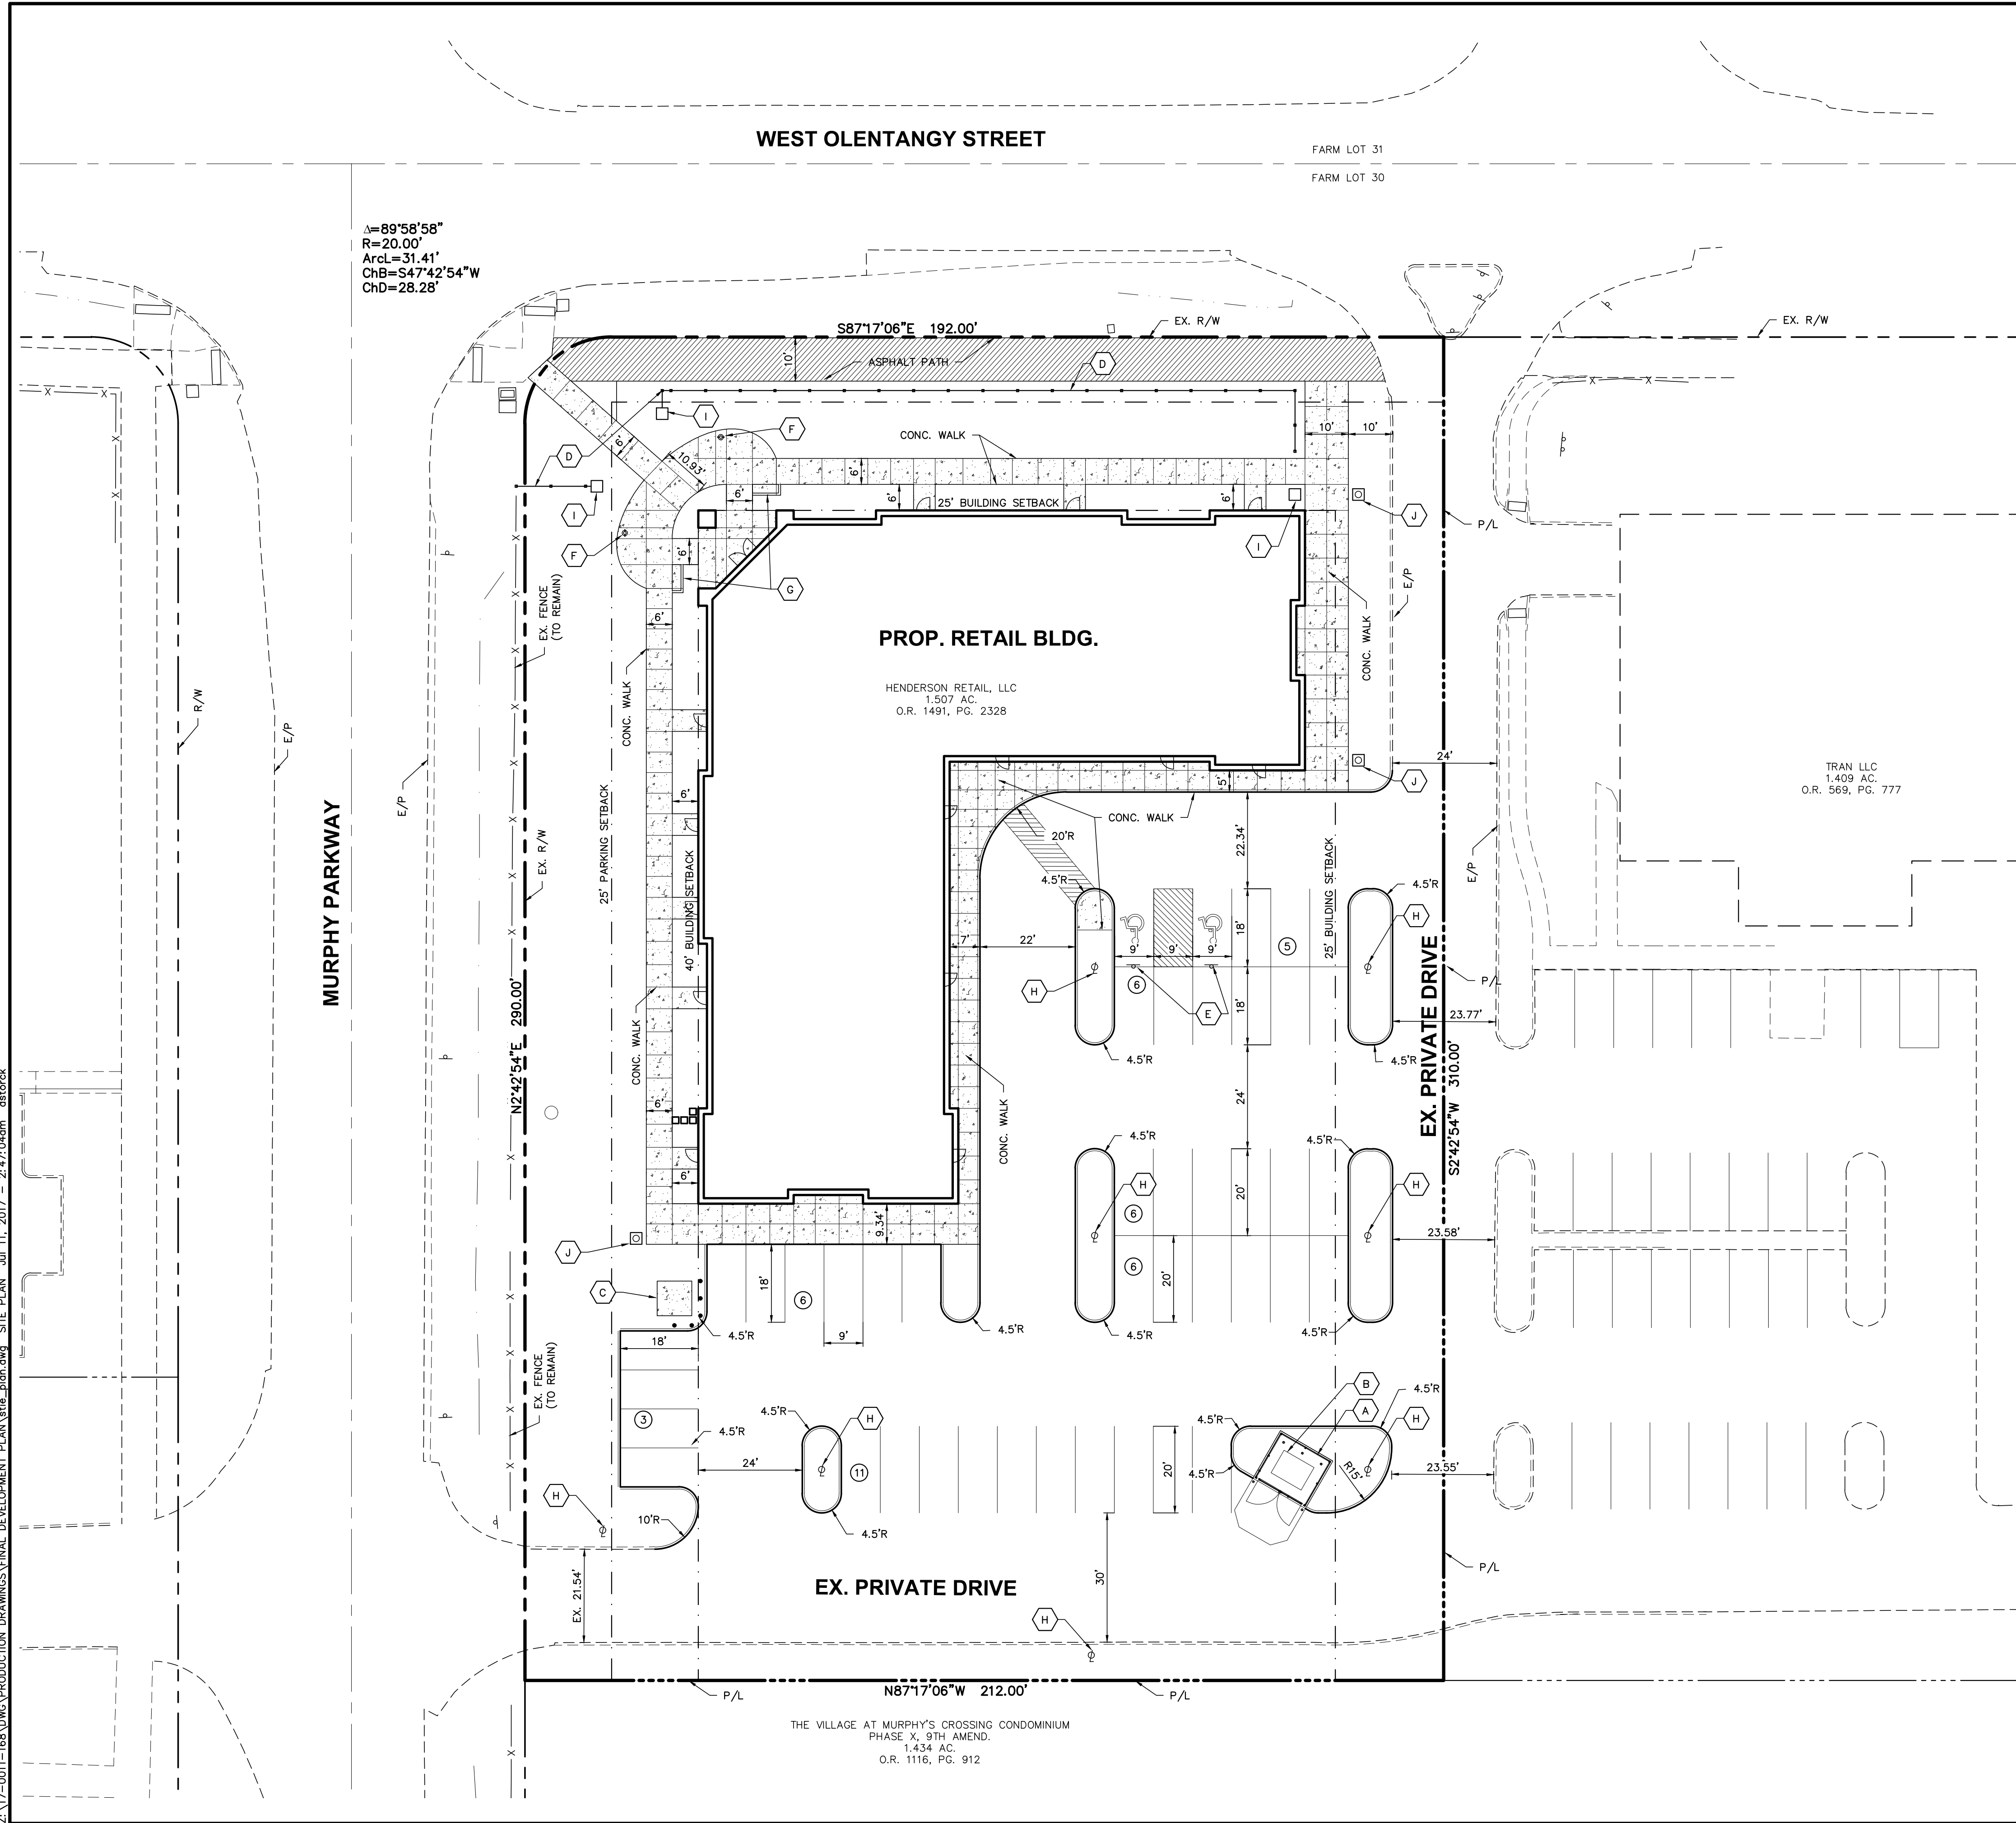


PROPOSED.....RETAIL DEVELOPMENT
ADDRESS.....0 WEST OLENTANGY STREET
PARCEL #.....31943202010012



EXISTING ZONING.....	PCD
PROPOSED ZONING.....	PCD
TOTAL SITE AREA.....	1.507 ACRES (65,665 S.F.)
BUILDING AREA.....	13,606 S.F.
PAVEMENT AREA.....	27,915 S.F.
DUMPSTER AREA.....	325 S.F.
WALK AND PATIO AREA.....	6,048 S.F.
LOT COVERAGE AREA.....	47,894 S.F. (73%)
MAX BUILDING HEIGHT.....	0'-0"

REQUIRED PARKING (5+1 PER 400 S.F. OF RETAIL).....	40 SPACES
PROVIDED PARKING.....	43 SPACES (2 HANDICAP)
REQUIRED HANDICAP SPACES.....	2 SPACES
PROVIDED HANDICAP SPACES.....	2 SPACES

BY GRAPHIC PLOTTING ONLY THIS PROPERTY IS LOCATED IN ZONE "X" (AREAS DETERMINED TO BE OUTSIDE OF THE 500-YEAR FLOOD PLAIN) BY THE FEDERAL EMERGENCY MANAGEMENT AGENCY ON FLOOD INSURANCE RATE MAP, COMMUNITY PANEL NO. 39041C0237K, WITH AN EFFECTIVE DATE OF APRIL 16, 2009, IN DELAWARE COUNTY, OHIO. NO FIELD SURVEYING WAS PERFORMED TO DETERMINE THIS ZONE.

Issue Dates:		CITY OF POWELL/ DELAWARE COUNTY, OHIO		PLAN PREPARED FOR:		PLAN PREPARED BY:	
		POWELL RETAIL FINAL DEVELOPMENT PLAN FOR DR. ALI KHAKSAR SITE PLAN		 ADVANCED CIVIL DESIGN ENGINEERS SURVEYORS		DR. ALI KHAKSAR 5600 HEATHCOTE POWELL, OHIO 43065 422 Beaker Road Gahanna, Ohio 43230 ph 614-428-7750 fax 614-428-7755	
		Date: 7/26/2017 Scale: N/A					
Drawn By:		Checked By:					
CWH		TMW					
Project Number:							
17-0011-168							
Drawing Number:							
5 / 8							

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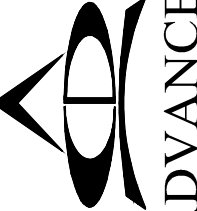
- LEGEND**
- 15" ST — PROPOSED STORM SEWER
 - SA — PROPOSED SANITARY SERVICE
 - WA — PROPOSED WATER SERVICE
 - SA — EX. SANITARY SEWER
 - ST — EX. STORM SEWER
 - WA — EX. WATERLINE
 - G — EX. GAS
 - E — EX. ELECTRIC

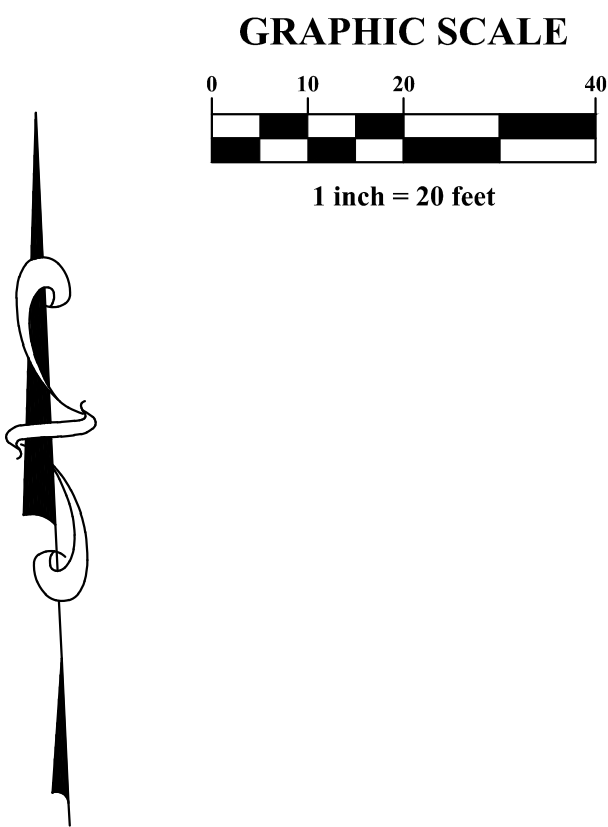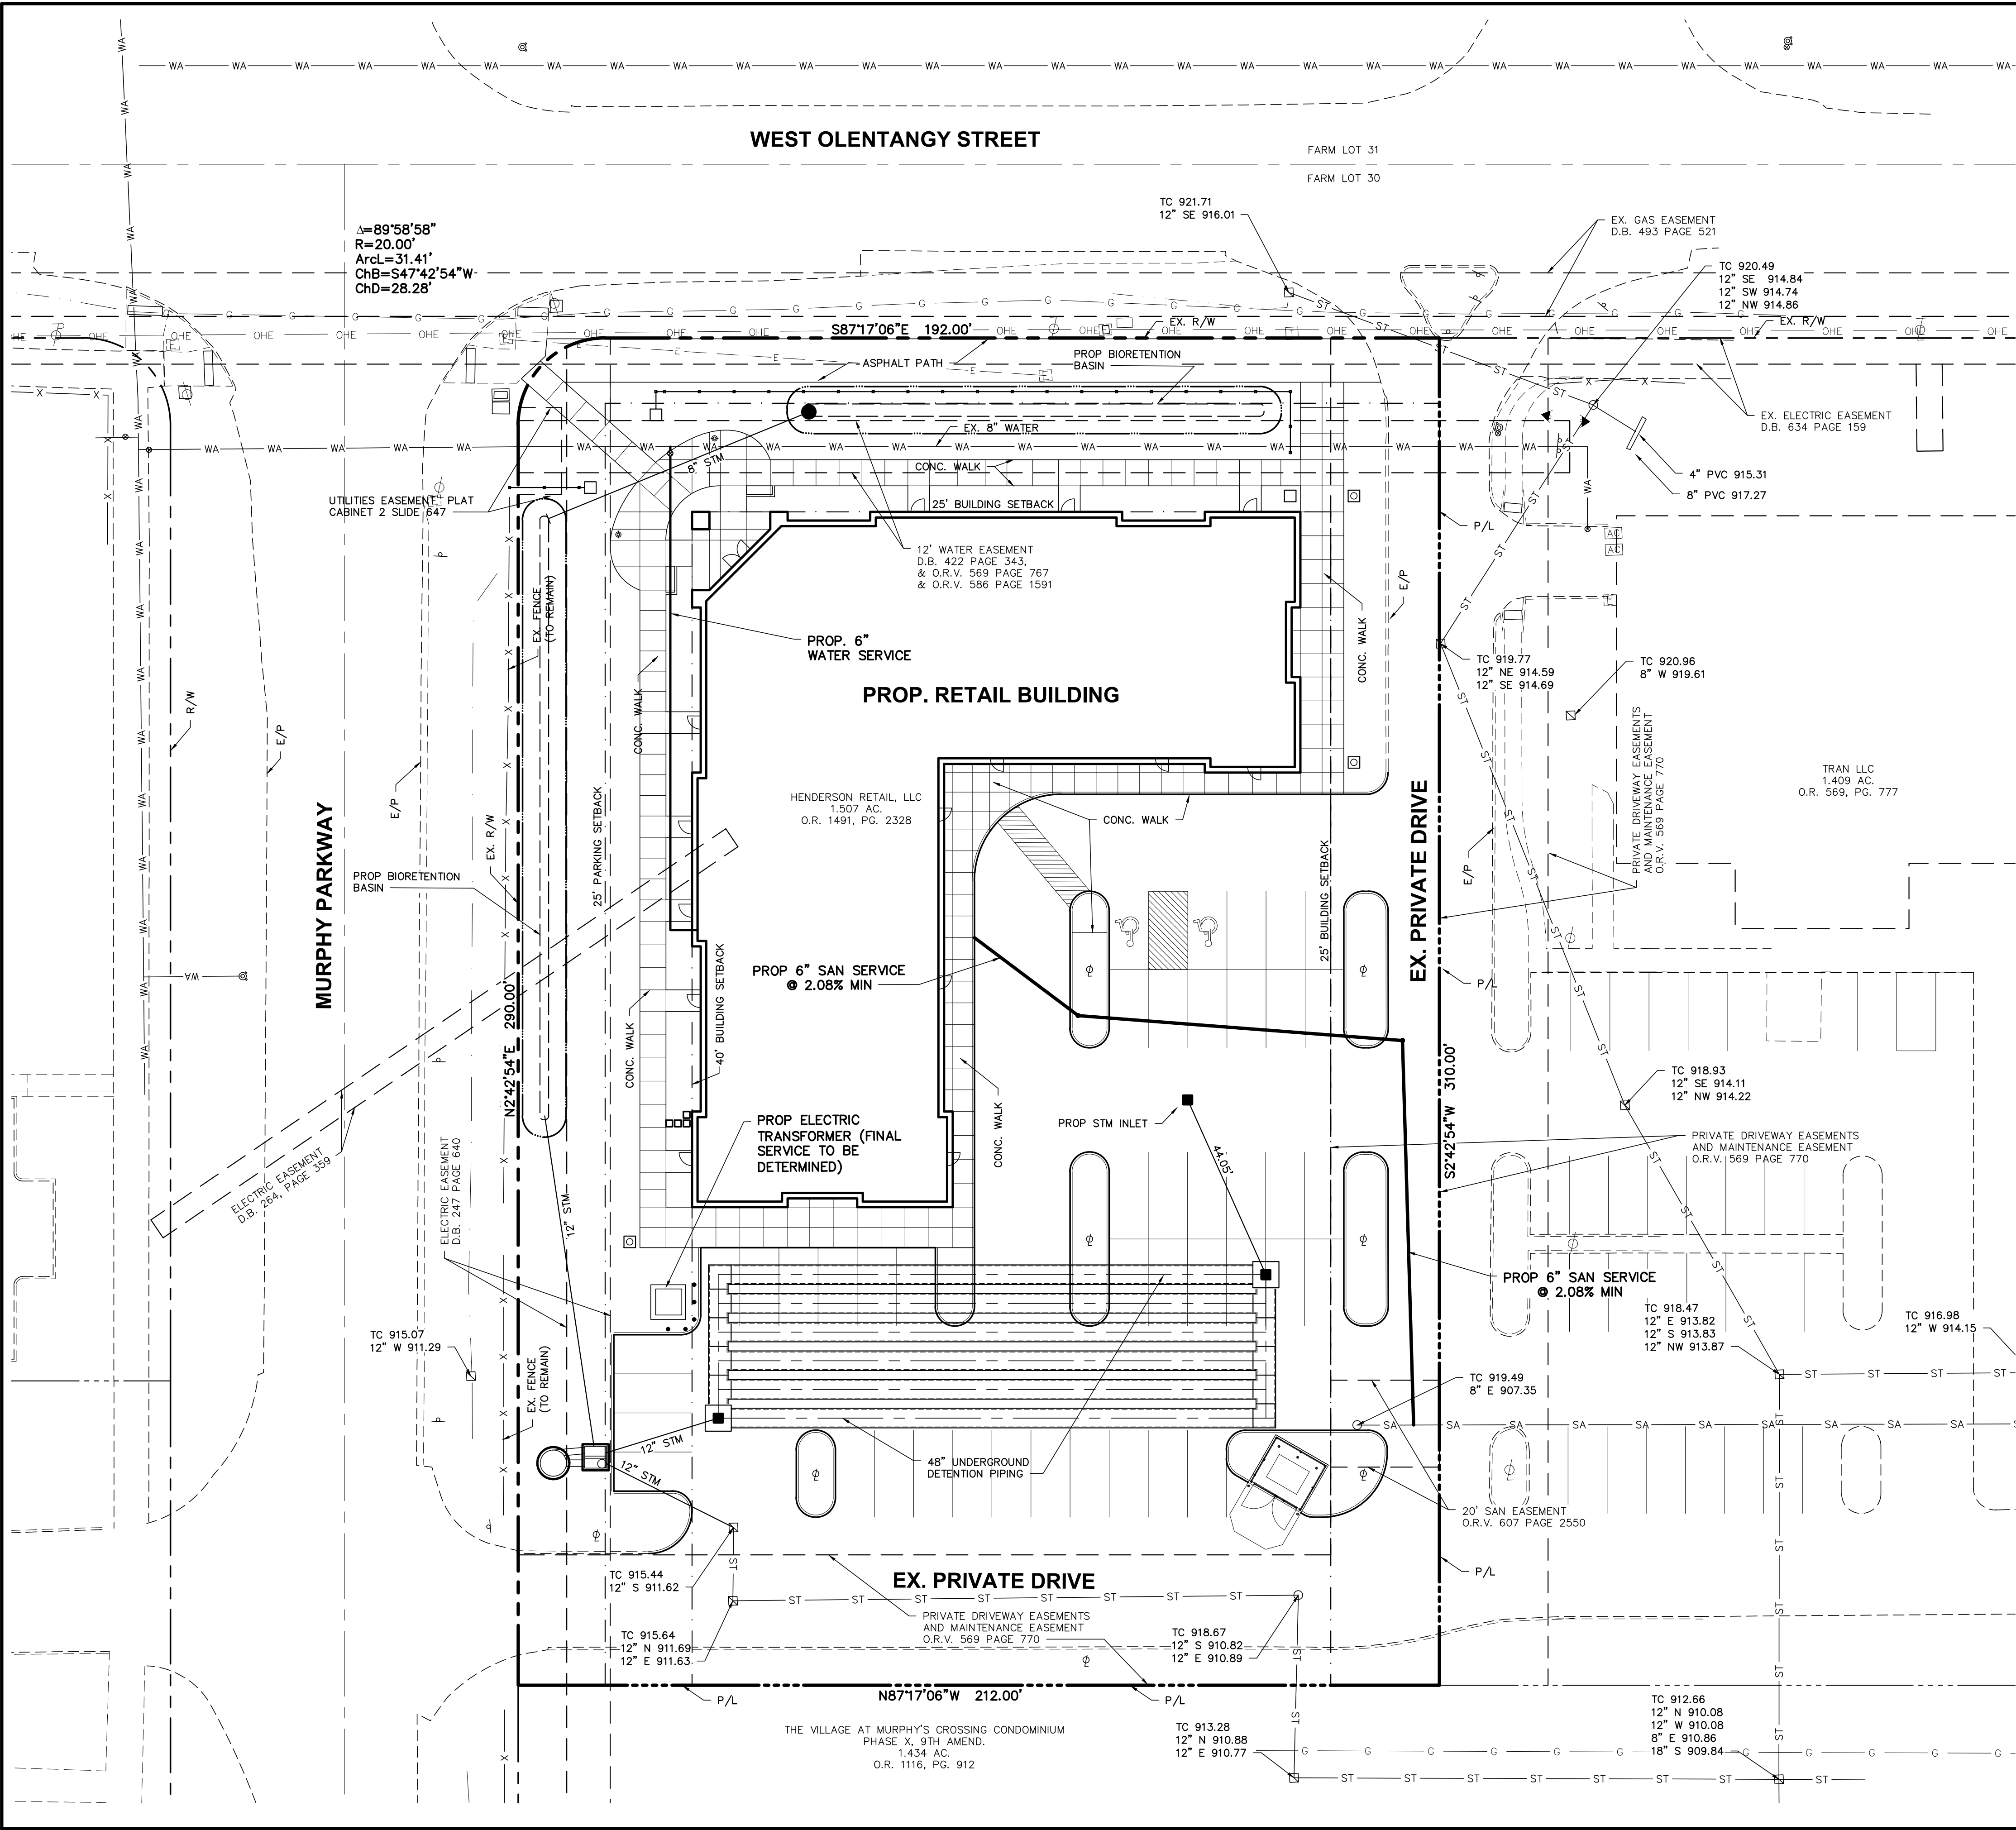Issue Dates:	CITY OF POWELL/ DELAWARE COUNTY, OHIO	
	POWELL RETAIL FINAL DEVELOPMENT PLAN	
	FOR DR. ALI KHAKSAR UTILITY PLAN	
Date:	7/26/2017	
Scale:	N/A	
Drawn By:	CWH	Checked By: TMW
Project Number:	17-0011-168	
Drawing Number:	6 / 8	


PLAN PREPARED FOR:

DR. ALI KHAKSAR
5600 HEATHROW DRIVE
POWELL, OHIO 43065

PLAN PREPARED BY:

**ADVANCED
CIVIL DESIGN
ENGINEERS & SURVEYORS**

422 Beecher Road
Galliano, Ohio 43330
ph 614.428.7750
fax 614.428.7755

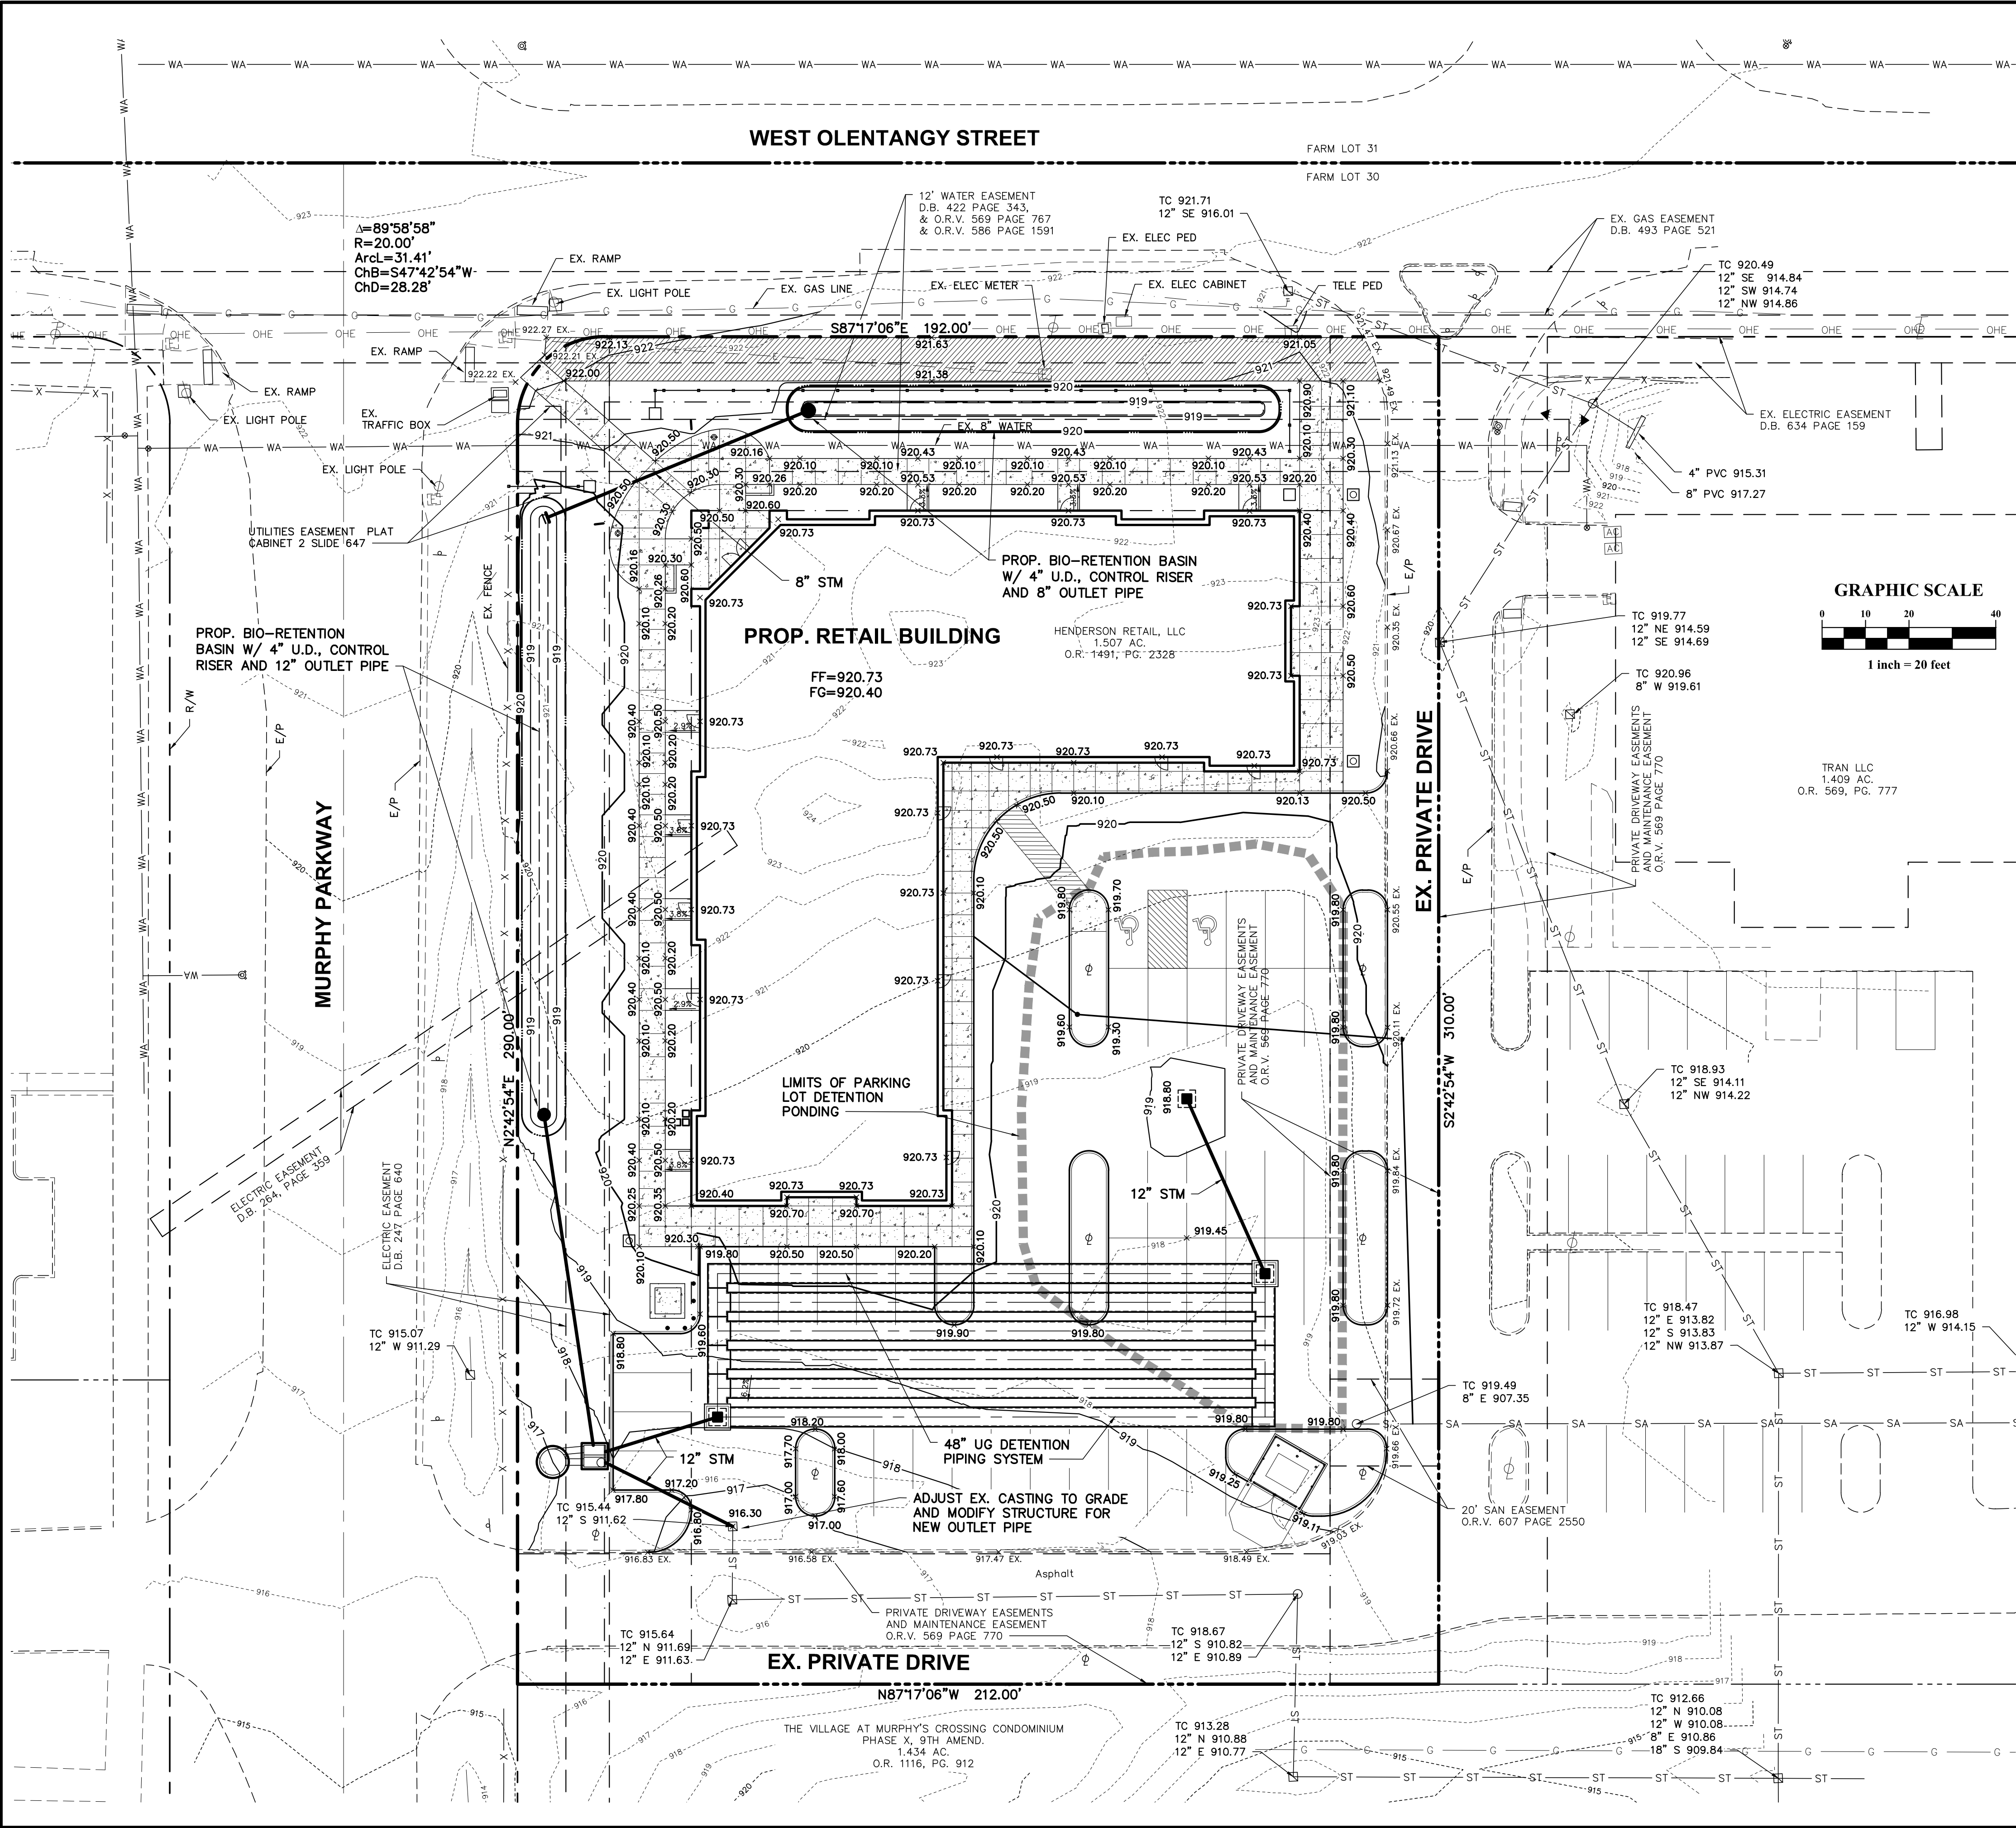

SITE GRADING NOTES

THE CONTRACTOR IS SPECIFICALLY CAUTIONED THAT THE LOCATION AND/OR ELEVATION OF EXISTING UTILITIES SHOWN ON THESE PLANS IS BASED ON RECORDS OF THE VARIOUS UTILITY COMPANIES, AND WHERE POSSIBLE, MEASUREMENTS TAKEN IN THE FIELD. THE INFORMATION IS NOT TO BE RELIED ON AS BEING EXACT OR COMPLETE. THE CONTRACTOR MUST CALL THE APPROPRIATE UTILITY COMPANIES AT LEAST 72 HOURS BEFORE ANY EXCAVATION TO REQUEST EXACT FIELD LOCATION OF UTILITIES. IT SHALL BE THE RESPONSIBILITY OF THE CONTRACTOR TO RELOCATE ALL EXISTING UTILITIES WHICH CONFLICT WITH THE PROPOSED IMPROVEMENTS SHOWN ON THE PLANS.

ALL CUT OR FILL SLOPES SHALL BE 3:1 OR FLATTER UNLESS OTHERWISE NOTED.

STORM PIPE SHALL BE AS SPECIFIED IN THE GENERAL NOTES.

EXISTING DRAINAGE STRUCTURES TO BE INSPECTED AND REPAIRED AS NEEDED. EXISTING PIPES TO BE CLEANED OUT TO REMOVE ALL SILT AND DEBRIS.

EXISTING GRADE CONTOURS SHOWN AT 1 FOOT INTERVALS.

PROPOSED GRADE CONTOURS SHOWN AT 1 FOOT INTERVALS.

ALL STORM PIPE ENTERING STRUCTURES SHALL BE GROUTED TO ASSURE CONNECTION AT STRUCTURE IS WATERTIGHT.

ALL STORM SEWER STRUCTURES IN PAVED AREAS SHALL BE FLUSH WITH PAVEMENT, AND SHALL HAVE TRAFFIC BEARING RING & COVERS. LIDS SHALL BE LABELED "STORM SEWER".


CONTRACTOR SHALL ADJUST AND/OR CUT EXISTING PAVEMENT AS NECESSARY TO ACHIEVE A SMOOTH FIT AND CONTINUOUS GRADE.





CONTRACTOR SHALL ASSURE POSITIVE DRAINAGE AWAY FROM BUILDINGS FOR ALL NATURAL AND PAVED AREAS.

CONSTRUCTION SHALL COMPLY WITH ALL APPLICABLE GOVERNING CODES AND BE CONSTRUCTED TO SAME.

ELEVATIONS SHOWN HEREIN ARE SHOWN ON NORTH AMERICAN VERTICAL DATUM (NAVD) 1988.

ALL SPOT ELEVATIONS SHOWN ARE FINISHED GRADE/TOP OF PAVEMENT UNLESS OTHERWISE NOTED. TOP OF CURB ELEVATIONS DENOTED AS TC XXX.



-----940-----	EXISTING CONTOUR
—— 913 ——	PROPOSED CONTOUR
TC=795.20	TOP OF CASTING ELEVATION
X TC 795.20	TOP OF CURB ELEVATION
X 795.20	TOP OF PAVEMENT OR GROUND SURFACE
x 795.20 Ex	EXISTING TOP OF PAVEMENT OR GROUND SURFACE
 15" ST	PROPOSED STORM SEWER
 SA	PROPOSED SANITARY SERVICE
—— WA ——	PROPOSED WATER SERVICE
	SURFACE FLOW ARROW
	MAJOR FLOOD ROUTING PATH (GREATER THAN 100 YR EVENT)

STORMWATER CONTROL NARRATIVE

SITE SUMMARY:

THE SUBJECT PROJECT POWELL RETAIL CONSISTS OF A SINGLE PARCEL (3194320201002) TO BE DEVELOPED INTO COMMERCIAL RETAIL SPACE WITH ASSOCIATED PARKING. THE SITE IS BOUND BY WEST OLENTANGY ROAD TO THE NORTH, COMMERCIAL PROPERTY TO THE EAST, MURPHY PARK SUBDIVISION TO THE SOUTH, AND WEST PARKWAY TO THE WEST. THE SITE IS APPROXIMATELY 1,607 ACRES CONSISTING OF OPEN GRASS SPACE AND ASPHALT DRIVE AISLE. THE PROPOSED SITE IMPROVEMENTS INCLUDE A NEW COMMERCIAL RETAIL BUILDING WITH ASSOCIATED PARKING LOT.

EXISTING CONDITIONS:

EXISTING DRAINAGE CONDITIONS WERE EVALUATED USING A COMBINATION OF AERIAL PHOTOGRAPHS, SURVEYED TOPOGRAPHY, SOIL MAPS, AND SITE PHOTOS. THE NATURAL RESOURCE CONSERVATION SERVICE WEB SOIL SURVEY IDENTIFIES THE PREDOMINANT ON-SITE SOILS AS BLOUNT SILT-LOAM, GLYNNWOOD SILT-LOAM, AND UDORFTHS CLAYE-YE-URBAN LAND-COMPLEX. THESE SOILS ARE CLASSIFIED WITH HYDROLOGIC GROUP 'D'.

THE EXISTING SITE PREDOMINANTLY DRAINS TO THE SOUTH INTO AN EXISTING STORM SEWER AND CONVEYED TO AN EXISTING DETENTION SYSTEM. THE EXISTING DOWNSTREAM DETENTION SYSTEM DESIGN DID NOT INCLUDE STORAGE VOLUME OR WATER QUALITY TREATMENT FOR THE PROPOSED SITE. APPROXIMATELY 0.237 ACRES OF THE SITE (EXISTING ASPHALT DRIVE AISLE) WAS INCLUDED IN THE STORMWATER MANAGEMENT CALCULATIONS FOR THE BEST FRIENDS VETERINARY HOSPITAL.

ALLOWABLE RELEASE RATE:

PER THE CITY OF POWELL'S STORMWATER DESIGN GUIDANCE DOCUMENT THE ALLOWABLE RELEASE RATE FOR THE PROPOSED SITE FOR A 200-YR POST-DEVELOPED STORM MUST BE BELOW OR EQUAL TO 0.40 CFS PER ACRE.

STORM WATER QUANTITY CONTROL:

EXCESS RUNOFF FROM THE PROPOSED POWELL RETAIL SITE WILL BE STORED IN 48" UNDERGROUND PIPING, 2 SMALL DETENTION BASINS AND PARKING LOT STORAGE WITH THE RELEASES CONTROLLED BY SEPARATE ORIFICE PLATES WITH OPENINGS SIZED TO MEET THE CITY POST-DEVELOPED FLOW REQUIREMENTS.

STORM WATER QUALITY CONTROL:

PER THE OHIO EPA GENERAL CONSTRUCTION PERMIT, A STORMWATER BEST MANAGEMENT PRACTICE (BMP) IS REQUIRED TO TREAT THE FIRST FLUSH RUNOFF VOLUME PRODUCED BY A 3/4" RAINFALL EVENT, THE WQ TREATMENT FACILITY, OUTPUT STRUCTURES WITHIN THE SYSTEM PROVIDE PEAK FLOW CONTROL, AND TREATMENT OF CAPTURED WATER TO COMPLY WITH CITY OF POWELL'S PEAK FLOW CONTROL REQUIREMENTS AND OHIO EPA WATER QUALITY REGULATIONS.

CONCLUSION:

THE PROPOSED DEVELOPMENT WILL PROVIDE SURFACE AND SUBSURFACE STORMWATER CONVEYANCES TO CARRY RUNOFF SAFELY THOUGH THE SITE TOWARDS THE ONSITE DETENTION AND WATER QUALITY TREATMENT FACILITY. OUTPUT STRUCTURES WITHIN THE SYSTEM PROVIDE PEAK FLOW CONTROL, AND TREATMENT OF CAPTURED WATER TO COMPLY WITH CITY OF POWELL'S PEAK FLOW CONTROL REQUIREMENTS AND OHIO EPA WATER QUALITY REGULATIONS.



NORTH ELEVATION





SOUTH ELEVATION




WEST ELEVATION



EAST ELEVATION

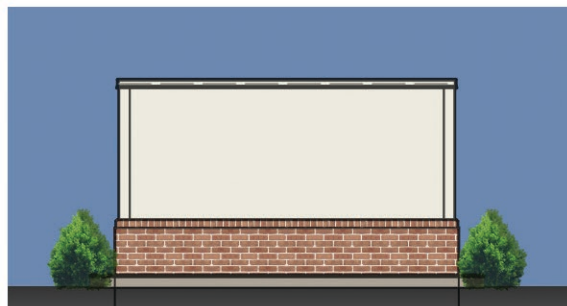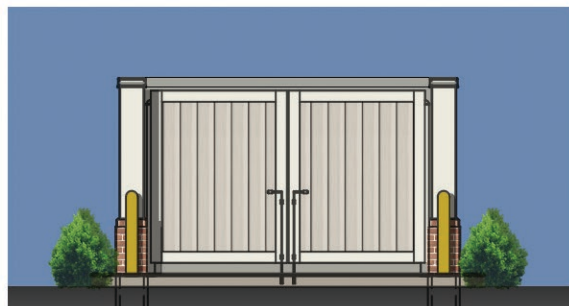

DUMPSTER ENCLOSURE ELEVATIONS

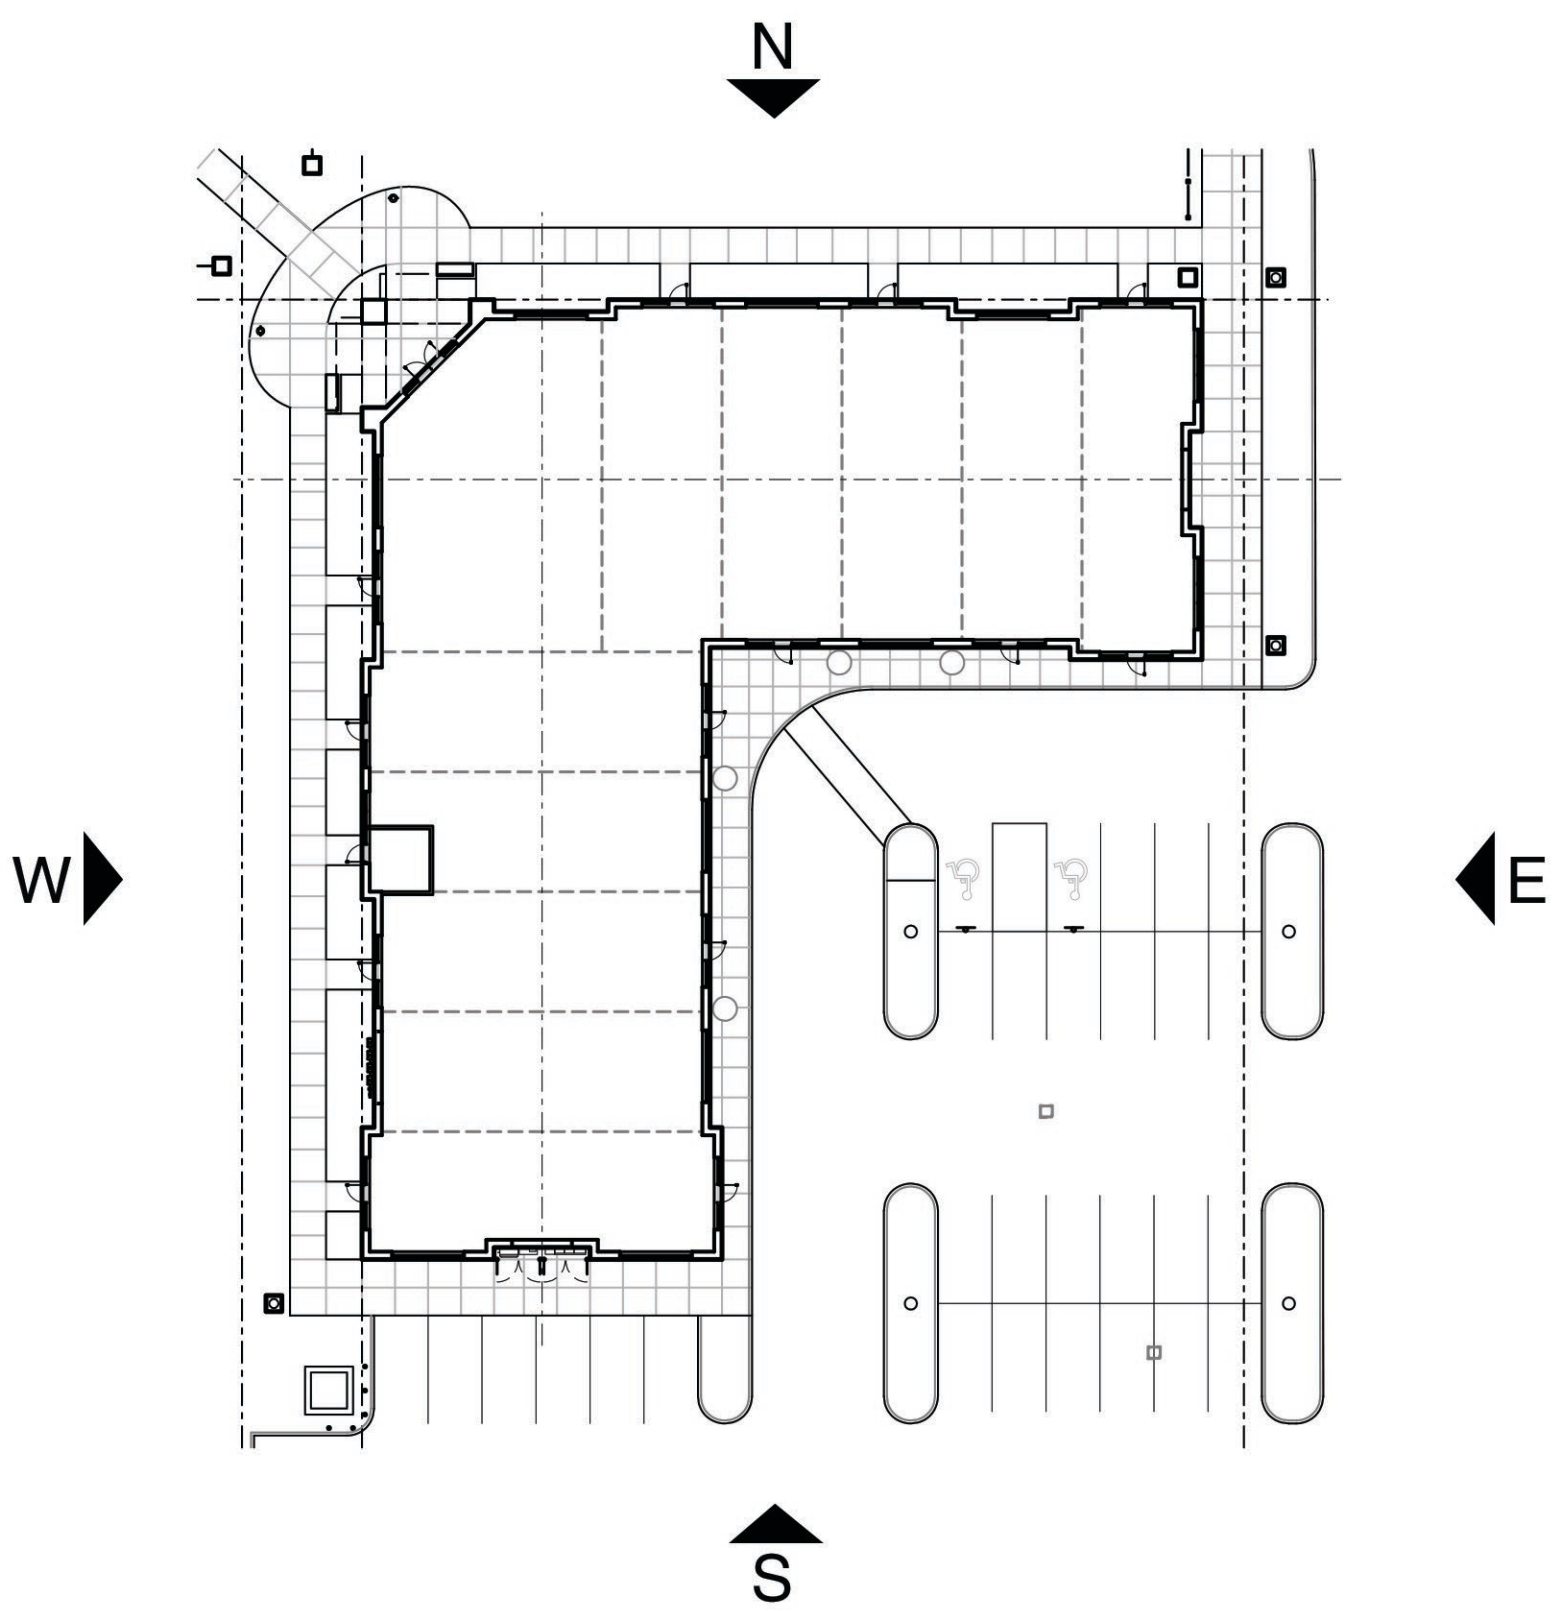

KEY PLAN




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BUILDING ELEVATIONS

17069.00

A-2.1

DOWELL RETAIL

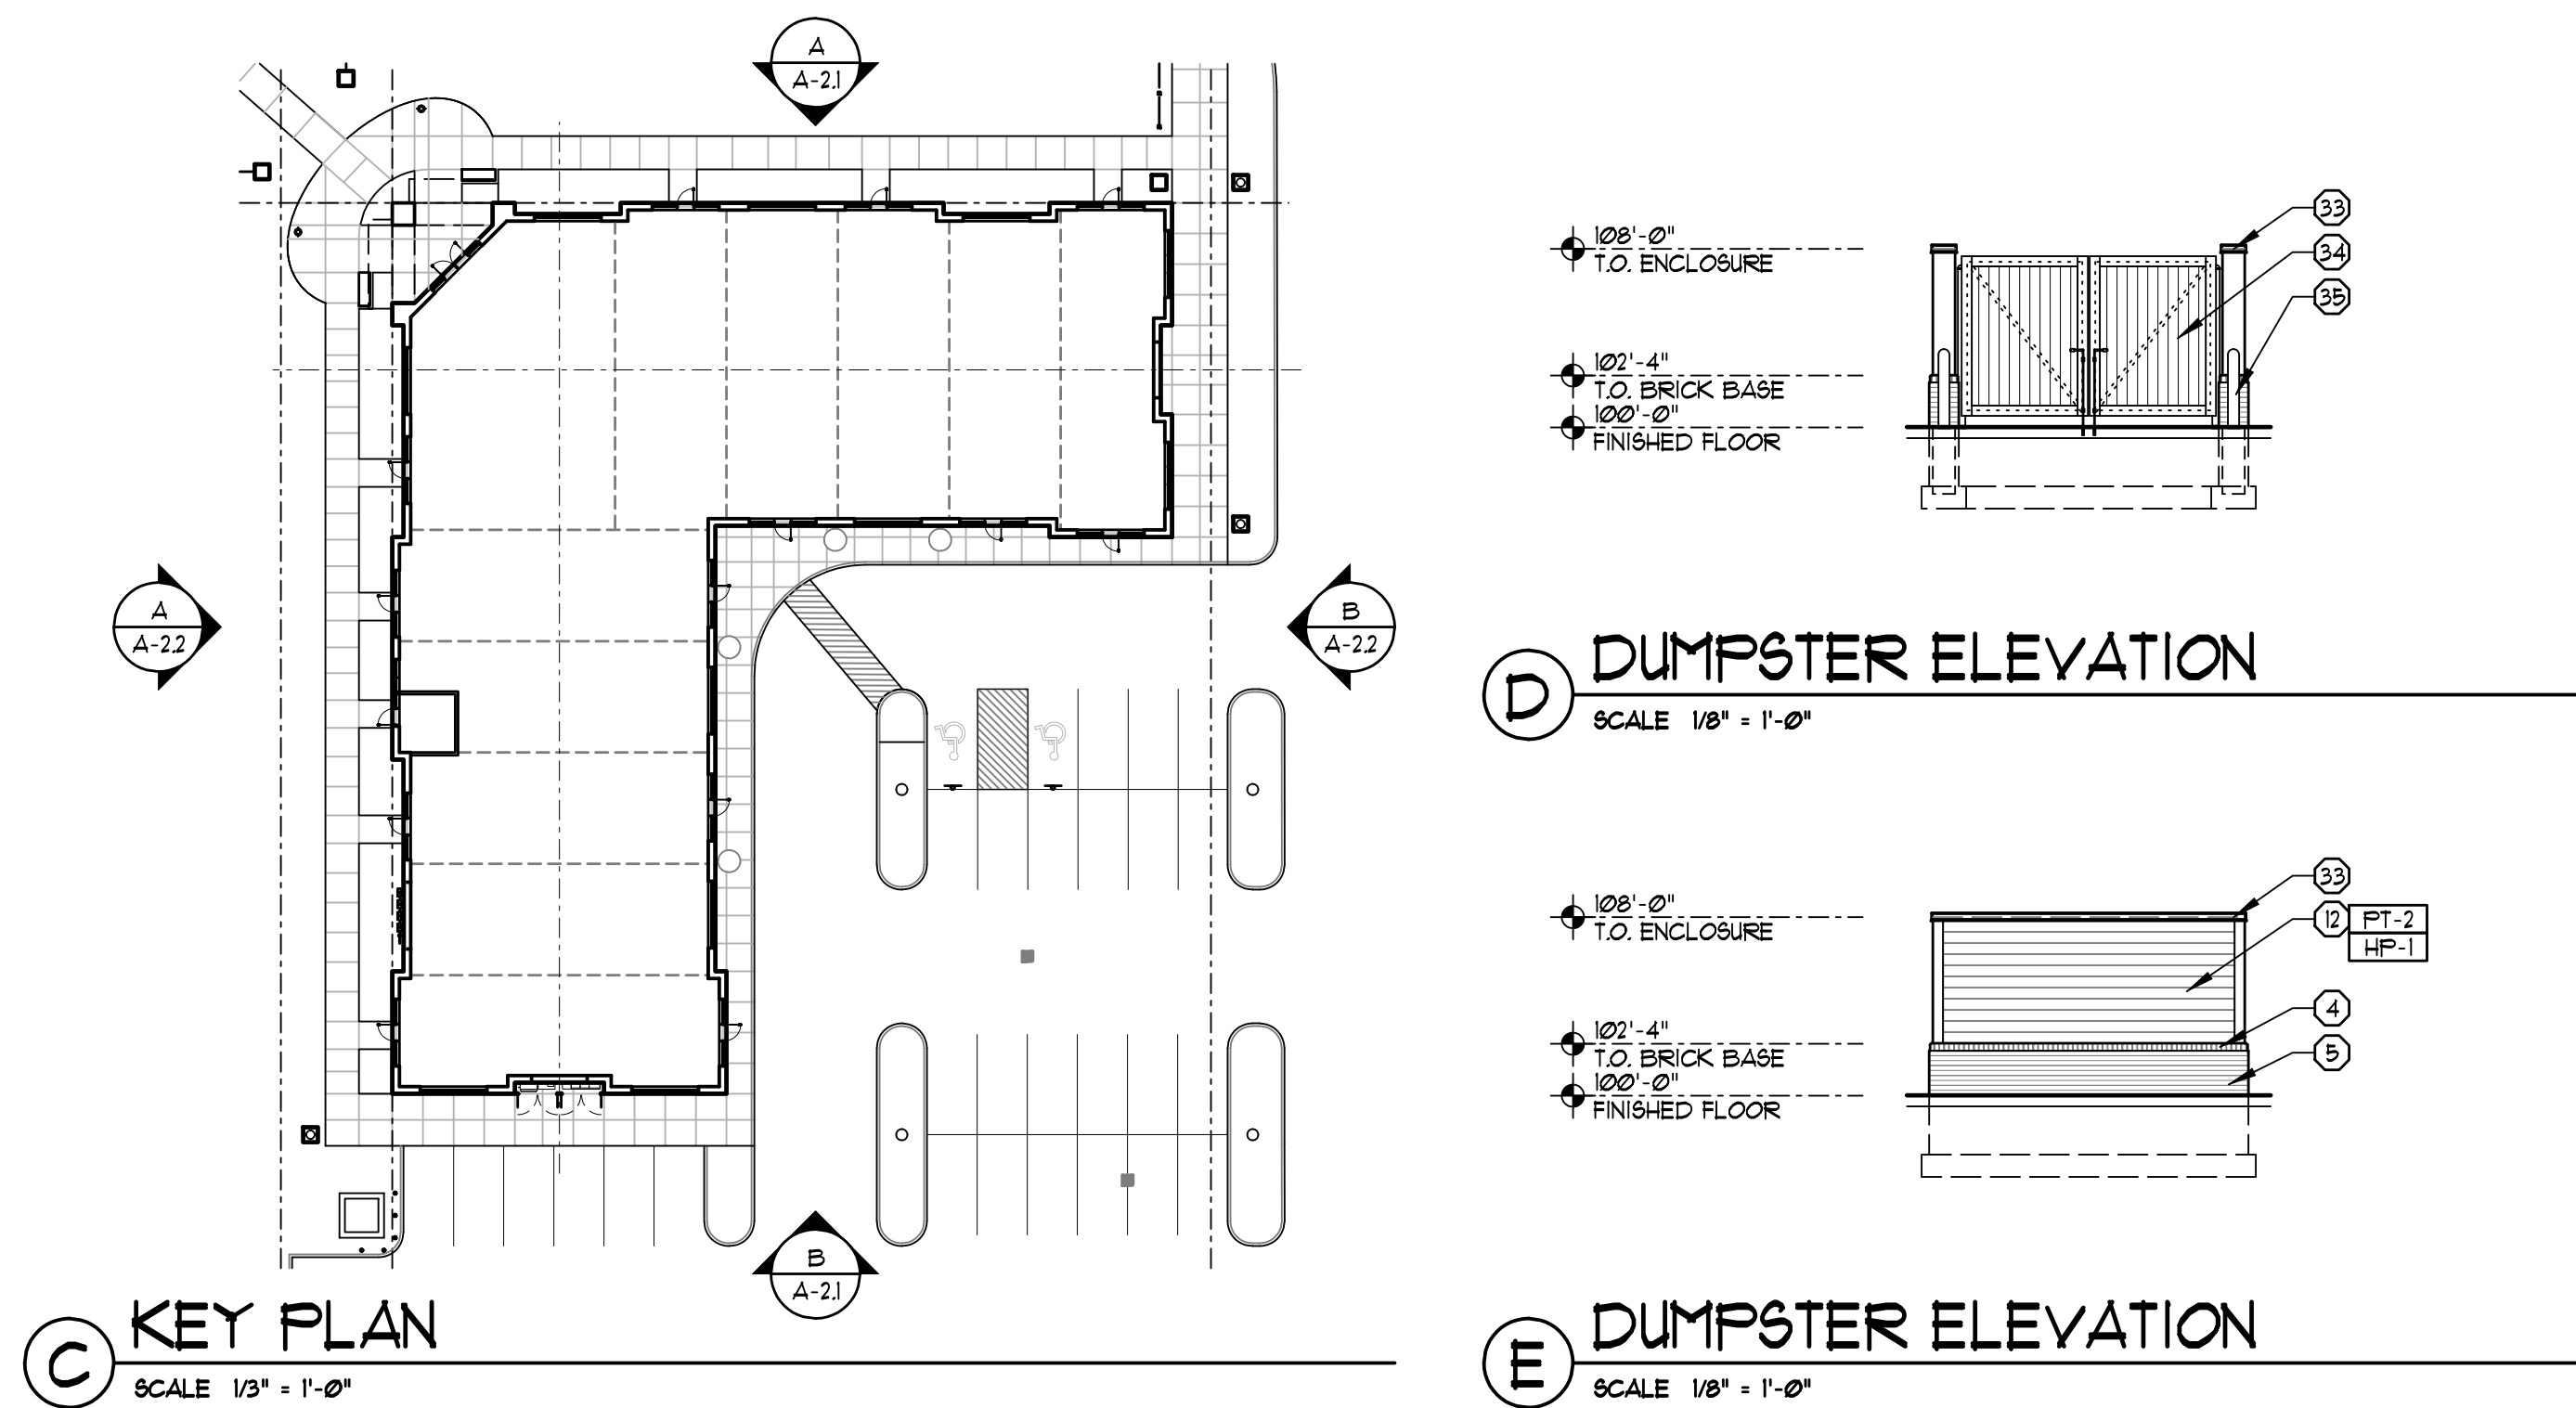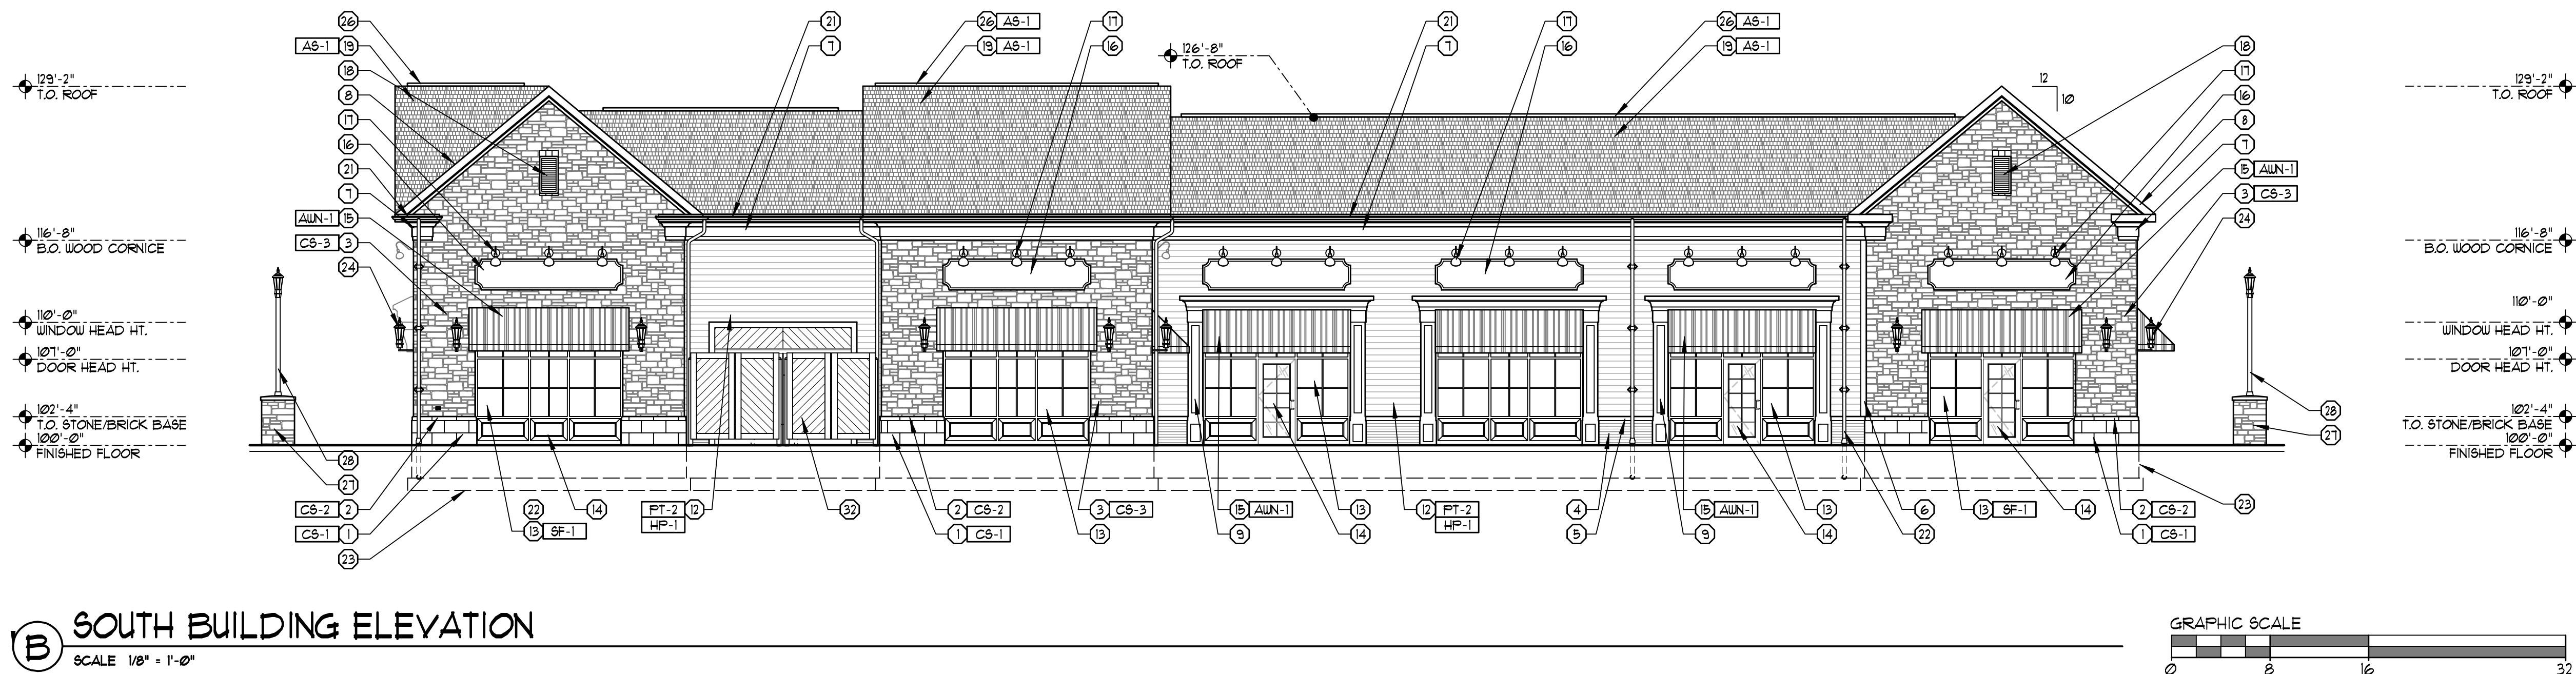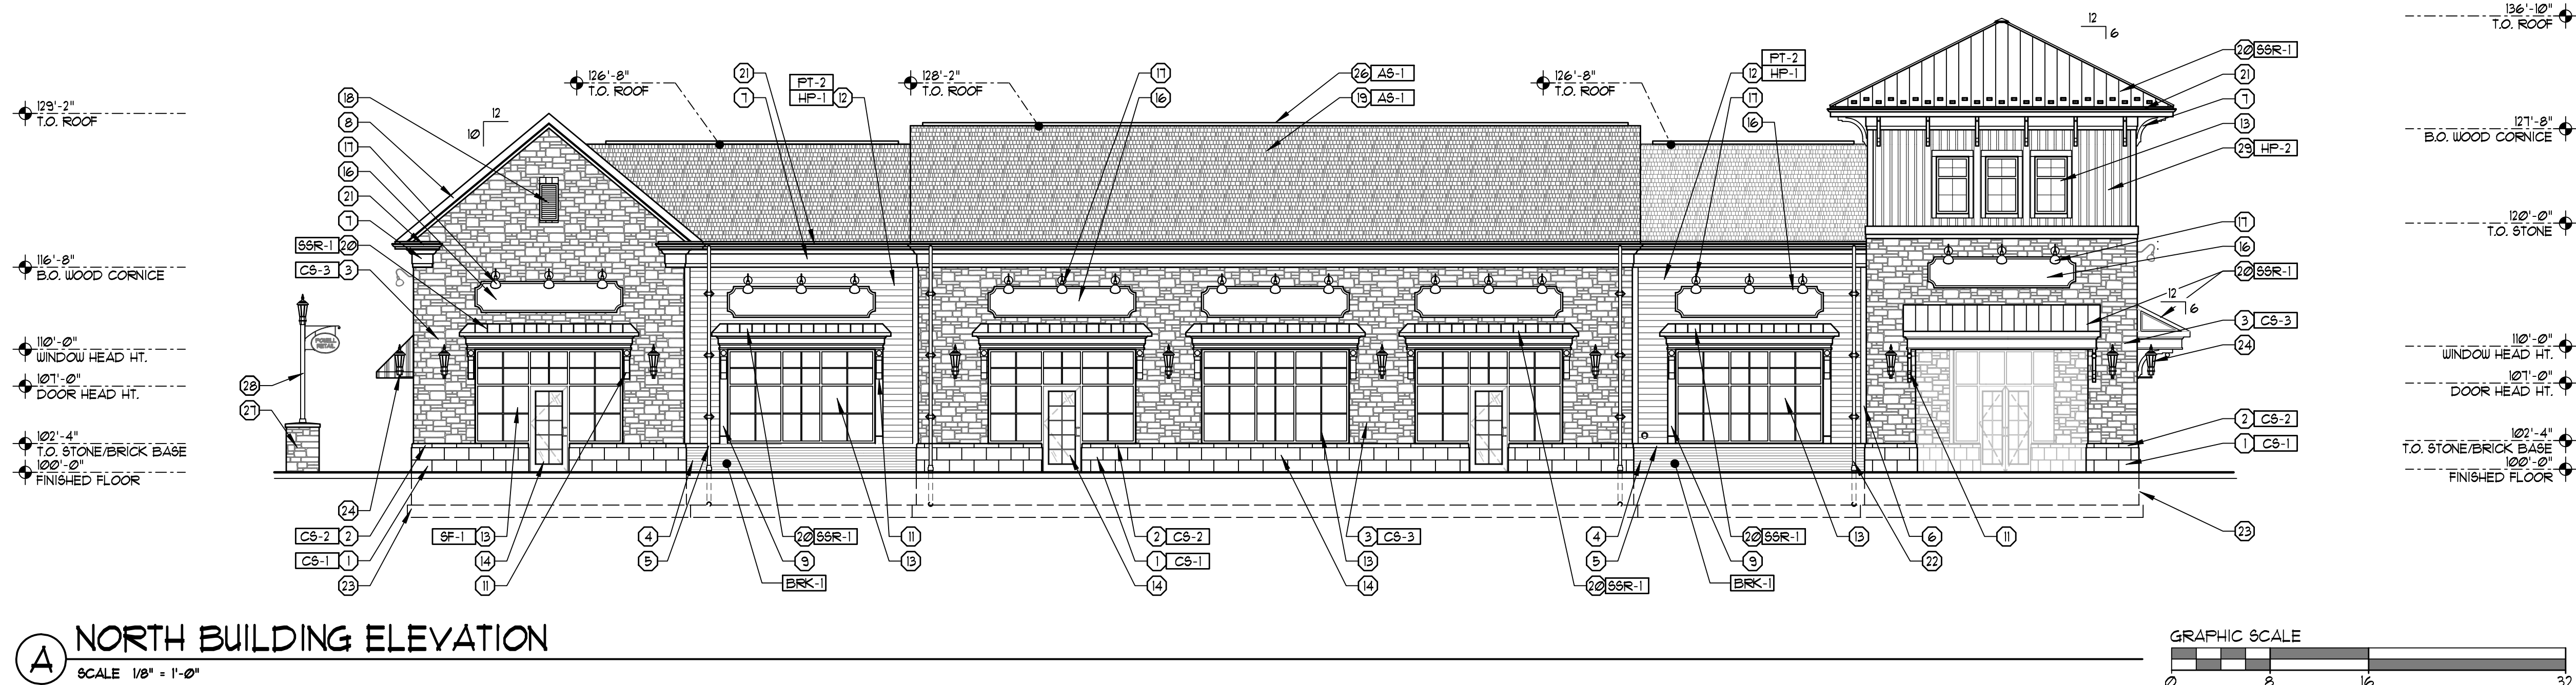

MATERIAL FINISH KEY		
MARK	TYPE	NOTES
AS-1	FIBERGLASS ASPHALT SHINGLES	CERTAINTED LANDMARK SERIES COLOR - HEARTHSTONE.
AUN-1	FABRIC AWNING	TO BE SELECTED BY TENANT
BRK-1	BRICK VENEER - RUNNING BOND	BELDEN BELCREST MODULAR 530A MORTAR - RICHOLOR 54E
CS-1	CAST STONE BASE	ROCKCAST BY READING ROCK (ST203) CHISELED FACE, COLOR - WHEATSTONE. MORTAR - RICHOLOR 51W.
CS-2	CAST STONE BASE TABLE	ROCKCAST BY READING ROCK (ST204 w/ ONE CHAMFERED EDGE) SMOOTH FACE, COLOR - WHEATSTONE. MORTAR - RICHOLOR 51W.
CS-3	CULTURED STONE VENEER	STONECRAFT INDUSTRIES - HERITAGE OLD OHIO MORTAR - RICHCOLOR 51W
HP-1	HARDI-PLANK SIDING	6" EXPOSURE HARDI-PLANK LAP SIDING BY JAMES HARDIE. SMOOTH FACE.
HP-2	HARDI-PLANK VERTICAL BATTEN SIDING	8" OC. BATTEN SPACING - HARDIE/PANEL BY JAMES HARDIE. SMOOTH FACE.
MTL-1	PREFINISHED METAL GUTTERS AND DOWNSPOUTS	DM1 - 'PUTTY'
PT-1	PAINT - WOOD TRIM	SW 1000 ALABASTER
PT-2	PAINT - HARDI-PLANK SIDING	SW 6030 FACER WHITE
GF-1	ALUMINUM STOREFRONT SYSTEM (AT STONE VENEER)	KAWNEER TRIFAB CG451T SERIES, 2" x 4 1/2" WITH 1" INSULATED GLASS. COLOR - CHARCOAL.
GF-2	ALUMINUM STOREFRONT SYSTEM (AT HARDI PLANK SIDING)	KAWNEER TRIFAB CG451T SERIES, 2" x 4 1/2" WITH 1" INSULATED GLASS. COLOR - IVORY.
SSR-1	PREFINISHED STANDING SEAM METAL ROOF	BERRIDGE - 'HEMLOCK GREEN'

ELEVATION CODED NOTES

①	MANUFACTURED CAST STONE VENEER BASE. (PULLED 1/2"). (CS-1)	②⑥	REFINISHED STANDING SEAM METAL ROOF. SEE MATERIAL FINISH KEY. THIS SHEET. (SBR-1)
②	CAST STONE VENEER WATERTABLE. (PULLED 1/2"). (CS-1)	②1	REFINISHED METAL (24 GA) 5" HALF ROUND GUTTER WITH FLANGE. (MTL-1)
③	+ 1 3/4" CULTURED STONE VENEER (CS-3)	②2	REFINISHED 3" DIA. EXTERIOR DOWNSPOUT (24 GA) (MTL-1). HOLD TRIM TO FACE OF CONSTRUCTION.
④	BRICK VENEER BASE. RUNNING BOND. (BRK-1)	②3	LINE OF C.I.P. CONCRETE/CMU FOUNDATION. SEE STRUCTURAL SHEETS.
⑤	FULLED BRICK ROLLOCK WATERTABLE. SLOPE AWAY FROM BUILDING. (BRK-1)	②4	DECORATIVE LIGHT FIXTURE. SEE ELECTRICAL SHEETS.
⑥	5/4" x 6" SMOOTH CEDAR CORNER TRIM. PAINT. (PT-1)	②5	5/4" x 4" SMOOTH CEDAR BARGE BOARD.
⑦	DECORATIVE WOOD CORNICE. PAINT. (PT-1)	②6	CONTINUOUS RIDGE / HIP VENT w/ ASPHALT SHINGLE CAP.
⑧	2 x 8 SMOOTH CEDAR FASCIA. PAINT. (PT-1)	②7	STONE COLUMN. SEE DETAIL B/A-22.
⑨	SMOOTH CEDAR PILASTER TRIM BOARDS. PAINT. (PT-1)	②8	STONE COLUMN w/ LIGHT POLE. SEE DETAIL D/A-22 & ELECTRICAL SITE LIGHTING SHEETS.
⑩	5/4" x 6" SMOOTH CEDAR WINDOW TRIM. PAINT. (PT-1)	②9	8" OC VERTICAL BATTEN SIDING BY JAMES HARDIE. PAINT. (PT-2)
⑪	DECORATIVE WOOD BRACKET. PAINT. (PT-1)	③0	TONGUE & GROOVE CEDAR BOARD AT 45 DEGREE ANGLE w/ 1/4" SMOOTH CEDAR TRIM BOARD SURROUND. PAINT. (PT-2)
⑫	6" EXPOSURE HARD-1 PLANK LAP SIDING BY JAMES HARDIE. PAINT. (PT-2)	③1	GAS METER SET. SEE PLUMBING SHEETS.
⑬	2" x 4 1/2" KALNEER TRIFAB VG45BT ALUMINUM STOREFRONT SYSTEM w/ 1" INSULATED GLASS AS SCHEDULED. SEE SHEET A-81 (SF-1) PROVIDE 1" FLAT BAR MUNTIN TO MATCH STOREFRONT FINISH.	③2	ELECTRIC METER SET (BEYOND). SEE ELECTRICAL SHEETS.
⑭	ALUMINUM STOREFRONT SYSTEM ENTRANCE DOOR w/ 1" INSULATED GLASS. SEE DOOR SCHEDULE SHEET A-81.	③3	REFINISHED METAL (24 GA) COPING / FASCIA EDGE FLASHING.
⑮	FABRIC AWNING OVER CONCEALED ALUMINUM TUBE FRAME. (AWN-1)	③4	DUMPSTER ENCLOSURE GATE. SEE D/A-21.
⑯	HIGH DENSITY URETHANE SIGN BOARD.	③5	6" DIA x 6'-6" LONG STEEL PIPE BOLLARD, FILLED w/ CONCRETE. (PAINT)
⑰	DECORATIVE WALL MOUNTED GOOSENECK LIGHT FIXTURE. SEE ELECTRICAL SHEETS.		
⑱	18" WIDE x 36" HIGH WOOD LOUVER. (PT-1)		
⑲	FIBERGLASS ASPHALT SHINGLES.		

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A \$ 17069.00


A-2.2
DOWELL RETAIL




MATERIAL FINISH KEY		
MARK	TYPE	NOTES
AS-1	FIBERGLASS ASPHALT SHINGLES	CERTAINTED LANDMARK SERIES COLOR - HEARTHSTONE.
AWN-1	FABRIC AWNING	TO BE SELECTED BY TENANT
BRK-1	BRICK VENEER - RUNNING BOND	BELDEN BELCREST MODULAR 530A MORTAR - RICHOLOR 54E
CS-1	CAST STONE BASE	ROCKCAST BY READING ROCK (ST203) CHISELED FACE, COLOR - WHEATSTONE. MORTAR - RICHOLOR 51W.
CS-2	CAST STONE BASE TABLE	ROCKCAST BY READING ROCK (ST204 w/ ONE CHAMFERED EDGE) SMOOTH FACE, COLOR - WHEATSTONE. MORTAR - RICHOLOR 51W.
CS-3	CULTURED STONE VENEER	STONECRAFT INDUSTRIES - HERITAGE OLD OHIO MORTAR - RICHCOLOR 51W
HP-1	HARDI-PLANK SIDING	6" EXPOSURE HARDI-PLANK LAP SIDING BY JAMES HARDIE. SMOOTH FACE.
HP-2	HARDI-PLANK VERTICAL BATTEN SIDING	8" OC. BATTEN SPACING - HARDIE/PANEL BY JAMES HARDIE. SMOOTH FACE.
MTL-1	PREFINISHED METAL GUTTERS AND DOWNSPOUTS	DM-1 'PUTTY'
PT-1	PAINT - WOOD TRIM	SW 7008 ALABASTER
PT-2	PAINT - HARDI-PLANK SIDING	SW 6038 FACER WHITE
GF-1	ALUMINUM STOREFRONT SYSTEM (AT STONE VENEER)	KAWNEER TRIFAB CG451T SERIES, 2" x 4 1/2" WITH 1" INSULATED GLASS. COLOR - CHARCOAL.
GF-2	ALUMINUM STOREFRONT SYSTEM (AT HARDI PLANK SIDING)	KAWNEER TRIFAB CG451T SERIES, 2" x 4 1/2" WITH 1" INSULATED GLASS. COLOR - IVORY.
SGR-1	PREFINISHED STANDING SEAM METAL ROOF	BERRIDGE - 'HEMLOCK GREEN'

ELEVATION CODED NOTES

①	MANUFACTURED CAST STONE VENEER BASE. (FILLED 1/2"). (CS-1)	②⑥	PREFINISHED STANDING SEAM METAL ROOF. SEE MATERIAL FINISH KEY. THIS SHEET. (SSR-1)
②	CAST STONE VENEER WATERTABLE. (FILLED 1/2"). (CS-1)	②1	PREFINISHED METAL (24 GA) 5" HALF ROUND GUTTER WITH FLANGE. (MTL-1)
③	± 1 3/4" CULTURED STONE VENEER. (CS-3)	②2	PREFINISHED 3" DIA. EXTERIOR DOWNSPOUT (24 GA) (MTL-1). HOLD TIGHT TO FACE OF CONSTRUCTION.
④	BRICK VENEER BASE. RUNNING BOND. (BRK-1)	②3	LINE OF C.I.P. CONCRETE/CMU FOUNDATION. SEE STRUCTURAL SHEETS.
⑤	PULLED BRICK ROULOCK WATERTABLE. SLOPE AWAY FROM BUILDING. (BRK-1)	②4	DECORATIVE LIGHT FIXTURE. SEE ELECTRICAL SHEETS.
⑥	5/4" x 6" SMOOTH CEDAR CORNER TRIM. PAINT. (PT-1)	②5	5/4" x 4" SMOOTH CEDAR BARGE BOARD.
⑦	DECORATIVE WOOD CORNICE. PAINT (PT-1)	②6	CONTINUOUS RIDGE / HIP VENT w/ ASPHALT SHINGLE CAP.
⑧	2 x 8 SMOOTH CEDAR FASCIA. PAINT. (PT-1)	②7	STONE COLUMN. SEE DETAIL B/A-22.
⑨	SMOOTH CEDAR PILASTER TRIM BOARDS. PAINT. (PT-1)	②8	STONE COLUMN w/ LIGHT POLE. SEE DETAIL D/A-22 & ELECTRICAL SITE LIGHTING SHEETS.
⑩	5/4" x 6" SMOOTH CEDAR WINDOW TRIM. PAINT. (PT-1)	②9	8" OC. VERTICAL BATTEN SIDING BY JAMES HARDIE. PAINT. (PT-2)
⑪	DECORATIVE WOOD BRACKET. PAINT. (PT-1)	③0	TONGUE & GROOVE CEDAR BOARD AT 45 DEGREE ANGLE w/ 1/4" SMOOTH CEDAR TRIM BOARD SURROUND. PAINT. (PT-2)
⑫	6" EXPOSURE HARDI-PLANK LAP SIDING BY JAMES HARDIE. PAINT. (PT-2)	③1	GAS METER SET. SEE PLUMBING SHEETS.
⑬	2" x 4 1/2" KALNEER TRIFAB V645IT ALUMINUM STOREFRONT SYSTEM w/ 1" INSULATED GLASS AS SCHEDULED. SEE SHEET A-81 (GF-1) PROVIDE 1" FLAT EMB MARTIN TO MATCH STOREFRONT FINISH.	③2	ELECTRIC METER SET (BEYOND). SEE ELECTRICAL SHEETS.
⑭	ALUMINUM STOREFRONT SYSTEM ENTRANCE DOOR w/ 1" INSULATED GLASS. SEE DOOR SCHEDULE SHEET A-81.	③3	REFINISHED METAL (24 GA) COPING / FASCIA EDGE FLASHING.
⑮	FABRIC AWNING OVER CONCEALED ALUMINUM TUBE FRAME. (AWN-1)	③4	DUMPSITE ENCLOSURE GATE. SEE D/A-21.
⑯	HIGH DENSITY URETHANE SIGN BOARD.	③5	6" DIA. x 6'-6" LONG STEEL PIPE BOLLARD, FILLED w/ CONCRETE. (PAINT)
⑰	DECORATIVE WALL MOUNTED GOOSENECK LIGHT FIXTURE. SEE ELECTRICAL SHEETS.		
⑱	18" WIDE x 36" HIGH WOOD LOUVER. (PT-1)		
⑲	FIBERGLASS ASPHALT SHINGLES.		

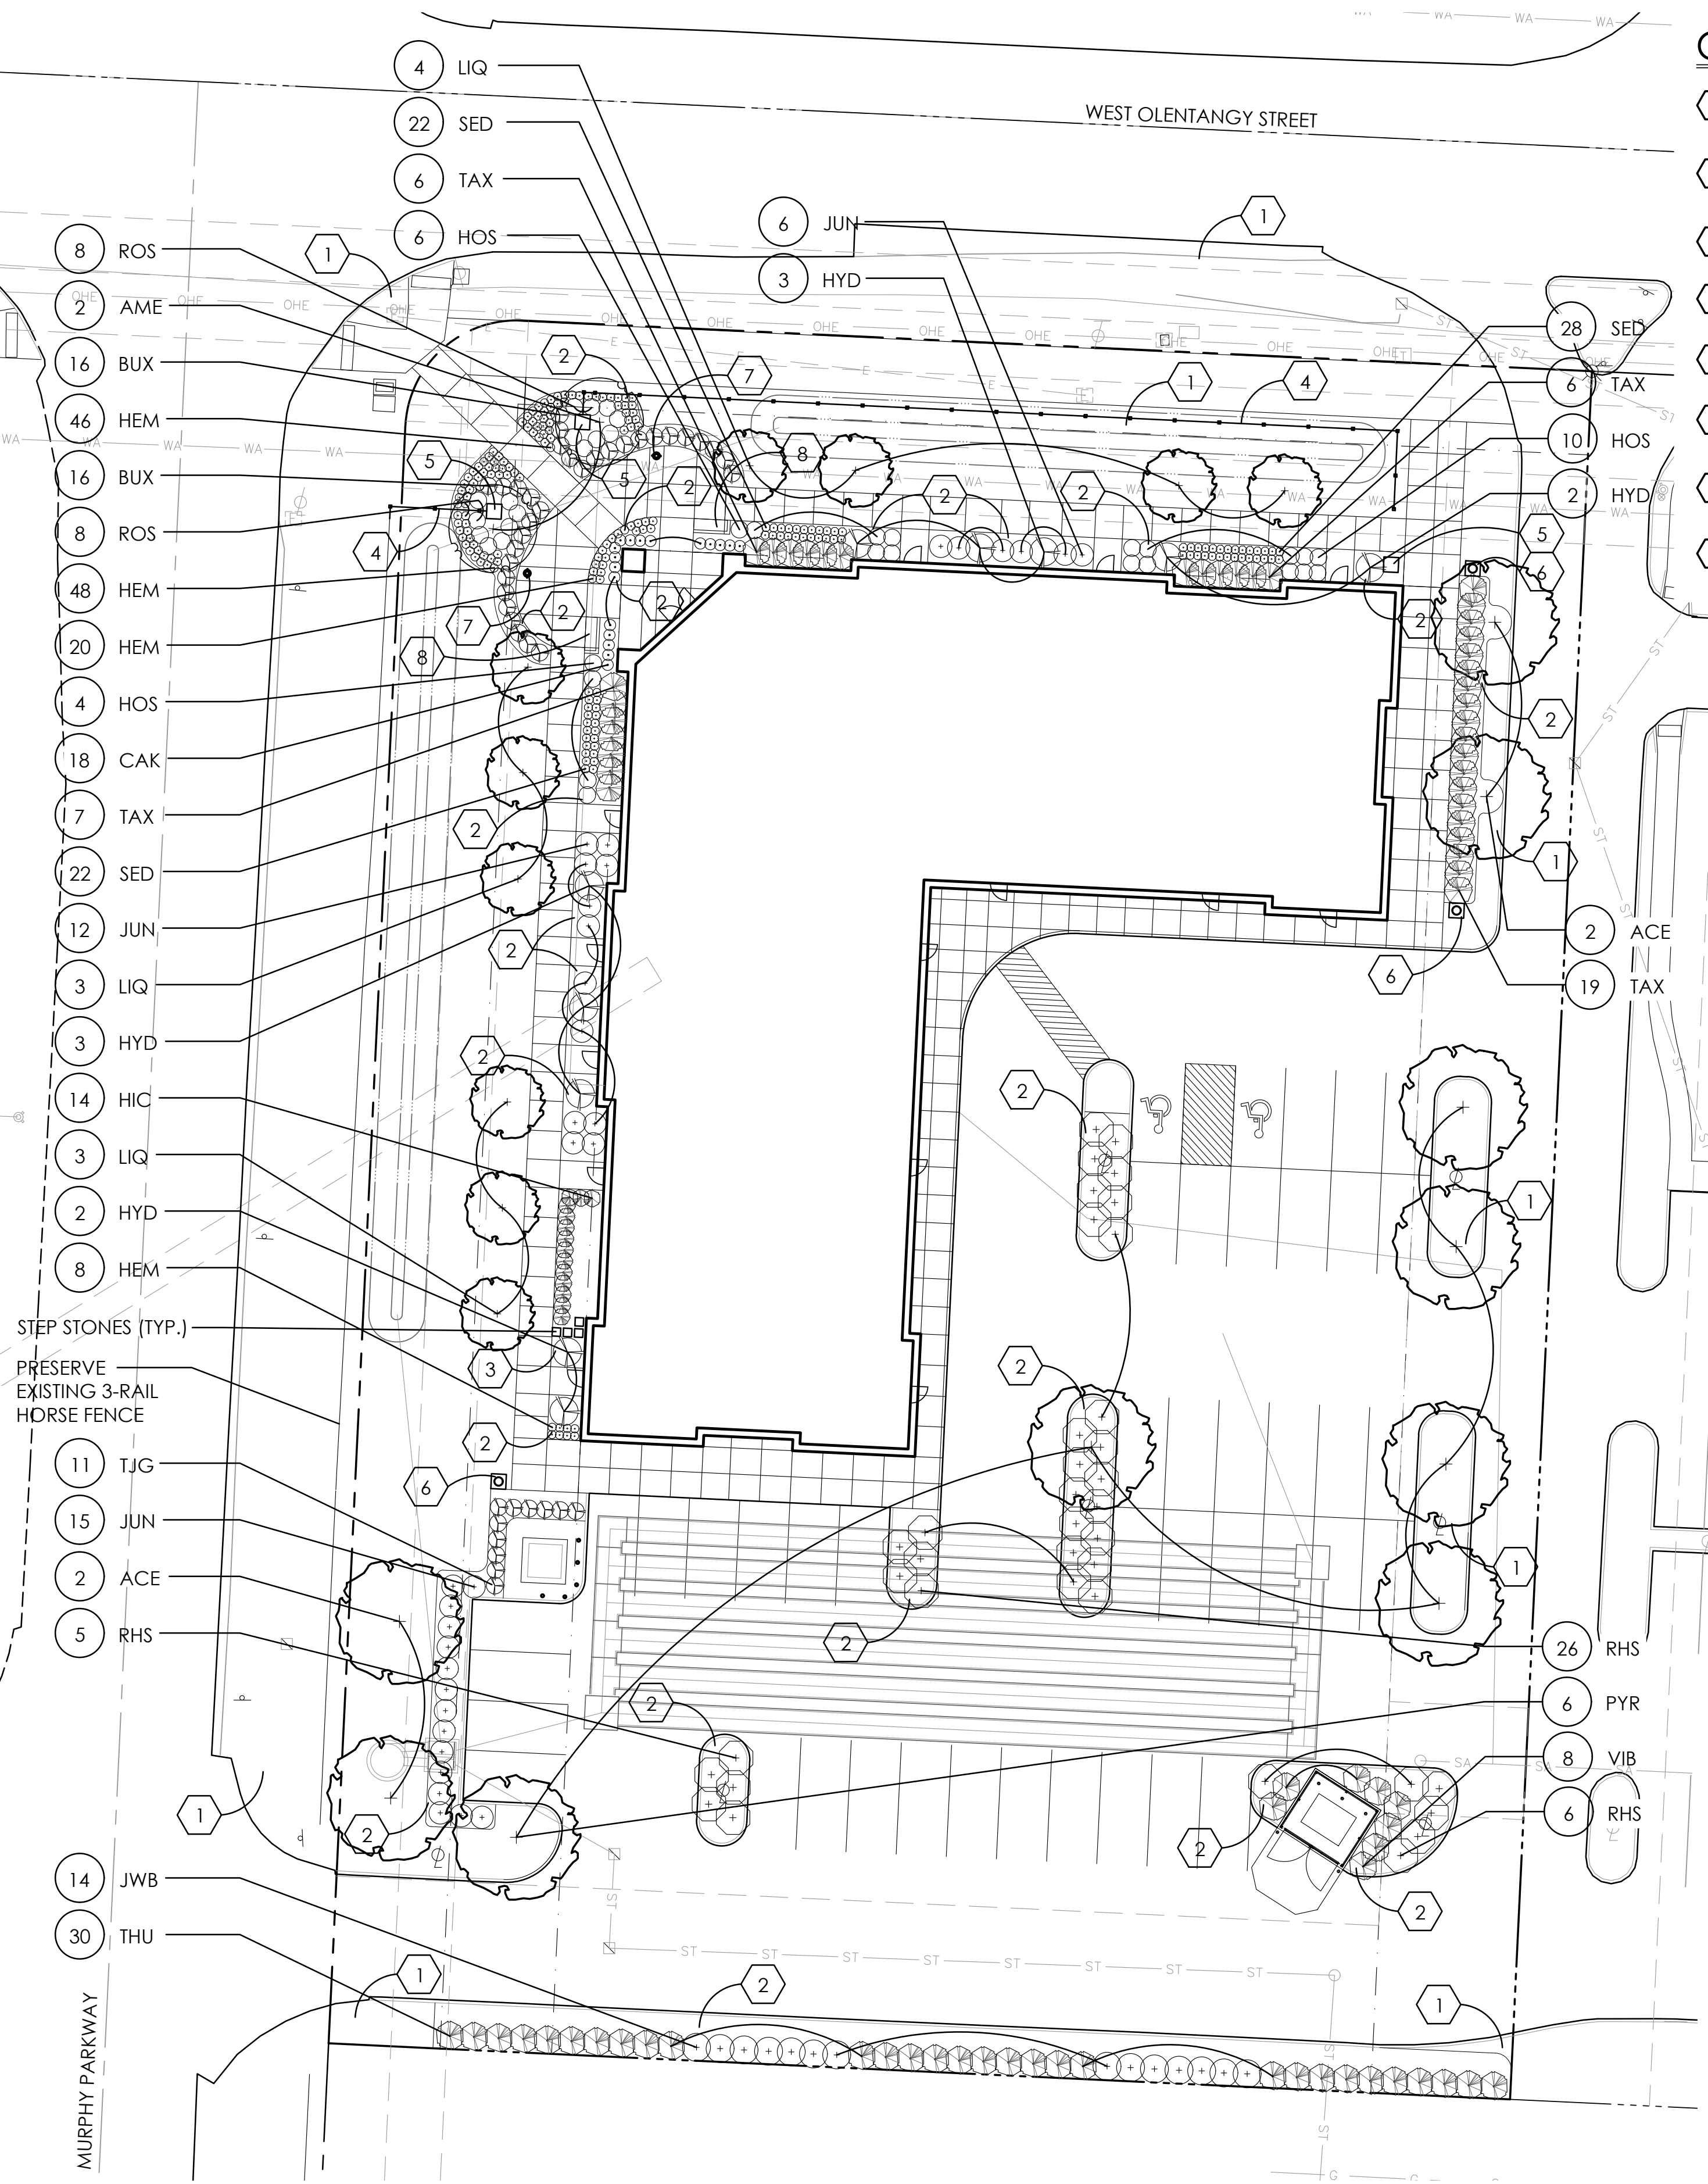


1 OVERALL LANDSCAPE PLAN
SCALE: 1"=20'

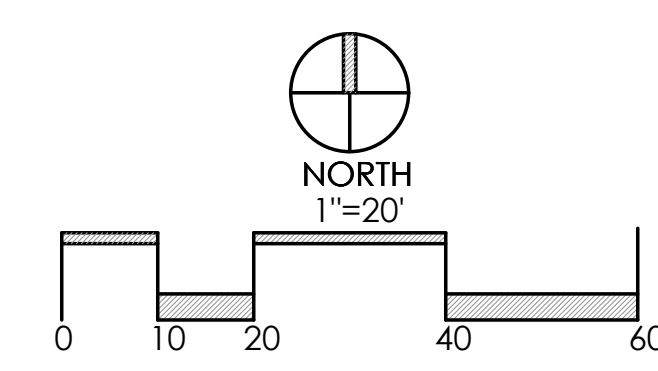

CONSTRUCTION NOTES:

- 1 LAWN AREA, PROVIDE POSITIVE DRAINAGE ACROSS ALL SURFACES.
- 2 LANDSCAPE AREA, PROVIDE 3" DEPTH HARDWOOD MULCH TO MATCH BUILDING ELEVATION, PROVIDE POSITIVE DRAINAGE ACROSS ALL SURFACES.
- 3 STONE MULCH, 2" - 3" LOCAL WASH GRAVEL, 6" DEPTH.
- 4 3 RAIL HORSE FENCE, MATCH EXISTING.
- 5 STONE COLUMN, SEE ARCHITECTURAL PLANS FOR SPECS.
- 6 STONE COLUMN WITH LIGHT, SEE ARCHITECTURAL PLANS FOR SPECS.
- 7 BIKE BOLLARD, AVAILABLE FROM FAIR WEATHER SITE FURNISHINGS, PRODUCT: BR-2. PHONE: 800-323-1798. SEE DETAIL 1 ON SHEEL L-2 FOR MORE INFORMATION.
- 8 6' BENCH, AVAILABLE FROM DUMOR, INC., PRODUCT: BENCH 500. PHONE: 800-598-4018. SEE DETAIL 2 ON SHEET L-2 FOR MORE INFORMATION.

PLANT KEY TYPICALS
SEE PLANT LIST FOR SPECIFIC PLANT SPECIES

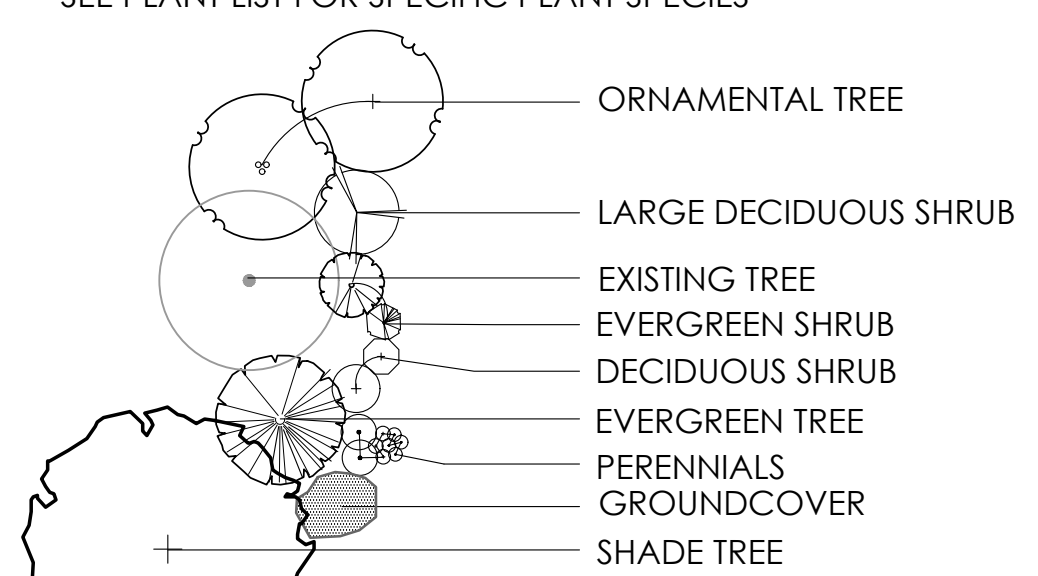

GENERAL PLANTING NOTES:

- 1. ALL PLANTS SHALL MEET OR EXCEED STANDARDS SET IN THE USA STANDARD FOR NURSERY STOCK.
- 2. ALL PLANTING OPERATIONS SHALL ADHERE TO THE AMERICAN ASSOCIATION OF NURSERYMEN STANDARDS.
- 3. PLANT LOCATIONS AND BEDS SHALL BE LOCATED BY CONTRACTOR AND APPROVED BY LANDSCAPE ARCHITECT PRIOR TO INSTALLATION.
- 4. PLANTING BEDS SHALL HAVE A MINIMUM 3" DEEP SHREDDED HARDWOOD BARK MULCH. MULCH HEDGES IN A CONTINUOUS BED.
- 5. ALL PLANTING BEDS TO BE TILLED TO A MINIMUM DEPTH OF 12".
- 6. ALL PLANTING BEDS TO BE FERTILIZED WITH 10-10-10 OR APPROVED EQUAL.
- 7. SODDING / SEEDING BY LANDSCAPE CONTRACTOR.
- 8. THE LOCATION OF THE EXISTING UNDERGROUND UTILITIES ARE SHOWN IN AN APPROXIMATE WAY ONLY AND HAVE NOT BEEN INDEPENDENTLY VERIFIED BY THE OWNER OR ITS REPRESENTATIVE. THE CONTRACTOR SHALL DETERMINE THE EXACT LOCATION OF ALL EXISTING UTILITIES PRIOR TO COMMENCING WORK AND AGREES TO BE FULLY RESPONSIBLE FOR ANY AND ALL DAMAGES WHICH MIGHT BE OCCASIONED BY THE CONTRACTOR'S FAILURE TO EXACTLY LOCATE AND PRESERVE ANY AND ALL UNDERGROUND UTILITIES.
- 9. ALL AREAS DISTURBED BY CONSTRUCTION ARE TO BE RESTORED, FINE GRADED AND SEEDED/ SODDED.
- 10. ALL EXISTING PLANT MATERIAL SHOWN ON THIS PLAN IS TO BE PRESERVED UNLESS SPECIFICALLY NOTED OTHERWISE.

LANDSCAPE REQUIREMENTS

REQUIREMENT	REQUIRED	PROVIDED
MINIMUM REQUIRED TREES - SEE CHART IN CODE SECTION 1145.30(a)(2)(B) FOR CHART.	41,158 SF = 43 CALIPER INCHES (15 TREES @ 3" CALIPER)	48 CALIPER INCHES (17 TREES @ 3" CALIPER)
LANDSCAPING OF PARKING AREAS - 1 DECIDUOUS TREE PER 10 SPACES + 1 DECIDUOUS TREE PER 8 SPACES THEREOF	43 SPACES = 6 TREES IN PARKING AREA	6 TREES IN PARKING AREA
LANDSCAPING AROUND BUILDING FOUNDATION - 5 SHRUBS PER 10 LF OF BUILDING PERIMETER + 10 PERENNIALS PER 40 LF OF BUILDING PERIMETER	624 LF OF BUILDING PERIMETER = 78 SHRUBS AND 156 PERENNIALS	128 SHRUBS AND 232 PERENNIALS
SCREENING OF NEIGHBORING PROPERTIES - 4' HEIGHT DENSE VEGETATIVE PLANTING	SCREENING ALONG SOUTHERN PERIMETER	SCREENING PROVIDED WITH 44 4' HEIGHT SHRUBS

PLANT LIST


(CONTRACTOR RESPONSIBLE FOR ALL PLANTS SHOWN ON PLAN)

QTY	KEY	BOTANICAL NAME	COMMON NAME	SIZE	COND.	REMARKS
TREES						
5	ACE	ACER X FREEMANII 'SIENNA'	SIENNA GLEN MAPLE	3" CAL.	B&B	
2	AME	AMELANCHIER CANADENSIS 'GLENN FORM'	RAINBOW PILLAR SERVICEBERRY	3" CAL.	B&B	
10	LIQ	LIQUIDAMBAR STYRACIFLUA 'SLENDER SILHOUETTE'	SLENDER SILHOUETTE SWEETGUM	3" CAL.	B&B	
7	PYR	PYRUS CALLERYANA 'CLEVELAND SELECT'	CLEVELAND SELECT PEAR	1.5" CAL.	B&B	
SHRUBS						
32	BUX	BUXUS 'GREEN VELVET'	GREEN VELVET BOXWOOD	24" HGT.	B&B	
14	HIC	TAXUS X MEDIA 'HICKSII'	HICKS YEW	3.5" HGT.	B&B	
10	HYD	HYDRANGEA PANICULATA 'LIMELIGHT'	LIMELIGHT HYDRANGEA	36" HGT.	B&B	
33	JUN	JUNIPERUS VIRGINIANA 'GREY OWL'	GREY OWL JUNIPER	18" HGT.	B&B	
14	JWB	JUNIPERUS SCOPULORUM 'WICHITA BLUE'	WICHITA BLUE JUNIPER	4' HGT.	B&B	
37	RHS	RHUS AROMATICA 'GRO-LOW'	GRO-LOW FRAGRANT SUMAC	18" SPRD.	CONT.	
16	ROS	ROSA X 'RADTKO'	DOUBLE KNOCK OUT ROSE	18" HGT.	B&B	
38	TAX	TAXUS X MEDIA 'DENSIFORMIS'	DENSE YEW	24" HGT.	B&B	
30	THU	THUJA OCCIDENTALIS 'SMARAGD'	EMERALD GREEN ARBORVITAE	4' HGT.	B&B	
11	TJG	THUJA OCCIDENTALIS 'JANED GOLD'	JANED GOLD ARBORVITAE	36" HGT.	B&B	
8	VIB	VIBURNUM DENTATUM	ARROWWOOD VIBURNUM	24" HGT.	B&B	
PERENNIALS/ORNAMENTAL GRASSES						
18	CAK	CALAMAGROSTIS X ACUTIFLORA 'KARL FOERSTER'	KARL FOERSTER FEATHER REED GRASS	NO. 2	CONT.	
122	HEM	HEMEROCALLIS 'GOING BANANAS'	GOING BANANAS DAYLILY	NO. 1	CONT.	
20	HOS	HOSTA SIEBOLDIANA 'ELEGANS'	ELEGANS HOSTA	NO. 1	CONT.	
72	SED	SEDUM SPECTABILE 'AUTUMN JOY'	AUTUMN JOY SEDUM	NO. 1	CONT.	

NOTE:
THE AMOUNT OF TREE AND SHRUB PRUNING SHALL BE LIMITED TO THE MINIMUM NECESSARY TO REMOVE DEAD OR INJURED TWIGS & BRANCHES. RETAIN NORMAL SHAPE. PLANT TREES AND EVERGREENS SO THE ROOT FLARE IS 2"- 3" ABOVE FINISH GRADE

FLEXIBLE TREE WEBBING
MATERIAL 3" WIDE-
GREEN COLOR


2" X 2" X 8' WOOD
STAKE, 2 PER TREE

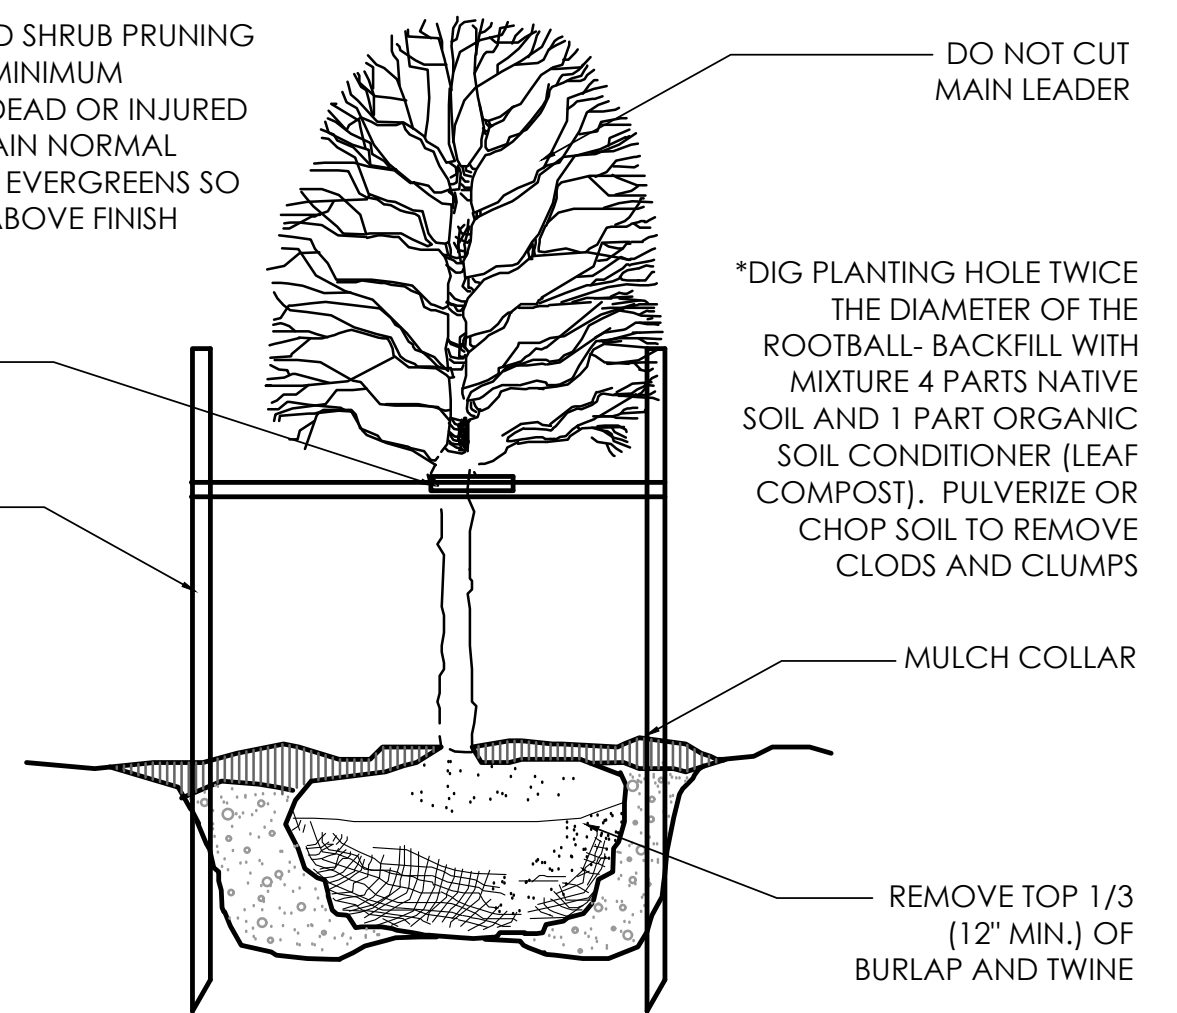

2 DECIDUOUS TREE
N.T.S.

NOTE:
THE AMOUNT OF TREE AND SHRUB PRUNING SHALL BE LIMITED TO THE MINIMUM NECESSARY TO REMOVE DEAD OR INJURED TWIGS & BRANCHES. RETAIN NORMAL SHAPE. REMOVE EXCESS SOIL FROM THE TOP OF ROOT MASS. PLANT SHRUBS WITH TOP OF ROOT MASS AT FINISH GRADE.

DIG PLANTING HOLE TWICE THE DIAMETER OF THE ROOTBALL- BACKFILL WITH MIXTURE 4 PARTS NATIVE SOIL AND 1 PART ORGANIC SOIL CONDITIONER (LEAF COMPOST). PULVERIZE OR CHOP SOIL TO REMOVE CLODS AND CLUMPS

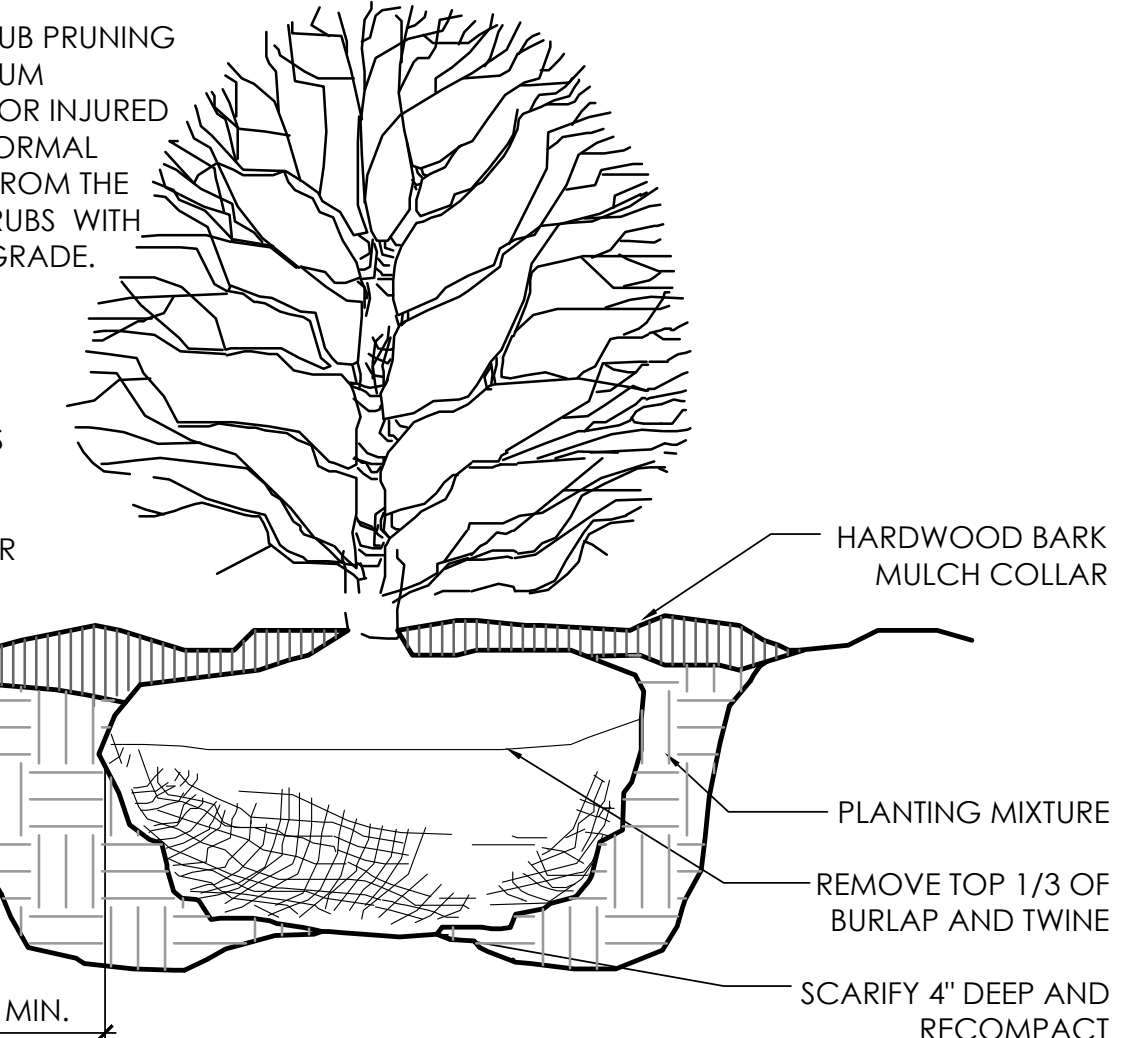

3 SHRUB PLANTING DETAIL
N.T.S.

REVISIONS

OVERALL LANDSCAPE PLAN

POWELL RETAIL
PREPARED FOR
FORD ARCHITECTURE
1500 W 1ST AVE, COLUMBUS, OH 43212

Faris Planning & Design
LAND PLANNING 9 LANDSCAPE ARCHITECTURE
2425 N. 5th Street Columbus, OH 43215
p (614) 487-1954
Suite 401 www.farisplanninganddesign.com

DATE 7/26/17

PROJECT 17065

SHEET

L-1

ORDERING INFORMATION:

ARUE

WATTAGE / DRIVER
 50 - 50W 350mA
 75 - 75W 350MA
 100 - 100W 350MA

COLOR TEMPERATURE
 4K = 4,000K CCT
 5K = 5,000K CCT
 6K = 6,000K CCT

OPTICS
 A3 = ASYMMETRIC
 AC3 = ACYCLIC REFRACTOR
 G3 = ASYMMETRIC GLASS
 REFRACTOR
 P3 = ASYMMETRIC POLY
 REFRACTOR

COLOR
 A = AS SPECIFIED
 B = BLACK
 D = DARK GREEN
 RAUM05
 E = BROWN GREEN
 RAUM06
 F = DARK GREEN
 RAUM09
 H = DARK GREEN
 RAUM12
 N = GREEN
 W = WHITE
 Z = BRONZE

**FINAL FACTORY
 (INSTALLED)**
 S = SAIL
 S = SPIKE

OPTIONS

D = DIMMING DRIVER REPLACES EXISTING DRIVER
 H = HEMA TEST/LOCK PHOTOCONTROL RECEPTACLE
 L15 = 1.5 FEET OF PREWIRED LEADS
 L20 = 2.0 FEET OF PREWIRED LEADS
 L25 = 2.5 FEET OF PREWIRED LEADS
 L30 = 3.0 FEET OF PREWIRED LEADS
 L35 = 3.5 FEET OF PREWIRED LEADS
 L50 = 5.0 FEET OF PREWIRED LEADS
 PCB = 0.01 SOLID STATE PHOTOCONTROL, 120-277VOLT
 P48 = 0.01 TWISTED LOCK PHOTOCONTROL, 347 VOLT
 P48 = 0.01 TWISTED LOCK PHOTOCONTROL, 480 VOLT
 PSC = SHORTING CAP

APPROXIMATES

SPECULUM REPLACEMENT SURGE PROTECTOR 120-277
 SFCUL030N-48 = REPLACEMENT SURGE PROTECTOR 347-480

 BEACON designs perfect waste technology www.beaconproducts.com		WAT28/AS/24NB-55/4K/UNV/DIRS/P7/color																	
		Title _____ Project Name _____ Notes _____																	
Sample	WAT28	/	AG	/	24NB-55	/	5K	/	UNV	/	DIRS	/	PEC	/	GEM-XC	/	PT	/	B&T
Ordering	A		B		C		D		E		F		G		H		J		I

DETAILS

Top View

A. MODEL	G. ELECTRICAL OPTIONS
WAT28 Waterford 28"	PEC photocell, button
B. LENS OPTIONS	H. CONTROL OPTIONS
AF acrylic, frosted	GEM-XX energen ¹
AS acrylic, seeded	SWP wireless gate commission ¹
PC polycarbonate, clear	
PF polycarbonate, frosted	
C. ENGINE-WATTS	I. MOUNTING OPTIONS
24NB-55 55 Watts - LED array	PT post top
	PM pendant mount *
D. OCT - COLOR TEMP	J. COLOR
3K 3000K	BBT basic black textured
4K 4000K	BMT black matte textured
5K 5000K (std.)	WBH white textured
	MHT metallic bronze textured
	BCI bronze textured
	DBT dark bronze textured
	GVS gray smooth
	DPS dark platinum smooth
	GNT green textured
	MST metallic silver textured
	MTT metallic titanium textured
	OAI old world iron
	RWL raw iron
E. VOLTAGE	
UNV 120-277V	
S47 347V	
480V 480V	
F. OPTICS	
DIR2 direct, type II	
DIR3 direct, type III	
DIR4 direct, type IV	
DIR5 direct, type V	

MOUNTING OPTIONS

Single gang 1 box in the wall (by electrical contractor)
 (Ø 3/8" - 16 S.S. lag bolts provided & installed by installation contractor)

Wall Mount Post Top

* When ordering Energex, specify the routine settings code (see page GEM-08). See Energex brochure and instructions for setting table and options. *Not available with sensor options.


¹ Consult factory

² Must specify group and zone information at time of order. See www.hubbellighting.com/control/ pleasecall for further details

* Not available with other control or sensor options.

2041 58th Avenue Circle East Bradenton, FL 34203 Phone: (800) 345-4928
Fax: (941) 751-6535

ORDER FORM


NORTH
 **POINT BY POINT SITE PLAN**
SCALE: 1" = 30'-0"

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POWELL RETAIL
SE CORNER of WEST OLENTANGY STREET AND MURPHY PARKWAY
POWELL, OHIO 43065

For
DR. ALI KHAKSAR
6800 HEATHROW DRIVE POWELL, OHIO 43065


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POINT BY POINT SITE PLAN

FAA # 17089.00

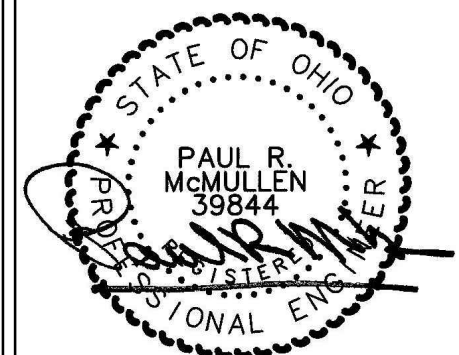PxP-1.0

POWELL RETAIL

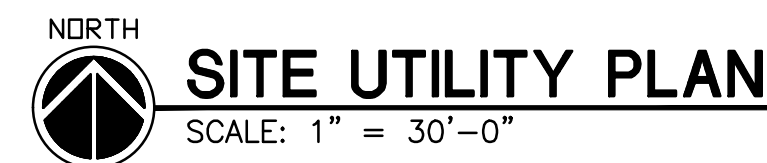


McMullen Engineering Co., Inc.
MECHANICAL AND ELECTRICAL ENGINEERS

100 South State Street, Westerville, Ohio 43081
614-895-9408 FAX: 614-895-9450
E-Mail: mec@mcmulleneng.com
Web: <http://www.mcmulleneng.com>

POWELL RETAIL
SE CORNER of WEST OLENTANGY STREET AND MURPHY PARKWAY
POWELL, OHIO 43065

For


DR. ALI KHAKSAR
5600 HEATHROW DRIVE POWELL, OHIO 43065

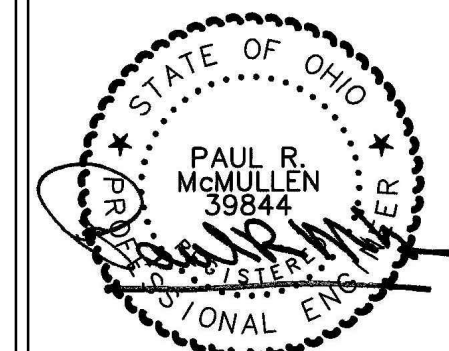

SITE UTILITY PLAN


FAA # 17089.0

SU-1.0
POWELL RETAIL

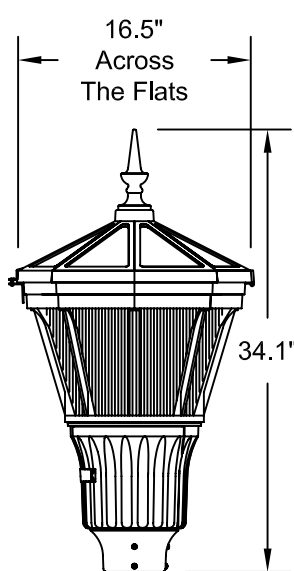

Maximum weight - 47 lbs
Maximum effective projected area - 1.38 sq. ft.

P3

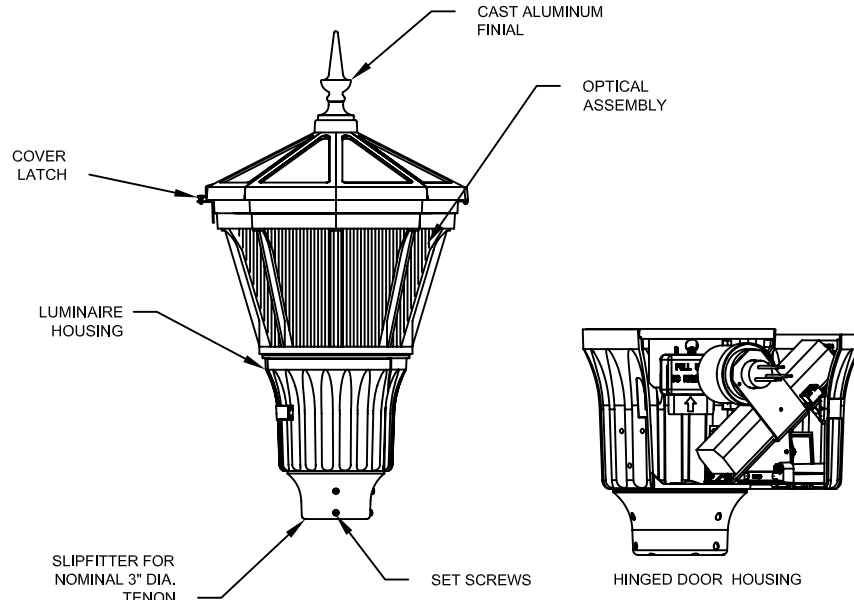

Utility Arlington LED[®]
Series Luminaire

DECORATIVE
OUTDOOR

ARUE 100 4K AS A3 color S L20

ORDERING INFORMATION:

ARUE

WATTAGE / DRIVER
50 = 50W 350mA
70 = 70W 350mA
100 = 100W 350mA

COLOR TEMPERATURE
4K = 4,000K CCT
5K = 5,000K CCT
6K = 6,000K CCT

VOLTAGE
AS = AUTO-SENSING
(120-277) 50/60 HZ
AH = AUTO-SENSING
(347-480) 50/60 HZ

OPTICS
A3 = ASYMMETRIC
ACRYLIC REFRACTOR
G3 = ASYMMETRIC GLASS
REFRACTOR
P3 = ASYMMETRIC POLY
REFRACTOR

COLOR
A = AS SPECIFIED
B = BLACK
D = DARK GREEN
RAL6005
E = BROWN GREEN
RAL6008
F = DARK GREEN
RAL6009
H = DARK GREEN
RAL6012
N = GREEN
W = WHITE
Z = BRONZE

**FINIAL (FACTORY
INSTALLED)**
B = BALL
S = SPIKE

OPTIONS

D = DIMMING DRIVER REPLACES EXISTING DRIVER
H = NEMA TWISTLOCK PHOTOCONTROL RECEPTACLE
L1H = 1.5 FEET OF PREWIRED LEADS
L03 = 3 FEET OF PREWIRED LEADS
L10 = 10 FEET OF PREWIRED LEADS
L20 = 20 FEET OF PREWIRED LEADS
L25 = 25 FEET OF PREWIRED LEADS
L30 = 30 FEET OF PREWIRED LEADS
PCS = DTL SOLID STATE PHOTOCONTROL 120-277 VOLT
P34 = DTL TWISTLOCK PHOTOCONTROL 347 VOLT
P48 = DTL TWISTLOCK PHOTOCONTROL 480 VOLT
PSC = SHORTING CAP

ACCESSORIES

SPDPLUGIN = REPLACEMENT SURGE PROTECTOR 120-277
SPDPLUGIN-48 = REPLACEMENT SURGE PROTECTOR 347-480

HOLOPHANE[®]
LEADER IN LIGHTING SOLUTIONS
An Acuity Brands Company

THIS DRAWING, WHEN APPROVED, SHALL BECOME THE COMPLETE SPECIFICATION FOR THE MATERIAL TO BE FURNISHED BY HOLOPHANE ON THE ORDER NOTED ABOVE. A UNIT OF SIMILAR DESIGN MAY BE SUBSTITUTED FOR THE UNIT ORDERED IF THE SUBSTITUTION DOES NOT VARY IN POLE ORDER, ANCHOR BOLT, TELLER, LATE PRINT WILL BE SUPPLIED WITH EACH ANCHOR BOLT ORDER TO MATCH THE POLE PROVIDED. THIS PRINT IS THE PROPERTY OF HOLOPHANE AND IS LOANED SUBJECT TO RETURN UPON DEMAND AND UPON EXPRESS WRITTEN NOTICE TO OUR INTERESTS AND ONLY IN CONNECTION WITH MATERIAL FURNISHED BY HOLOPHANE.

ORDER #:

TYPE:


DRAWN: KRW

DATE: 05/16/11

DWG #: LUM_ARUE

1 of 2

P3

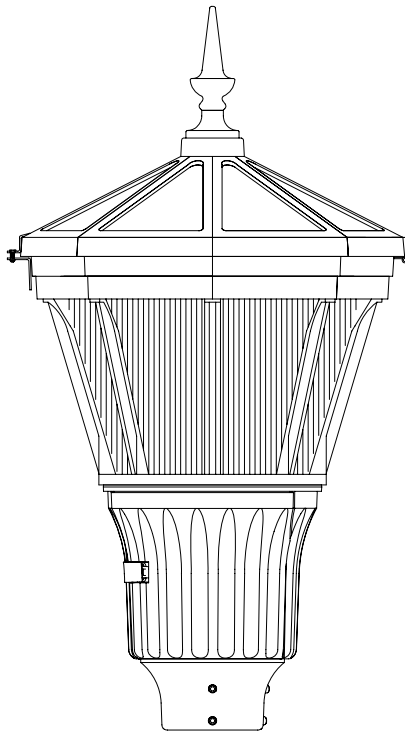

FINIALS

BALL



SPIKE



Specifications

GENERAL DESCRIPTION

The Utility Arlington LED is designed for ease of maintenance with the plug-in electrical module common to each of the luminaires in Holophane's Utility Luminaire Series. A precision optical system maximizes post spacings while maintaining uniform illumination.

OPTICAL SYSTEM

The optical system consists of a precisely molded refractor operating in conjunction with a formed polished reflector and LED circuit board with dedicated heat sink located in the top cover. Positive pressure from the reflector and gaskets at the top and bottom of the refractor create a sealed optical compartment. Refractors designed to provide an I.E.S. Type III distribution are available molded from thermal resistant borosilicate glass and acrylic or polycarbonate plastic.

LUMINAIRE HOUSING

The luminaire housing, cast of aluminum, cradles the refractor and provides an enclosure for the plug-in electrical module. A slipfitter will accept a 3" high by 2 7/8" to 3 1/8" O.D. pole tenon.

LUMINAIRE HOUSING / DOOR

Cast of aluminum, the housing / door opens without the use of tools and is retained on a hinge. For units with an E.E.I.-N.E.M.A. twist lock photocell receptacle, the door contains an acrylic "window" to allow light to reach the cell.

ELECTRICAL MODULE

The electrical components are mounted on a steel plate that is removable with minimum use of tools. A matching five conductor plug connects to the receptacle in the luminaire housing to complete the wiring. Where a starting aid is required, it is provided with a separate plug-in connector and can be replaced without the use of tools. For photoelectric operation, the electrical module is provided with an E.E.I.-N.E.M.A. twist lock photocell receptacle.

TOP COVER

The octagonal cover, cast of aluminum, is attached to the top ring of the luminaire housing by a stainless steel pins hinge and latch a color matched bracket & screw which secures entry to the LED optical chamber.

ELECTRONIC DRIVER

(Refer to the handbook for specific operating characteristics)

FINISH

The luminaire is finished with polyester powder paint to insure maximum durability.

CSA

The luminaire is CSA listed as suitable for wet locations at a maximum of 40 degrees C ambient temperature.


Utility Arlington LED[®]
Series Luminaire

DECORATIVE
OUTDOOR

HOLOPHANE[®]
LEADER IN LIGHTING SOLUTIONS
An **Acuity Brands Company**

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ORDER #:	
TYPE:	
DRAWN:	KRW
DATE:	05/16/11
DWG #:	LUM_ARUE

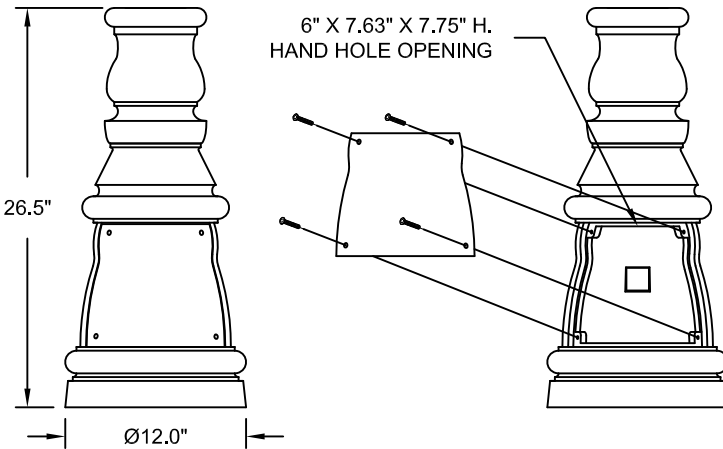

Shaft Style



4" Dia. Smooth
S4C & S4J



3"-4" Dia. Tapered
T4C



4" Dia. Fluted
F4C & F4J

P3

TM

MOUNT VERNON


Aluminum Pole

Architectural
Outdoor




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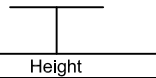
ORDERING INFORMATION:

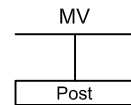

MV = Mount Vernon

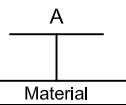


A = Aluminum




08 = 8'
09 = 9'
10 = 10'
11 = 11'
12 = 12'
13 = 13'
14 = 14'



F4C = 4" DIA. Fluted, .125 Wall
F4J = 4" DIA. Fluted, .25 Wall
S4C = 4" DIA. Smooth, .125 Wall
S4J = 4" DIA. Smooth, .25 Wall
T4C = 3" to 4" DIA. Tapered, .125 Wall

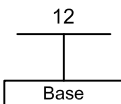


12 = 12" Round
(TMP-61)

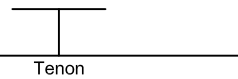


P05 = 3" O.D. X 4" LG.
P07 = 3" O.D. X 3" LG.
P08 = 3" O.D. X 5" LG.
P09 = 3" O.D. X 6" LG.
P10 = 3" O.D. X 9" LG.
(3" O.D. = ACTUAL SIZE IS 2.88" O.D.)

P12 = 3" O.D. X 12" LG.
P13 = 3" O.D. X 8" LG.
P14 = 3" O.D. X 14" LG.

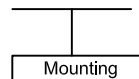

ABG = Anchor Bolts
Galvanized Steel
LAB = Less Anchor
Bolts
DBB = Direct Burial Base
Galvanized Steel
(12" Base = ADBB1R2)

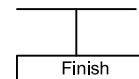

BK = Black
BD = Dark Blue
BZ = Bronze
GH = Graphite
GN = Green
GR = Gray
PP = Prime Painted
SL = Silver
WH = White

Options

SPECIFICATIONS

DESCRIPTION

The lighting post shall be all aluminum, one-piece construction, with a classic tapered base design.

MATERIALS

The base shall be heavy wall, cast aluminum produced from certified ASTM 356.1 ingot per ASTM B-179-95a or ASTM B26-95. The straight shafts shall be extruded from aluminum, ASTM 6061 alloy, heat treated to a T6 temper. The tapered shaft shall be extruded from aluminum, ASTM 6063 alloy, spun to a tapered shape, then heat treated to a T6 temper. All hardware shall be tamper resistant stainless steel. Anchor bolts to be completely hot dip galvanized.

CONSTRUCTION

The shaft shall be double welded to the base casting and shipped as one piece for maximum structural integrity. The shaft shall be welded inside the base casting at the top of the access door, and externally where the shaft exits the base. All welding shall be per ANSI/AWS

DIMENSIONS

The post shall be X'- XX" in height with a 12" diameter base. The shaft diameter shall be XX". At the top of the post, an integral tenon with a transitional donut shall be provided for luminaire mounting.

INSTALLATION

The post shall be provided with four, hot dip galvanized L-type anchor bolts. A door shall be provided in the base for anchorage and wiring access. A grounding screw shall be provided inside the base opposite the door.

² - Replace "XXX" with height from grade (inches), can be up to 3 digits. Must use whole numbers. Leading zeros are not used. Replace Y with orientation from hand hole (A=0, B=90, C=180, D=270). Add multiple provisions as necessary to cover each location. Must validate EPA restrictions for banners.

EXXXY² = Provision for eye bolt.
LXXXY² = Large provision.
RXXXY² = Receptacle provision.
SXXXY² = Small provision.

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ORDER #:


TYPE:

DRAWN: ACH

DATE: 2/12/13

DWG #: POL_MVA

P3

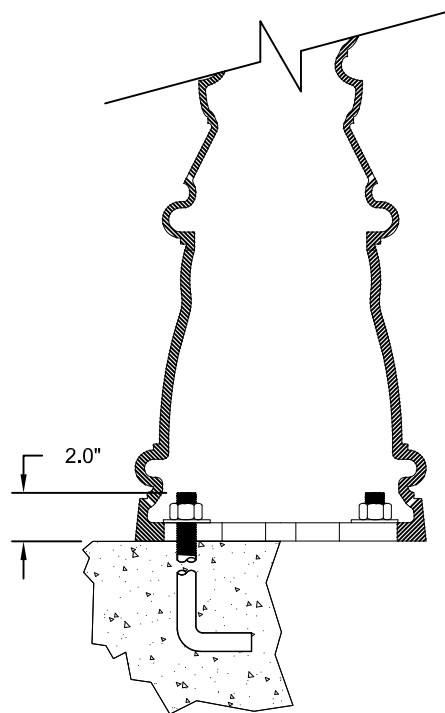

MVA 12"
Ø 3/4"
Hot Dip Galvanized
L-type Anchor Bolts
(4 per Post)

MOUNT VERNONTM
Aluminum Pole

Architectural Outdoor



An **Acuity** Brands Company

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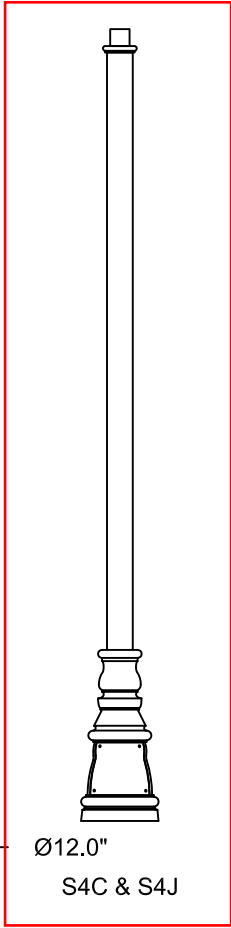
ORDER #:

TYPE:

DRAWN: ACH

DATE: 2/12/13

DWG #: POL_MVA



 **HOLOPHANE®**
LEADER IN LIGHTING SOLUTIONS
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THIS DRAWING, WHEN APPROVED, SHALL BECOME THE COMPLETE SPECIFICATION FOR THE MATERIAL TO BE FURNISHED BY HOLOPHANE ON THE ORDER NOTED ABOVE. A LIST OF SIMILAR DESIGN MAY BE SUPPLIED, BUT ONLY AFTER APPROVAL BY THE CUSTOMER IN WRITING. ON POLE ORDERS AN ANCHOR BOLT TEMPLATE PRINT WILL BE SUPPLIED WITH EACH ANCHOR BOLT ORDER TO MATCH THE POLE PROVIDED. THIS PRINT IS THE PROPERTY OF HOLOPHANE AND IS LOANED SUBJECT TO RETURN UPON DEMAND AND UPON EXPRESS CONDITION THAT IT WILL NOT BE USED DIRECTLY OR INDIRECTLY IN ANY WAY DETRIMENTAL TO OUR INTERESTS, AND ONLY IN CONNECTION WITH MATERIAL FURNISHED BY HOLOPHANE.

3 of 3	ORDER #: 03/22/11
	TYPE:
	DRAWN: ACH
	DATE: 2/12/13
	DWG #: POL MVA


Architectural Outdoor

MOUNT VERNONTM
Aluminum Pole


Type:
Project Name:
Notes:

Sample	WIN30	AC	24NB-55	3K	UNV	DIR3	PEC	GENIXX	PT	SPK	BBT
Ordering	<input type="checkbox"/>	<input type="checkbox"/>	<input type="checkbox"/>	<input type="checkbox"/>	<input type="checkbox"/>	<input type="checkbox"/>	<input type="checkbox"/>	<input type="checkbox"/>	<input type="checkbox"/>	<input type="checkbox"/>	<input type="checkbox"/>
	A	B	C	D	E	F	G	H	I	J	K


DETAILS

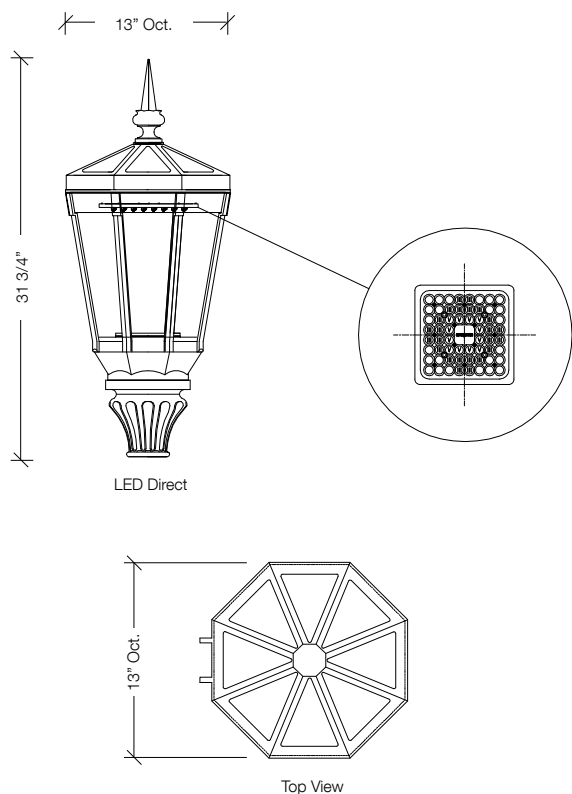

MOUNTING OPTIONS

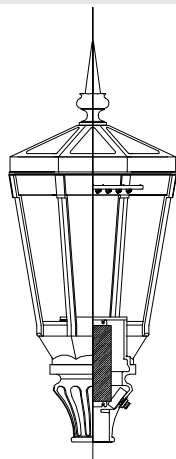

STYLE OPTIONS

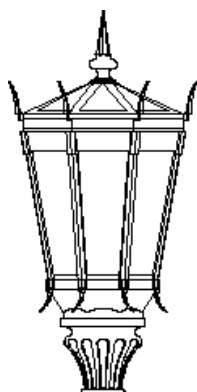

A. MODEL

WIN30 Windsor 30"

B. LENS OPTIONS

AC acrylic, clear
AF acrylic, frosted
AS acrylic, seeded
AW acrylic, white
PC polycarbonate, clear
PF polycarbonate, frosted
NL no lens

C. ENGINE-WATTS

24NB-55 55 Watts - LED array
36NB-80 80 Watts - LED array

D. CCT - COLOR TEMP

3K 3000K
4K 4000K
5K 5000K

E. VOLTAGE

UNV 120-277V
347 347V
480 480V

F. OPTICS

DIR2 type II
DIR3 type III
DIR4 type IV
DIR5 type V

G. ELECTRICAL OPTIONS

PEC photocell, button

H. CONTROL OPTIONS

GENI-XX energeni¹
SWP sitesync wireless pre-commission^{3,4}

I. MOUNTING OPTIONS

PT post top
PM pendant mount²

J. STYLE OPTIONS

SPK spikes

K. COLOR

BBT basic black textured
BMT black matte textured
WHT white textured
MBT metallic bronze textured
BZT bronze textured
DBT dark bronze textured
GYS gray smooth
DPS dark platinum smooth
GNT green textured
MST metallic silver textured
MTT metallic titanium textured
OWI old world iron
RAL _____

¹ When ordering Energeni, specify the routine setting code (example GENI-04). See Energeni brochure and instructions for setting table and options. Not available with sensor options.

² consult factory

³ Must specify group and zone information at time of order. See www.hubbellighting.com/controls/sitesync for further details

⁴ Not available with other control or sensor options.

**SPECIFICATIONS****Intended Use:**

- The Beacon Windsor luminaire is available with a choice of different LED Wattage configurations and optical distributions designed to replace HID lighting up to 250W MH or HPS.

Construction:

- The electrical chamber/fitter shall be cast aluminum.
- Decorative fitter shall be designed to accommodate the driver assembly and shall be mounted to 3" OD x 3" H tenon and be secured by three or more stainless steel set screws.

Electrical:

- 100V through 277V, 50 Hz to 60 Hz (UNV)
- Power factor is ≥ 0.90 at full load
- All electrical components are rated at 50,000 hours at full load and 25°C ambient conditions per MIL- 217F Notice 2.
- One piece optical cartridge system consisting of an LED engine, LED lamps, optics, gasket and stainless steel bezel.
- Cartridge is held together with internal brass standoffs soldered to the board so that it can be field replaced as a one piece optical system.
- Silicone gasket ensures a weather-proof seal around each individual LED.
- Fixture electrical compartment shall contain all LED driver components.
- Rated ambient operating temperature -40°C to 40°C.
- Surge protection - 20KA
- Lifeshield™ Circuit - protects luminaire from excessive temperature. The device shall activate at a specific, factory-preset temperature, and progressively reduce power over a finite temperature range. Operation shall be smooth and undetectable to the eye. Thermal circuit is designed to "fail on", allowing the luminaire to revert to full power in the event of an interruption of its power supply, or faulty wiring connection to the drivers. The device shall be able to co-exist with other 0-10V control devices (occupancy sensors, external dimmers, etc.).

Controls/Options:

- Available with Energeni for optional set dimming, timed dimming with simple delay, or timed dimming based on time of night (see www.beaconproducts.com/products/energeni).
- Windsor can be specified with SiteSync™ wireless control system for reduction in energy and maintenance cost while optimizing light quality 24/7. See ordering information or visit www.hubbellighting.com/sitesync

Finish:

- IFS polyester powder-coat electrostatically applied and thermocured.
- IFS finish consists of a five stage pretreatment regimen with a polymer primer sealer and top coated with a thermoset super TGIC polyester powder coat finish.
- The finish meets the AAMA 605.2 performance specification which includes passing a 3000 hour salt spray test for corrosion resistance and resists cracking or loss of adhesion per ASTM D522 and resists surface impacts of up to 160 inch-pounds.

Listings:

- Listed to UL8750 , UL1598 and CSA22.2#250.13-14 for wet locations

Warranty:

- Five year limited warranty (for more information visit: www.hubbellighting.com/re-sources/warranty)

Accessories and Services (Ordered Separately)

Catalog Number	Description
SWUSB*	SiteSync loaded on USB flash drive (Windows based only)
SWTAB*	SiteSync Windows Tablet
SWBRG*	SiteSync Wireless Bridge Node

*When ordering with SiteSync, one of the following interface options must be chosen and ordered separately. Each option contains the SiteSync License, GUI and Bridge Node.

+ If needed, an additional Bridge Node can be ordered.

PRECOMMISSIONED SITESYNC ORDERING INFORMATION: When ordering a fixture with the SiteSync lighting control option, additional information will be required to complete the order. The SiteSync Commissioning Form or alternate schedule information must be completed. This form includes Project location, Group information, and Operating schedules. For more detailed information please visit www.hubbellighting.com/sitesync/ or contact Hubbell Lighting tech support at (800) 345-4928.

SiteSync fixtures with occupancy sensor (SWPM) require the mounting height of the fixture for selection of the lens.

RSA-B-DBE-S SERIES POLES ROUND STRAIGHT ALUMINUM

Cat.#

Job


Type

PT5



BEACON
design . performance . technology

Approvals

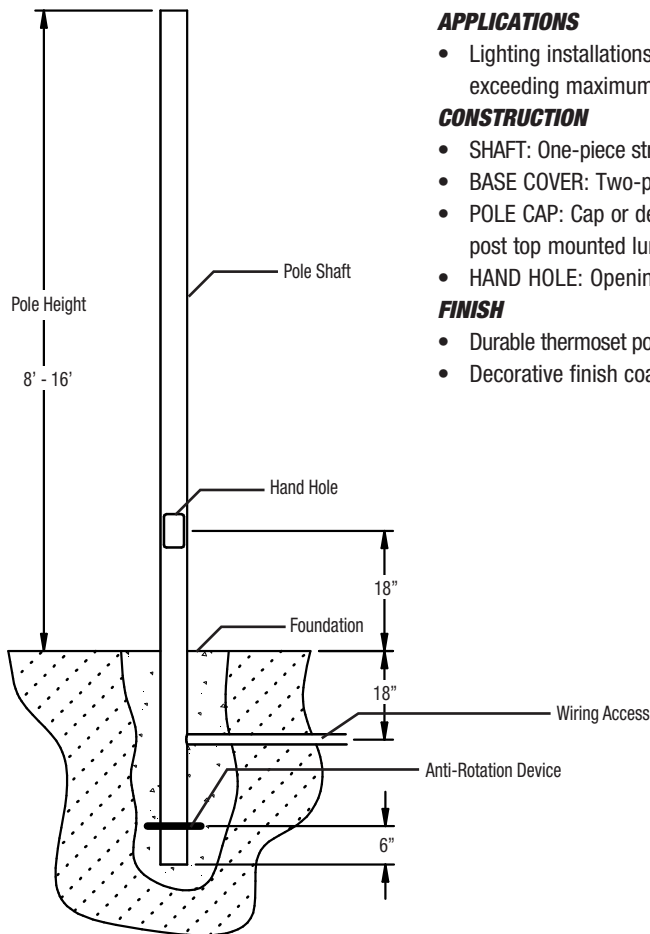

APPLICATIONS

- Lighting installations for side and top mounting of luminaires with effective projected area (EPA) not exceeding maximum allowable loading of the specified pole in its installed geographic location


CONSTRUCTION

- SHAFT:** One-piece straight aluminum with round cross section, 6061-T6
- BASE COVER:** Two-piece cast aluminum base covers available
- POLE CAP:** Cap or decorative finials available for side mounted luminaires. Open top or tenons provided for post top mounted luminaires.
- HAND HOLE:** Opening provided with cast aluminum frame reinforcement.

FINISH

- Durable thermoset polyester powder coat paint finish with nominal 3.0 mil thickness
- Decorative finish coat available in twelve standard colors; Custom colors available; RAL number preferable

TENONS & POLE CAPS

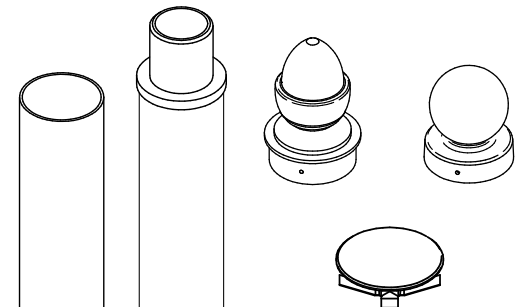


*Local civil engineer should be consulted for proper foundation design

ORDERING EXAMPLE:

RSA-B-DBE-S - **16** - **40** - **A/B/C** - **CAP** - **2L** - **B3** - **BBT** - **VM2**

SERIES	HEIGHT	SHAFT	THICKNESS	MOUNTING	DRILL PATTERN	FINISH	OPTIONS
RSA-B-DBE-S Round Straight Aluminum Direct Burial Style Beacon Smooth	Reference page 2 Ordering matrix	Reference page 2 Ordering matrix	Reference page 2 Ordering matrix	1 Single arm mount 2 Two fixtures at 180° 2L² Two fixtures at 90° 3T² Three fixtures at 90° 3Y² Three fixtures at 120° 4² Four fixtures at 90° OT³ Open top (no drilling) BAL³ Ball Finial ARC³ Acorn Finial CAP³ Cap Top TN3³ Tenon 3 x 3 TN4³ Tenon 3 x 4 TN5³ Tenon 4 x 5 TN8³ Tenon 4 x 8	B1 CRUZER B3 VP-L B4 VP-S	BBT Basic Black Textured BMT Black Matte Textured BZT Bronze Textured DBT Dark Bronze Textured DPS Dark Platinum Smooth GNT Green Textured GYS Gray Smooth MBT Metallic Bronze Textured MST Metallic Silver Textured MTT Metallic Titanium Textured OWI Old World Iron WHT White Textured CC Custom Color- RAL Color#	GFI^{1,2} 20 Amp GFCI Receptacle and Cover EHH^{1,2} Extra Handhole C05¹ .5" Coupling C07¹ .75" Coupling C20¹ 2" Coupling VM2 2nd mode vibration damper

MOUNTING ORIENTATION

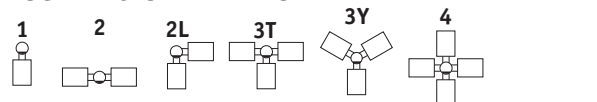

ACCESSORIES- Order Separately

Catalog Number	Description
VM2SXX	2nd mode vibration damper

- Specify option location using logic found on page 2 (**Option Orientation**)
- Not available with 3" diameter poles.
- Specify Pole Top



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Due to our continued efforts to improve our products, product specifications are subject to change without notice.

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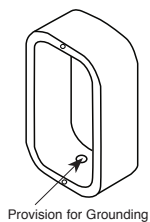
HUBBELL
Lighting

ORDERING INFORMATION Cont.


PT5

Catalog Number	Pole Height		Nominal Shaft Dimensions	Wall Thickness	Pole weight (lbs)
	Feet	Meters			
RSA-B-DBE-S-08-30-A	08	2.4	3" Round	0.125"	15
RSA-B-DBE-S-10-30-A	10	3.0	3" Round	0.125"	18
RSA-B-DBE-S-12-30-A	12	3.7	3" Round	0.125"	22
RSA-B-DBE-S-14-30-A	14	4.3	3" Round	0.125"	25
RSA-B-DBE-S-08-30-C	08	2.4	3" Round	.25"	28
RSA-B-DBE-S-10-30-C	10	3.0	3" Round	.25"	34
RSA-B-DBE-S-12-30-C	12	3.7	3" Round	.25"	41
RSA-B-DBE-S-14-30-C	14	4.3	3" Round	.25"	48
RSA-B-DBE-S-08-40-A	08	2.4	4" Round	0.125"	20
RSA-B-DBE-S-10-40-A	10	3.0	4" Round	0.125"	24
RSA-B-DBE-S-12-40-A	12	3.7	4" Round	0.125"	29
RSA-B-DBE-S-14-40-A	14	4.3	4" Round	0.125"	34
RSA-B-DBE-S-16-40-A	16	4.9	4" Round	0.125"	39
RSA-B-DBE-S-08-40-B	08	2.4	4" Round	0.188"	29
RSA-B-DBE-S-10-40-B	10	3.0	4" Round	0.188"	36
RSA-B-DBE-S-12-40-B	12	3.7	4" Round	0.188"	43
RSA-B-DBE-S-14-40-B	14	4.3	4" Round	0.188"	50
RSA-B-DBE-S-16-40-B	16	4.9	4" Round	0.188"	57
RSA-B-DBE-S-08-40-C	08	2.4	4" Round	0.25"	37
RSA-B-DBE-S-10-40-C	10	3.0	4" Round	0.25"	47
RSA-B-DBE-S-12-40-C	12	3.7	4" Round	0.25"	56
RSA-B-DBE-S-14-40-C	14	4.3	4" Round	0.25"	65
RSA-B-DBE-S-16-40-C	16	4.9	4" Round	0.25"	74
RSA-B-DBE-S-08-50-B	08	2.4	5" Round	0.188"	36
RSA-B-DBE-S-10-50-B	10	3.0	5" Round	0.188"	45
RSA-B-DBE-S-12-50-B	12	3.7	5" Round	0.188"	54
RSA-B-DBE-S-14-50-B	14	4.3	5" Round	0.188"	63
RSA-B-DBE-S-16-50-B	16	4.9	5" Round	0.188"	71
RSA-B-DBE-S-10-60-A	10	3.0	6" Round	0.125"	37
RSA-B-DBE-S-12-60-A	12	3.7	6" Round	0.125"	44
RSA-B-DBE-S-14-60-A	14	4.3	6" Round	0.125"	51
RSA-B-DBE-S-16-60-A	16	4.9	6" Round	0.125"	58

EHH - EXTRA HANDHOLE



C05 - C07 - C20 - COUPLING

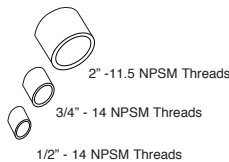


VM2SXX - VIBRATION DAMPER 2ND MODE

Field installed, internal damper designed to alter pole resonance to reduce movement and material fatigue caused by 2nd mode vibration.




VM2S08 - 8'
VM2S12 - 12'
VM2S16 - 16'
VM2S20 - 20'
VM2S24 - 24'

VM2 - VIBRATION DAMPER 2ND MODE

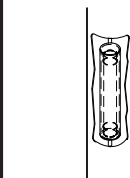

Factory installed, internal damper designed to alter pole resonance to reduce movement and material fatigue caused by 2nd mode vibration.

GFI - 20 AMP GFCI RECEPTACLE & COVER

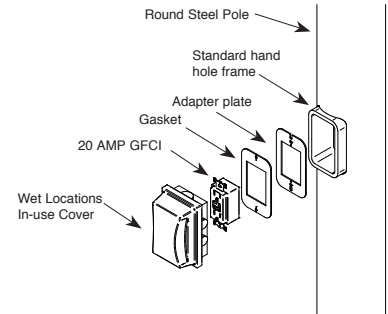

OPTION ORIENTATION

Follow the logic below when ordering location specific options. For each option, include its orientation (in degrees) and its height (in feet). Example: Option C07 should be ordered as: **RSA-B-DBE-S-16-40A-TN3-BBT-C05-0-10**. (.5" coupling on the handhole/arm side of pole, 15 feet up from the pole base) 1' spacing required between option. Consult factory for other configurations.

For more information about pole vibration and vibration dampers, please consult http://cdn.beaconproducts.com/content/products/literature/literature_files/Pole_Wind_Induced_Flyer_HL010022.pdf
Due to our continued efforts to improve our products, product specifications are subject to change without notice.




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Due to our continued efforts to improve our products, product specifications are subject to change without notice.

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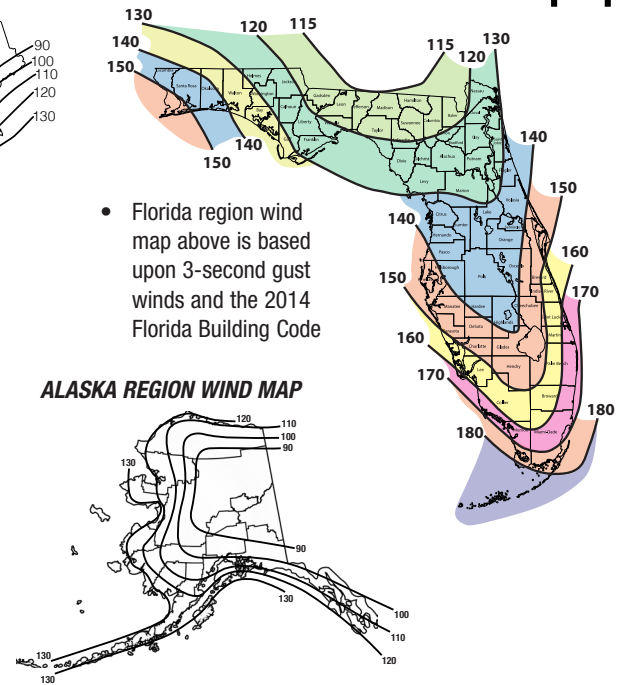
HUBBELL
Lighting



HAWAII – 105 mph
PUERTO RICO – 145 mph


*PRINTED WITH PERMISSION FROM ASCE

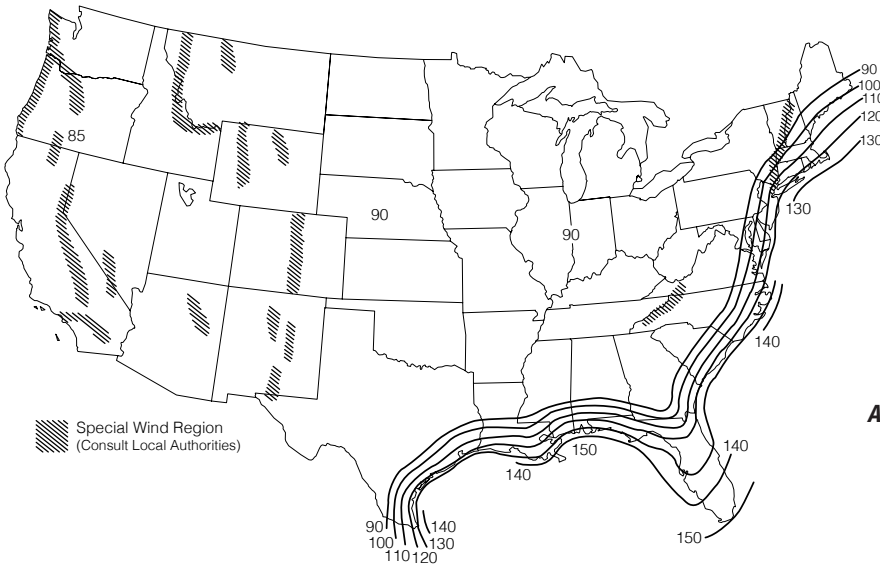ASCE 7-05 wind map EPA Load Rating - 3 second gust wind speeds										
Catalog Number	85	90	100	105	110	120	130	140	150	160
RSA-B-DBE-S-08-30-A	11.2	10.1	8.2	7.4	6.7	5.5	4.6	3.9	3.5	3.2
RSA-B-DBE-S-10-30-A	8.3	7.4	5.9	5.3	4.8	3.9	3.1	2.5	2.3	2.1
RSA-B-DBE-S-12-30-A	6.3	5.6	4.4	3.9	3.4	2.7	2.1	1.6	1.4	1.2
RSA-B-DBE-S-14-30-A	4.8	4.2	3.2	2.8	2.4	1.8	1.3	0.9	0.7	0.5
RSA-B-DBE-S-08-30-C	20.6	18.5	15.1	13.7	12.5	10.5	8.9	7.6	7.0	6.5
RSA-B-DBE-S-10-30-C	15.6	14.0	11.4	10.3	9.4	7.8	6.5	5.5	5.1	4.6
RSA-B-DBE-S-12-30-C	12.2	10.9	8.8	8.0	7.2	5.9	4.9	4.0	3.7	3.3
RSA-B-DBE-S-14-30-C	9.7	8.7	6.9	6.2	5.6	4.5	3.6	2.9	2.6	2.3
RSA-B-DBE-S-08-40-A	21.8	19.5	15.8	14.3	13.0	10.9	9.3	8.0	7.4	6.9
RSA-B-DBE-S-10-40-A	16.5	14.8	11.9	10.7	9.7	8.0	6.8	5.9	5.4	5.1
RSA-B-DBE-S-12-40-A	12.9	11.5	9.2	8.2	7.4	6.0	5.1	4.3	4.0	3.7
RSA-B-DBE-S-14-40-A	10.3	9.1	7.1	6.3	5.6	4.5	3.7	3.2	2.9	2.7
RSA-B-DBE-S-16-40-A	8.2	7.2	5.5	4.8	4.3	3.3	2.7	2.2	2.0	1.8
RSA-B-DBE-S-08-40-B	25.0	25.0	23.2	21.1	19.2	16.1	13.8	11.9	11.1	10.4
RSA-B-DBE-S-10-40-B	24.3	21.8	17.7	16.0	14.5	12.1	10.4	8.9	8.3	7.8
RSA-B-DBE-S-12-40-B	19.2	17.2	13.9	12.5	11.3	9.4	8.0	6.9	6.4	5.9
RSA-B-DBE-S-14-40-B	15.5	13.8	11.1	10.0	9.0	7.3	6.2	5.3	4.9	4.6
RSA-B-DBE-S-16-40-B	12.7	11.3	8.9	8.0	7.1	5.7	4.8	4.1	3.8	3.5
RSA-B-DBE-S-08-40-C	25.0	25.0	25.0	25.0	24.7	20.8	17.8	15.4	14.4	13.4
RSA-B-DBE-S-10-40-C	25.0	25.0	22.9	20.8	18.9	15.9	13.6	11.7	10.9	10.2
RSA-B-DBE-S-12-40-C	24.9	22.3	18.2	16.4	14.9	12.5	10.6	9.2	8.5	8.0
RSA-B-DBE-S-14-40-C	20.3	18.2	14.7	13.3	12.0	9.9	8.4	7.3	6.7	6.3
RSA-B-DBE-S-16-40-C	16.8	15.0	12.0	10.8	9.7	8.0	6.7	5.8	5.3	5.0
RSA-B-DBE-S-08-50-B	25.0	25.0	25.0	25.0	25.0	23.2	20.1	18.7	17.5	17.5
RSA-B-DBE-S-10-50-B	25.0	25.0	25.0	25.0	24.8	21.0	17.9	15.5	14.5	13.5
RSA-B-DBE-S-12-50-B	25.0	25.0	23.8	21.7	19.9	16.8	14.3	12.4	11.5	10.8
RSA-B-DBE-S-14-50-B	25.0	23.8	19.4	17.7	16.2	13.7	11.6	10.0	9.3	8.7
RSA-B-DBE-S-16-50-B	22.2	19.8	16.1	14.6	13.4	11.2	9.6	8.2	7.6	7.1
RSA-B-DBE-S-10060-A	25.0	25.0	25.0	25.0	25.0	21.4	18.2	15.8	14.7	13.7
RSA-B-DBE-S-12060-A	25.0	25.0	24.4	22.2	20.3	17.1	14.6	12.6	11.8	11.0
RSA-B-DBE-S-14060-A	25.0	24.4	20.0	18.2	16.6	14.0	12.0	10.3	9.6	8.9
RSA-B-DBE-S-16060-A	22.7	20.4	16.6	15.1	13.8	11.6	9.9	8.5	7.9	7.3



- Florida region wind map above is based upon 3-second gust winds and the 2014 Florida Building Code

ALASKA REGION WIND MAP

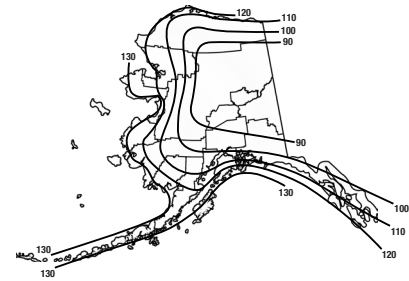

Florida Building Code 2014 EPA Load Rating - 3 second gust wind speeds								
Catalog Number	115	120	130	140	150	160	170	180
RSA-B-DBE-S-08-30-A	11.0	10.1	8.6	7.4	6.3	5.5	4.8	4.2
RSA-B-DBE-S-10-30-A	8.1	7.4	6.3	5.3	4.5	3.8	3.3	2.8
RSA-B-DBE-S-12-30-A	6.1	5.5	4.6	3.8	3.2	2.6	2.2	1.8
RSA-B-DBE-S-14-30-A	4.6	4.2	3.4	2.7	2.2	1.7	1.3	1.0
RSA-B-DBE-S-08-30-C	20.2	18.7	16.0	13.9	12.1	10.6	9.3	8.2
RSA-B-DBE-S-10-30-C	15.3	14.1	12.1	10.4	9.0	7.8	6.8	6.0
RSA-B-DBE-S-12-30-C	11.9	11.0	9.3	8.0	6.9	5.9	5.1	4.4
RSA-B-DBE-S-14-30-C	9.4	8.7	7.3	6.2	5.3	4.5	3.8	3.2
RSA-B-DBE-S-08-40-A	21.2	19.6	16.7	14.4	12.4	10.8	10.1	9.0
RSA-B-DBE-S-10-40-A	16.0	14.7	12.5	10.7	9.2	7.9	7.6	6.7
RSA-B-DBE-S-12-40-A	12.5	11.4	9.6	8.1	6.9	5.8	5.6	5.1
RSA-B-DBE-S-14-40-A	9.8	8.9	7.4	6.2	5.1	4.2	4.0	3.9
RSA-B-DBE-S-16-40-A	7.7	7.0	5.7	4.6	3.7	2.9	2.5	2.0
RSA-B-DBE-S-08-40-B	25.0	25.0	24.6	21.3	18.5	16.2	14.9	13.3
RSA-B-DBE-S-10-40-B	23.8	21.9	18.7	16.1	14.0	12.1	11.4	10.1
RSA-B-DBE-S-12-40-B	18.8	17.3	14.7	12.6	10.8	9.3	9.0	7.9
RSA-B-DBE-S-14-40-B	15.1	13.9	11.7	9.9	8.5	7.2	6.7	6.3
RSA-B-DBE-S-16-40-B	12.2	11.1	9.3	7.8	6.5	5.5	5.2	5.0
RSA-B-DBE-S-08-40-C	25.0	25.0	25.0	25.0	23.9	21.0	19.2	17.1
RSA-B-DBE-S-10-40-C	25.0	25.0	24.3	21.0	18.2	15.9	14.8	13.2
RSA-B-DBE-S-12-40-C	24.4	22.5	19.2	16.5	14.3	12.4	11.8	10.4
RSA-B-DBE-S-14-40-C	19.8	18.3	15.6	13.3	11.4	9.8	9.6	8.4
RSA-B-DBE-S-16-40-C	16.2	14.9	12.6	10.7	9.1	7.7	7.1	6.8
RSA-B-DBE-S-08-50-B	25.0	25.0	25.0	25.0	25.0	25.0	24.4	21.8
RSA-B-DBE-S-10-50-B	25.0	25.0	25.0	25.0	24.3	21.4	18.9	16.8
RSA-B-DBE-S-12-50-B	25.0	25.0	24.9	22.5	19.6	17.2	15.1	13.4
RSA-B-DBE-S-14-50-B	25.0	23.8	20.2	18.6	16.1	14.1	12.4	10.9
RSA-B-DBE-S-16-50-B	21.3	19.5	16.4	15.4	13.3	11.6	10.1	8.8
RSA-B-DBE-S-10060-A	25.0	25.0	25.0	25.0	24.4	21.4	18.9	16.7
RSA-B-DBE-S-12060-A	25.0	25.0	25.0	22.6	19.6	17.1	15.0	13.3
RSA-B-DBE-S-14060-A	25.0	25.0	21.6	18.6	16.1	14.0	12.2	10.7
RSA-B-DBE-S-16060-A	22.9	21.1	17.9	15.3	13.2	11.4	9.9	8.6

Wind-speed Website disclaimer:

Hubbell Lighting has no connection to the linked website and makes no representations as to its accuracy. While the information presented on this third-party website provides a useful starting point for analyzing wind conditions, Hubbell Lighting has not verified any of the information on this third party website and assumes no responsibility or liability for its accuracy. The material presented in the windspeed website should not be used or relied upon for any specific application without competent examination and verification of its accuracy, suitability and applicability by engineers or other licensed professionals. Hubbell Lighting Inc. does not intend that the use of this information replace the sound judgment of such competent professionals, having experience and knowledge in the field of practice, nor to substitute for the standard of care required of such professionals in interpreting and applying the results of the windspeed report provided by this website. Users of the information from this third party website assume all liability arising from such use. Use of the output of these referenced websites do not imply approval by the governing building code bodies responsible for building code approval and interpretation for the building site described by latitude/longitude location in the windspeed report. <http://windspeed.atcouncil.org>

- Allowable EPA, to determine max pole loading weight, multiply allowable EPA by 30 lbs.
- The tables for allowable pole EPA are based on the ASCE 7-05 Wind Map or the Florida Region Wind Map for the 2010 Florida Building Code. The Wind Maps are intended only as a general guide and cannot be used in conjunction with other maps. Always consult local authorities to determine maximum wind velocities, gusting and unique wind conditions for each specific application
- Allowable pole EPA for jobsite wind conditions must be equal to or greater than the total EPA for fixtures, arms, and accessories to be assembled to the pole. Responsibility lies with the specifier for correct pole selection. Installation of poles without luminaires or attachment of any unauthorized accessories to poles is discouraged and shall void the manufacturer's warranty
- Wind speeds and listed EPAs are for ground mounted installations. Poles mounted on structures (such as bridges and buildings) must consider vibration and coefficient of height factors beyond this general guide; Consult local and federal standards
- Wind Induced Vibration brought on by steady, unidirectional winds and other unpredictable aerodynamic forces are not included in wind velocity ratings. Consult Hubbell Lighting's Pole Vibration Application Guide for environmental risk factors and design considerations. http://cdn.beaconproducts.com/content/products/literature/literature_files/Pole_Wind_Induced_Flyer_HLOI0022.pdf
- Extreme Wind Events like, Hurricanes, Typhoons, Cyclones, or Tornadoes may expose poles to flying debris, wind shear or other detrimental effects not included in wind velocity ratings

Due to our continued efforts to improve our products, product specifications are subject to change without notice.

Type:

Project Name:


Notes:

Sample WAT28 AC 24NB-55 5K UNV DIR5 PEC GENIXX PT BBT


Ordering / / / / / / / / / /

A B C D E F G H J I

DETAILS

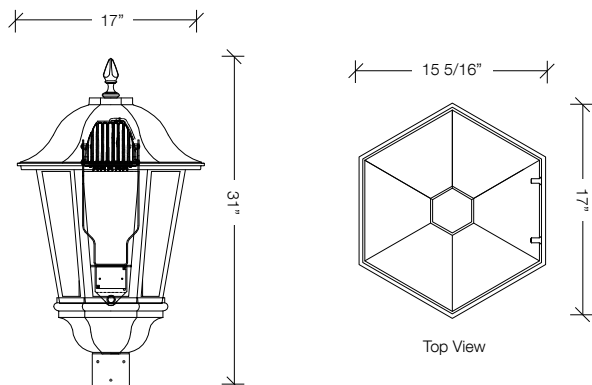

MOUNTING OPTIONS

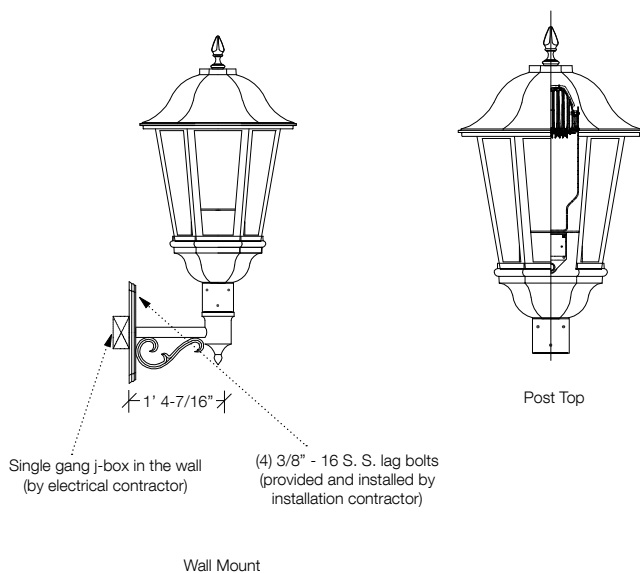

A. MODEL

WAT28 Waterford 28"

B. LENS OPTIONS

AF acrylic, frosted

AS acrylic, seeded

PC polycarbonate, clear

PF polycarbonate, frosted

C. ENGINE-WATTS

24NB-55 55 Watts - LED array

D. CCT - COLOR TEMP

3K 3000K

4K 4000K

5K 5000K (std.)

E. VOLTAGE

UNV 120-277V

347 347V

480 480V

F. OPTICS

DIR2 direct, type II

DIR3 direct, type III

DIR4 direct, type IV

DIR5 direct, type V

G. ELECTRICAL OPTIONS

PEC photocell, button

H. CONTROL OPTIONS

GENI-XX energeni¹

SWP sitesync wireless
pre-commission^{3,4}

I. MOUNTING OPTIONS

PT post top

PM pendant mount²

J. COLOR

BBT basic black textured

BMT black matte textured

WHT white textured

MBT metallic bronze textured

BZT bronze textured

DBT dark bronze textured

GYS gray smooth

DPS dark platinum smooth

GNT green textured

MST metallic silver textured

MTT metallic titanium textured

OWI old world iron

RAL _____

¹ When ordering Energeni, specify the routine setting code (example GENI-04). See Energeni brochure and instructions for setting table and options. Not available with sensor options.

² consult factory

³ Must specify group and zone information at time of order. See www.hubbellighting.com/controls/sitesync for further details

⁴ Not available with other control or sensor options.

**SPECIFICATIONS****Intended Use:**

- The Beacon Windsor luminaire is available with a choice of different LED Wattage configurations and optical distributions designed to replace HID lighting up to 250W MH or HPS.

Construction:

- The electrical chamber/fitter shall be cast aluminum.
- Decorative fitter shall be designed to accommodate the driver assembly and shall be mounted to 3" OD x 3" H tenon and be secured by three or more stainless steel set screws.

Electrical:

- 100V through 277V, 50 Hz to 60 Hz (UNV)
- Power factor is ≥ 0.90 at full load
- All electrical components are rated at 50,000 hours at full load and 25°C ambient conditions per MIL- 217F Notice 2.
- One piece optical cartridge system consisting of an LED engine, LED lamps, optics, gasket and stainless steel bezel.
- Cartridge is held together with internal brass standoffs soldered to the board so that it can be field replaced as a one piece optical system.
- Silicone gasket ensures a weather-proof seal around each individual LED.
- Fixture electrical compartment shall contain all LED driver components.
- Rated ambient operating temperature -40°C to 40°C.
- Surge protection - 20KA
- Lifeshield™ Circuit - protects luminaire from excessive temperature. The device shall activate at a specific, factory-preset temperature, and progressively reduce power over a finite temperature range. Operation shall be smooth and undetectable to the eye. Thermal circuit is designed to "fail on", allowing the luminaire to revert to full power in the event of an interruption of its power supply, or faulty wiring connection to the drivers. The device shall be able to co-exist with other 0-10V control devices (occupancy sensors, external dimmers, etc.).

Controls/Options:

- Available with Energeni for optional set dimming, timed dimming with simple delay, or timed dimming based on time of night (see www.beaconproducts.com/products/energeni).
- London can be specified with SiteSync™ wireless control system for reduction in energy and maintenance cost while optimizing light quality 24/7. See ordering information or visit www.hubbellighting.com/products/sitesync

Finish:

- IFS polyester powder-coat electrostatically applied and thermocured.
- IFS finish consists of a five stage pretreatment regimen with a polymer primer sealer and top coated with a thermoset super TGIC polyester powder coat finish.
- The finish meets the AAMA 605.2 performance specification which includes passing a 3000 hour salt spray test for corrosion resistance and resists cracking or loss of adhesion per ASTM D522 and resists surface impacts of up to 160 inch-pounds.

Listings:

- Listed to UL8750 , UL1598 and CSA22.2#250.13-14 for wet locations

Warranty:

- Five year limited warranty (for more information visit: www.hubbellighting.com/resources/warranty)

Accessories and Services (Ordered Separately)

Catalog Number	Description
SWUSB*	SiteSync loaded on USB flash drive (Windows based only)
SWTAB*	SiteSync Windows Tablet
SWBRG*	SiteSync Wireless Bridge Node

*When ordering with SiteSync, one of the following interface options must be chosen and ordered separately. Each option contains the SiteSync License, GUI and Bridge Node.

+ If needed, an additional Bridge Node can be ordered.


PRECOMMISSIONED SITESYNC ORDERING INFORMATION: When ordering a fixture with the SiteSync lighting control option, additional information will be required to complete the order. The SiteSync Commissioning Form or alternate schedule information must be completed. This form includes Project location, Group information, and Operating schedules. For more detailed information please visit www.HubbellLighting.com/sitesync/ or contact Hubbell Lighting tech support at (800) 345-4928.

SiteSync fixtures with occupancy sensor (SWPM) require the mounting height of the fixture for selection of the lens.


Type:
Project Name:
Notes:

Sample AA-35 S 4 B P BBT
Ordering / / / / /
A B C D E F


DETAILS

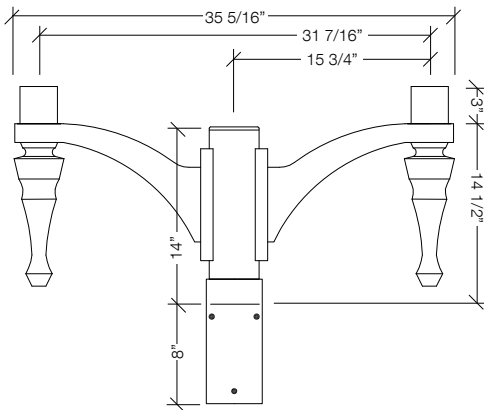

WALL BRACKET DETAILS

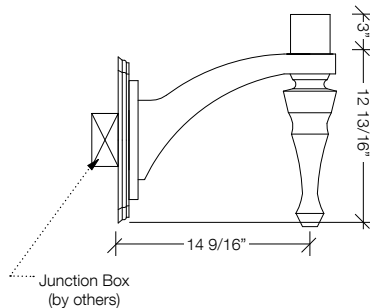

WALL PLATE DETAILS

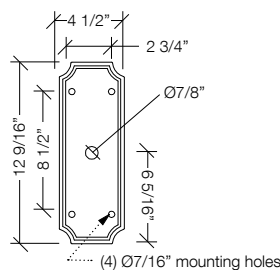

Due to our continued efforts to improve our products, product specifications are subject to change without notice.

A. MODEL

AA-35 Milano

B. POST SHAFT PROFILE

W wall mount

S smooth

F fluted

C. POST SHAFT DIAMETER

4 4"

5 5"

6 6"

OTHER _____

D. ARRANGEMENT

A see arrangement table below

E. LUMINAIRE MOUNTING

P pendant

F. COLOR

BBT basic black textured

BMT black matte textured

WHT white textured

MBT metallic bronze textured

BZT bronze textured

DBT dark bronze textured

GYS gray smooth

DPS dark platinum smooth

GNT green textured

MST metallic silver textured

MTT metallic titanium textured

OWI old world iron

RAL _____

Construction: All cast aluminum parts shall be low copper alloy A356. All extruded aluminum parts shall be alloy 6061-T6, 6063-T5 or equal.

EPA (effective projected area): EPA is de-fined as (projected surface area X drag factor) and measured in ft2. Allowable post, luminaire arm, luminaire and accessory EPAs are derived from the most current published AASHTO (American Association of State Highway and Transportation Officials) standard, currently AASHTO 2001 (50yr design life). Customer assumes all responsibility for selecting the appropriate post for installation (consult factory for assistance). Luminaire arm, luminaire and accessory EPA must be equal to or less than allowable EPA of post. Consult a professional engineer for compliance with local codes and standards.

Fasteners: All fasteners shall be Corrosion Resistant. When tamper resistant fasteners are required, spanner HD (snake eye) style shall be provided (special tool required, available at additional cost).

Finish: Finish shall be a Beacote V polyester powder-coat electro-statically applied and thermocured. Beacote V finish shall consist of a five stage iron phosphate chemical pretreatment regimen with a polymer primer sealer, oven dry off, and top coated with a thermoset super TGIC polyester powder coat finish. The finish shall meet the AAMA 605.2 performance specification which includes passing a 3000 hour salt spray test for corrosion resistance and resists cracking or loss of adhesion per ASTM D522 and resists surface impacts of up to 160 inch-pound.

Limited Warranty: Beacon Products warrants its products, to the original purchaser, against defects in materials and workmanship for proper usage for a period of 5 years after date of production, when properly installed, maintained and appropriately specified. See Warranty Information on www.beaconproducts.com for complete details and exclusions.

		arrangement (EPA index ft ² / weight (lbs))									
		A	B	C	D	E	F	G	H	I	J
shaft Ø											
wall	weight	10	-	-	-	-	-	-	-	-	-
Ø4"	EPA	-	1.14	1.88	1.88	1.51	2.11	2.11	2.11	2.62	2.62
	weight	-	16	23	24	23	30	31	30	37	38
Ø5"	EPA	-	1.24	1.98	1.98	1.61	2.21	2.21	2.21	2.72	2.72
	weight	-	18	25	26	25	32	33	32	39	40
Ø6"	EPA	-	1.34	2.08	2.08	1.71	2.31	2.31	2.31	2.82	2.82
	weight	-	20	27	28	27	34	35	34	41	42