FINAL DEVELOPMENT PLAN LINCOLN STREET CITY OF POWELL, DELAWARE COUNTY, OHIO

MARCH 2015

GENERAL SUMMARY

SITE LOCATION: LINCOLN STREET

POWELL, OH 43065

PARCEL:

3194602001000

1.051 AC. ORIGINAL (INCLUDING LINCOLN ST. & SCIOTO ST. R/W)

1.051 AC (45.781 S.F.) ORIGINAL

1.01 AC. (5,507 S.F.) DMIGINAL +0.091 AC. (3,977 S.F.) R/W SCIOTO ST. 1.016 AC. (44,251 S.F.) TOTAL LOT.

CURRENT ZONING:

DRB - DOWNTOWN BUSINESS DISTRICT

PRESENT USE:

PROPOSED PROJECT DESCRIPTION:
CONSTRUCTION OF 3 NEW OFFICE/WAREOUSE BUILDINGS.

BUILDINGS:

6,600 S.F BUILDING #1 2,100 S.F. BUILDING #2 8,700 S.F. TOTAL

19.7% LOT COVERAGE

EXISTING: 0 S.F IMPERVIOUS 0% 44,251 S.F PERVIOUS AREA 100%

PROPOSED: 31,479 S.F. IMPERVIOUS AREA 12,772 S.F. PERVIOUS AREA

SETBACKS: BUILDING & PARKING FRONT:25'

REAR:5 SIDE: 5'

PARKING.

1 PARKING SPACE FOR 200 S.F OF OFFICE SPACE / 2

BUILDING #1: 2,435 S.F. OFFICE SPACE / 200 / 2 = 6 PARKING SPACES 2 EMPLOYEES = 2 PARKING SPACES TOTAL = 8 PARKING SPACES

BUILDING #2: 644 S.F. OFFICE / 200 / 2 = 2 PARKING SPACES 1 EMPLOYEE = 1 PARKING SPACE TOTAL = 3 PARKING SPACE

TOTAL = 11 PARKING SPACES

LEGAL DESCRIPTION

SITUATED IN THE CTY OF POWELL, COUNTY OF DELAWARE, STATE OF OHIO, BEING OUT LOT NUMBER 1 AS RECORDED IN PLAT BOOK 2, PAGE 268, EXCEPTING A STRIP OF LAND 60 FEET WIDE OFF THE NROTH END OF SAID OUT LOT NUMBER 1, BEING MORE PARTICULARLY DESCRIBED AS FOLLOWS:

BEGINNING AT THE INTERSECTION OF THE CENTERLINE OF LINCOLN STREET AND THE CENTERLINE OF SCIOTO STREET;


THENCE NORTH 07 DEG. 14' 02" EAST, ALONG THE SAID CENTERLINE OF LINCOLN STREET, A DISTANCE OF 275.20 FEET TO A POINT, BEING 60.00 FEET SOUTH OF THE NORTHWEST CORNER OF SAID OUTLOT NUMBER 1

THENCE SOUTH 82 DEG. 38' 00" EAST, BEING 60.00 FEET FROM AND PARALLEL WITH THE NORTH LINE OF SAID OUTLOT NUMBER 1, (PASSING AN IRON PIPE FOUND AT 20.00 FEET) A TOTAL DISTANCE OF 110.45 FEET TO AN IRON PIPE FOUND, BEING ON THE WEST RIGHT OF WAY OF THE C&O RAILROAD,;

THENCE SOUTH 15 DEG. 03' 40" EAST, ALONG THE SAID WEST RIGHT OF WAY LINE OF THE CAO RAILROAD, A DISTANCE OF 296.25 FEET TO AN IRON PIPE SET, BEING IN THE SAID CENTERLINE OF SCIOTO STREET, ALL IRON PINS SET ARE SET WITH A PLASTIC CAP MARKED "SLSS RS 6612";

THENCE NORTH 82 DEG. 58" 48" WEST, ALONG THE SAID CENTERLINE OF SCIOTO STREET (PASSING A IRON PIPE SET AT 202.84 FEET) AT A TOTAL DISTANCE OF 222.84 FEET TO THE PLACE OF BEGINNING:

CONTAINING 1.051 ACRES, MORE OR LESS, FOR LAST DEED OF RECORD SEE DEED BOOK 382, PAGE 697 AS RECORDED IN THE DELAWARE COUNTY RECORDER'S OFFICE; SUBJECT TO ALL EASEMENTS, RESTRICTIONS AND RIGHTS OF WAY, IF ANY, OF RECORD.

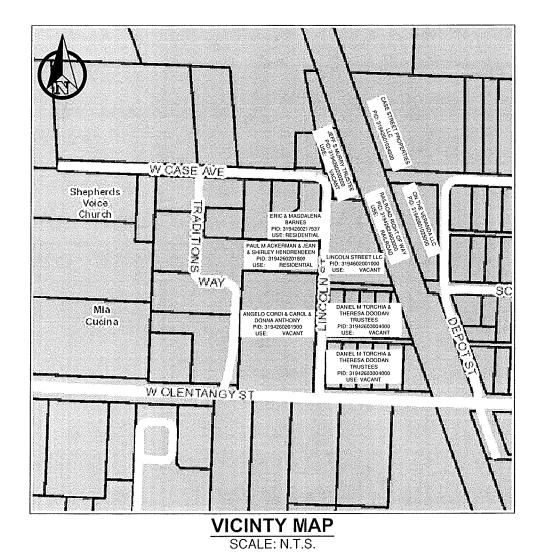

SHEET INDEX

TITLE SHEET EXISTING CONDITIONS, SITE & UTILITY PLAN GRADING & LIGHTING PLAN SECTION & AERIAL VIEWS
40' CONTAINER TRUCK EXHIBIT
53' TRAILER TRUCK EXHIBIT LANDSCAPE PLAN

OWNER/DEVELOPER

LINCOLN STREET, LLC BOX 1764 POWELL, OH 43065 PHONE: 614-888-0625 EMAIL: SEAN@CGSICORP.COM

ARCHITECT

CSR DESIGN CO. 2970 RUTHERFORD ROAD POWELL, OH 43065 CATHY RAMONDELLI PHONE: 614-309-6172 EMAIL: CSRDESIGNCO@GMAIL.COM

ENGINEER

GANDEE HEYDINGER GROUP 942 BROOKSEDGE BLVD. WESTERVILLE, OH 43081 PHONE: 614-942-6042 EMAIL: CWINKLE@GHGCIVIL.COM



642 Brooksedge Blvd. Westerville, OH 43081 P: 614.942.6042 F: 614 942 6041

PLAN PREPARED BY

LINCOLN STREET, LLC

LINCOLN STREET


POWELL / DELAWARE COUNTY


14-027-01 Drawing Number 1/6

Date:

Scale


CAW

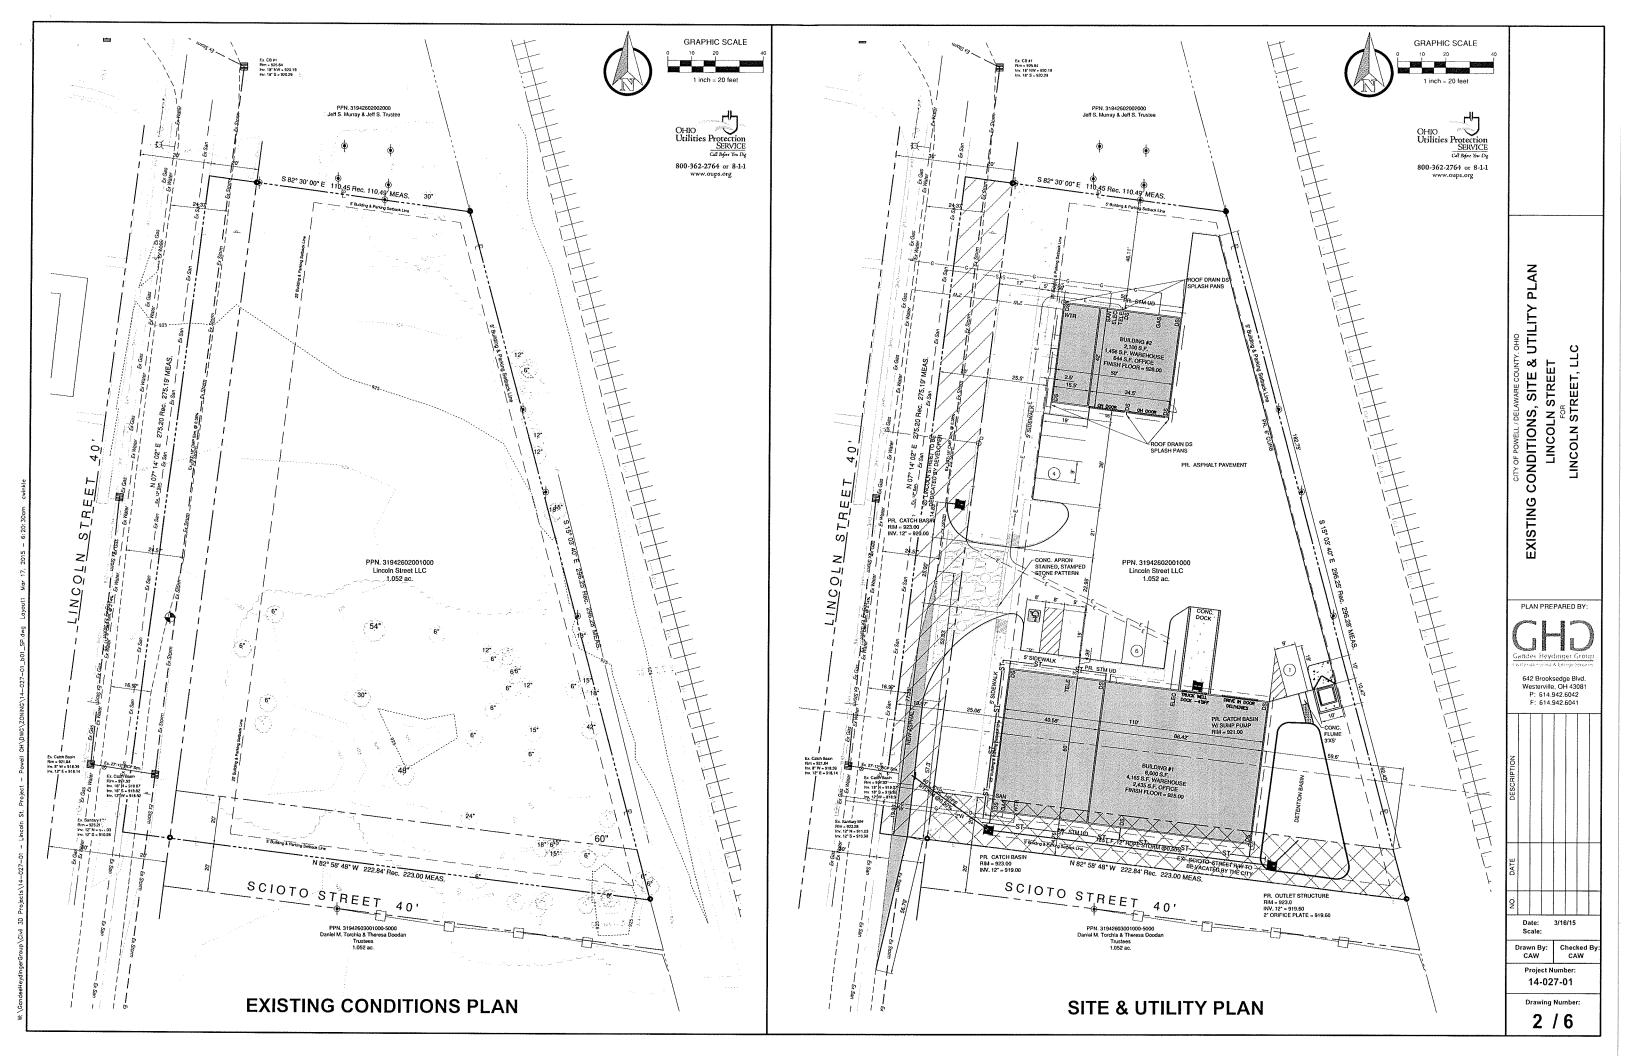

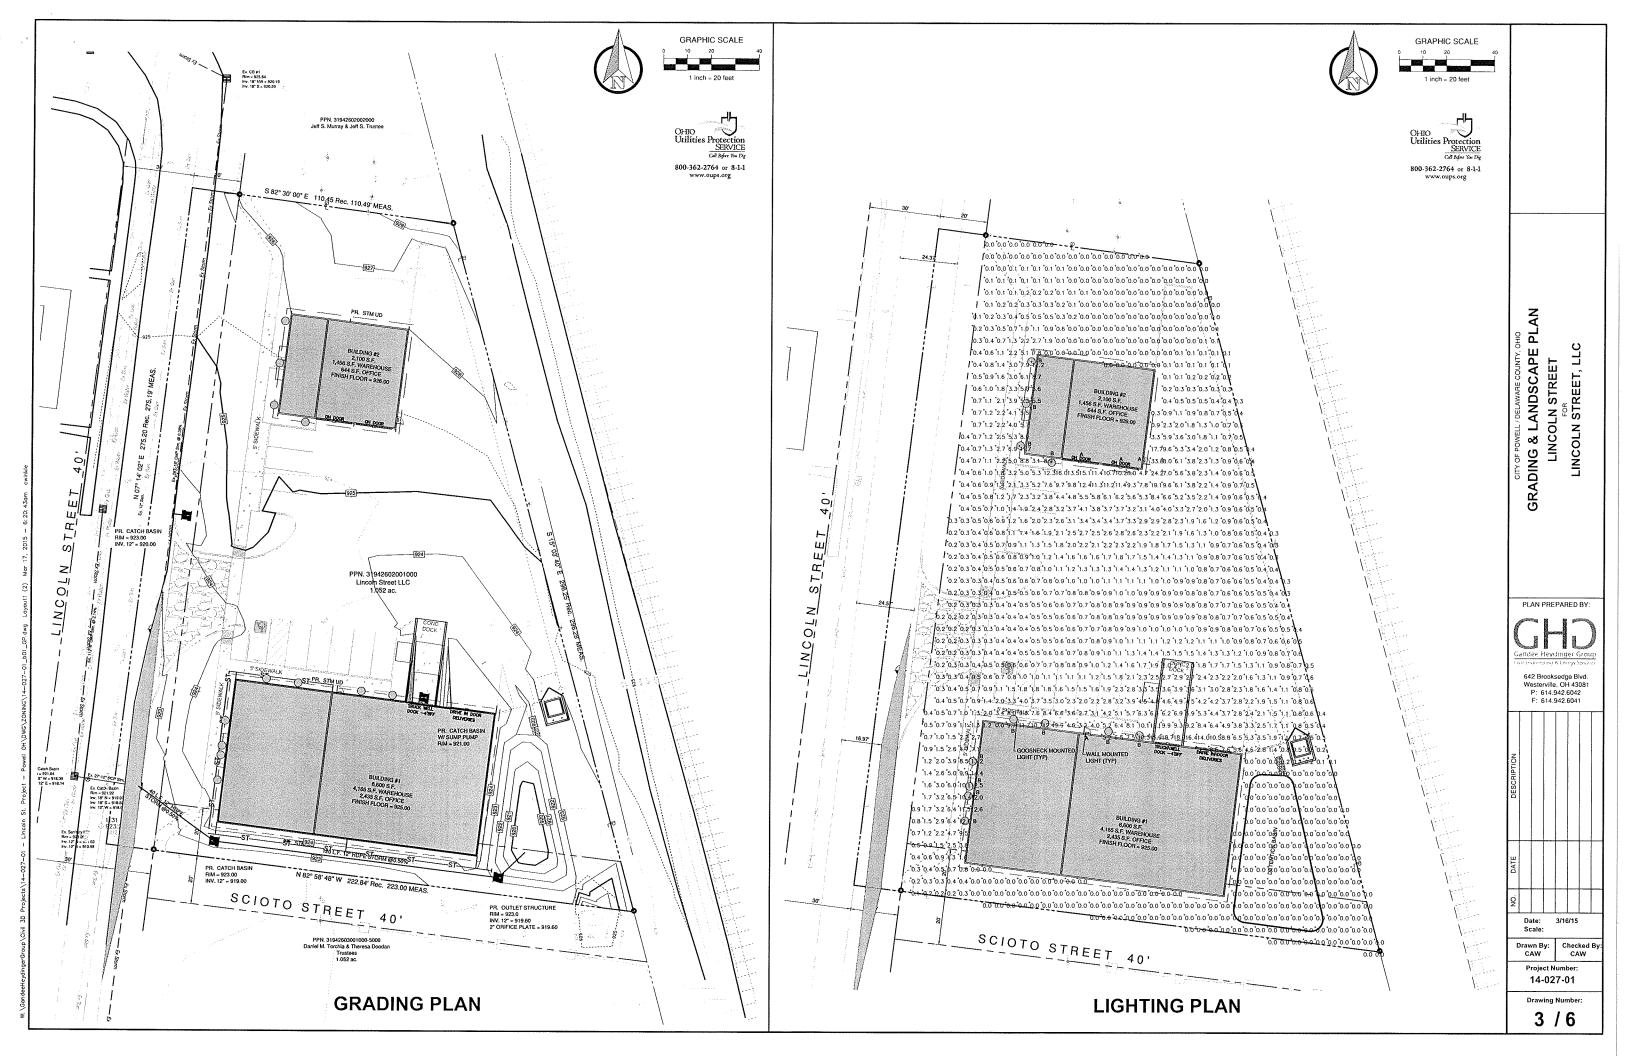



SECTION VIEW

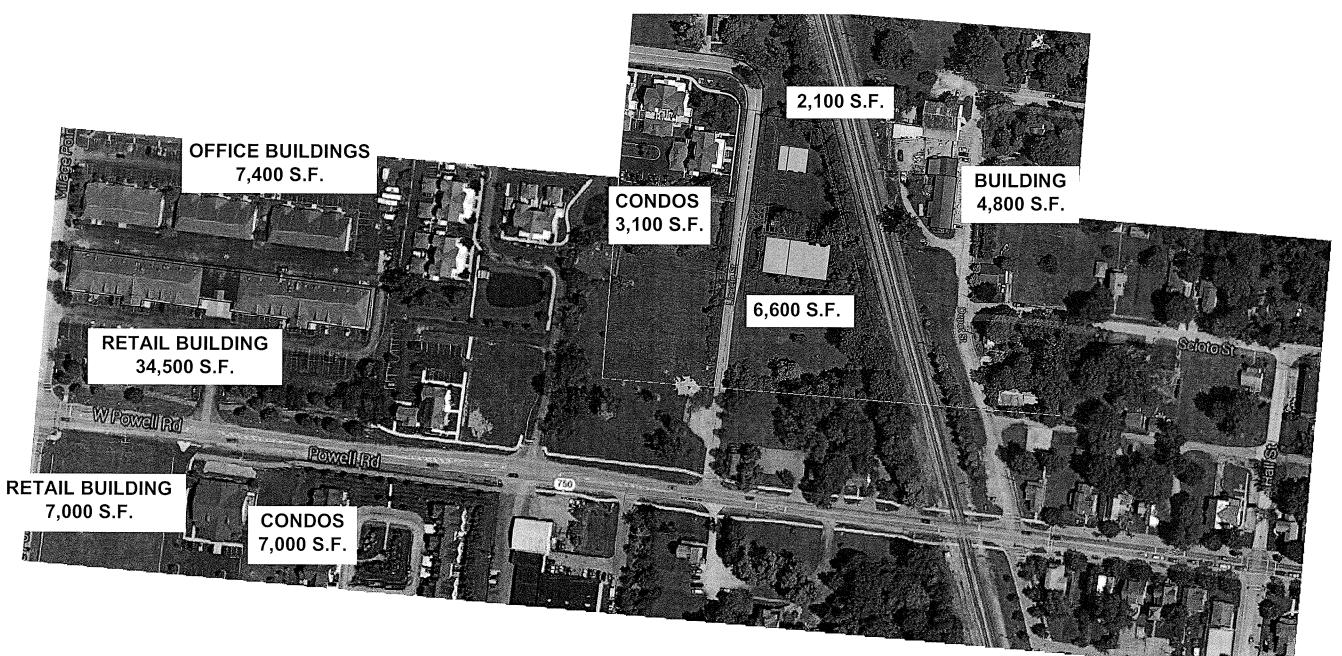

AERIAL VIEW

SECTION & AERIAL VIEWS
LINCOLN STREET

LINCOLN STREET

LINCOLN STREET

LINCOLN STREET, LLC

PLAN PREPARED BY:

Gandee Heydingei Group

642 Brooksedge Blvd. Westerville, OH 43081 P: 614.942.6042 F: 614.942.6041

DESCRIPTION				
DATE				
Ö.				


Date: 3/16/ Scale:

Drawn By: Checked B CAW CAW


14-027-01

Drawing Numbe


4/6

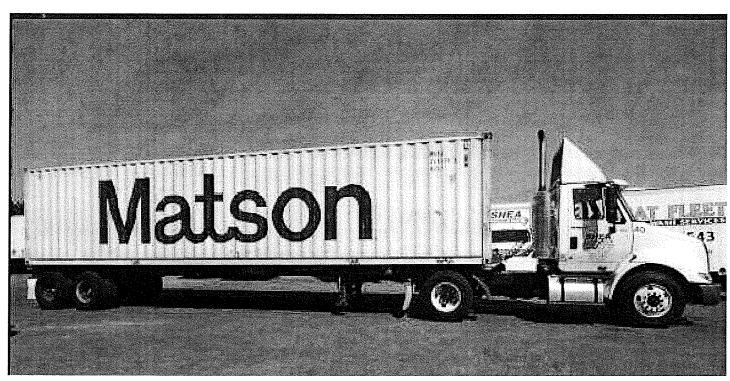

40' CONTAINER TRUCK

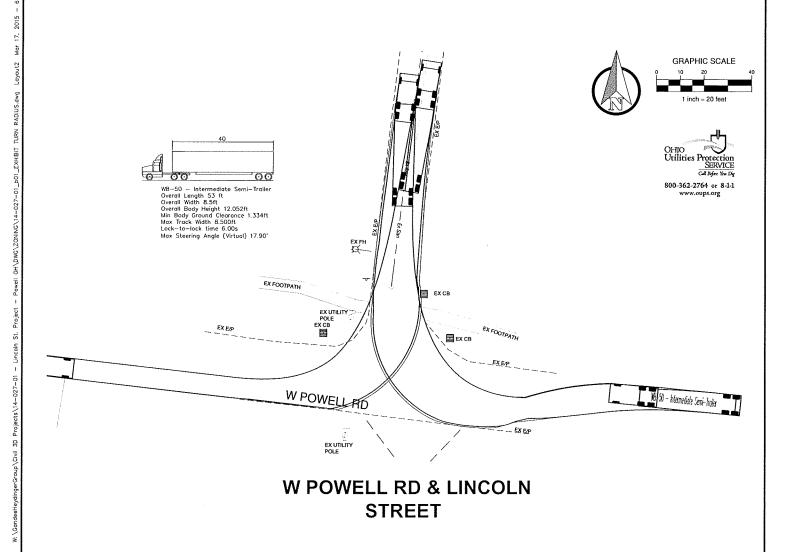



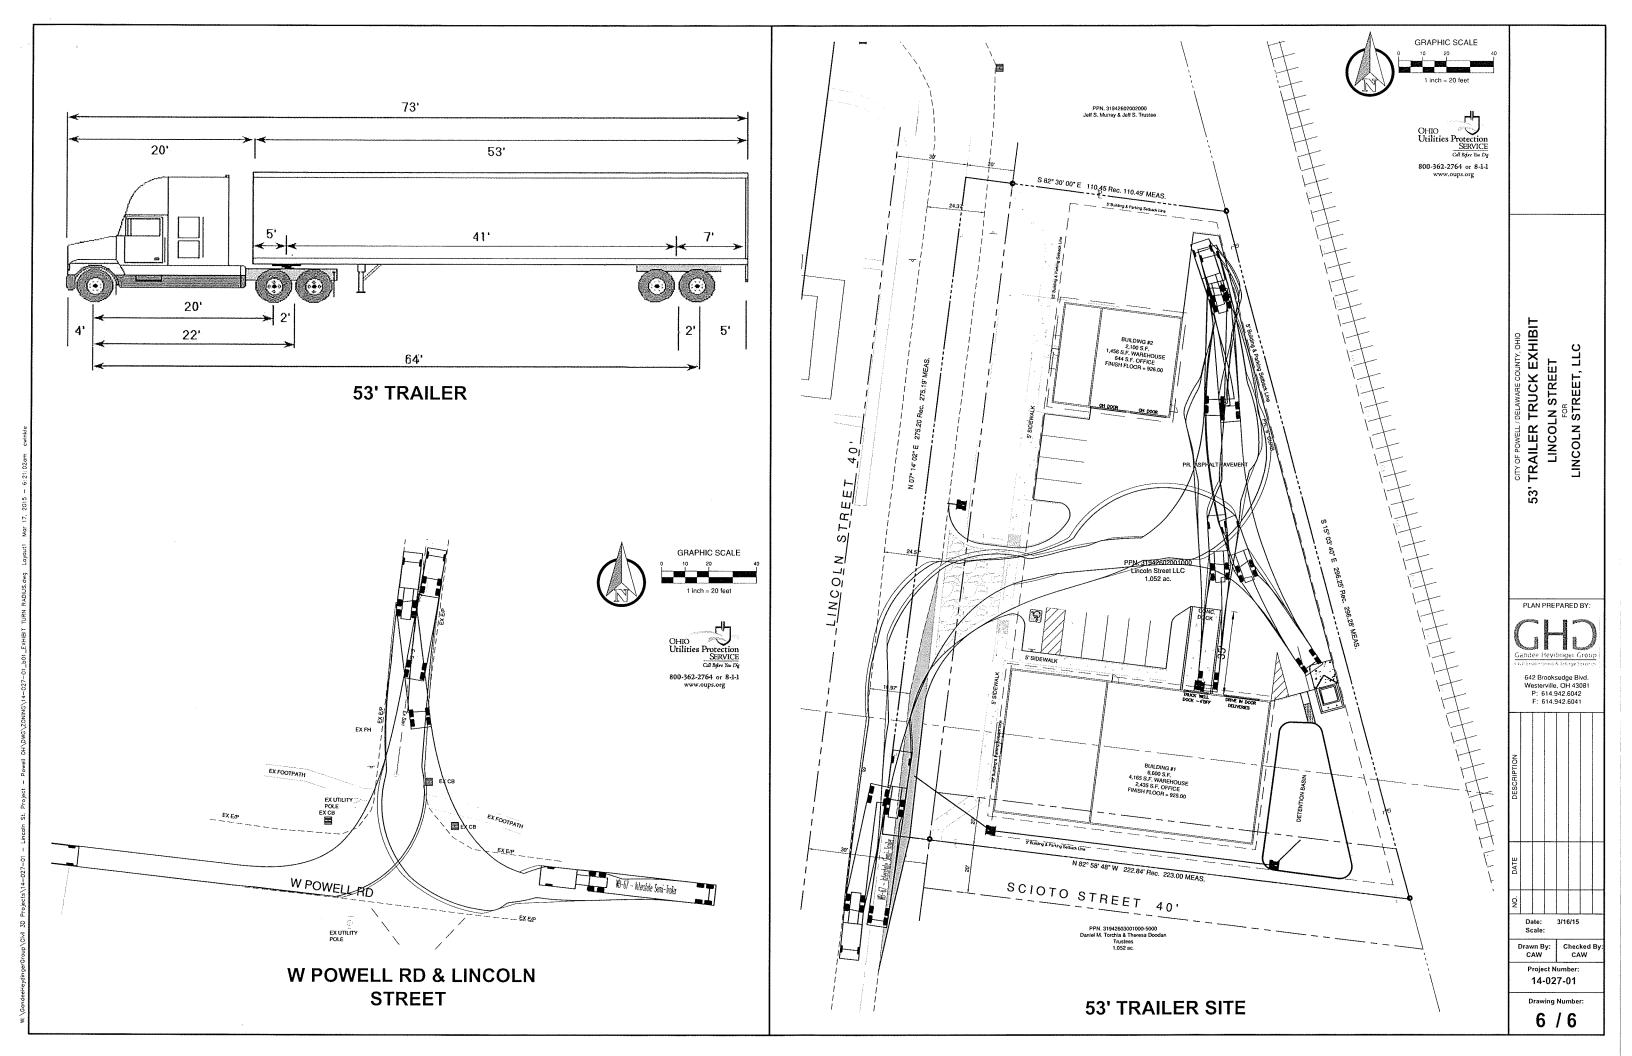

LANDSCAPE REQUIREMENTS

Replacement of Destroyed Trees.

(1) For every tree having a trunk diameter of six (6) inches or greater as measured twenty—four (24) inches from the ground level that is destroyed in the course of development or construction, new trees shall be planted on the subject site having a total trunk diameter of no less than six (6) inches as measured twenty—four (24) inches from the ground level. No single replacement planting shall have a trunk diameter of less than one-and-one half (1-1/2) inches as measured twenty—four (24) inches from the ground level.

Total trees removed = (28) 6" and over Total replacement required = 168" as described Total replacement provided = 168" (56) 3" cal. trees

Minimum Tree Requirements

All commercial structures, including commercial-related parking, loading and trash storage areas, and all industrial, warehouse, and storage uses and their associated parking, loading, and trash storage areas up to 20,000 square feet: 2" trunk diameter for every 2,000 square feet or fraction thereof, beginning with a minimum of 3" of total trunk diameter: 8.001 sf to 10,000 sf = 11" per 2,000sf

Total building area = 8,700 sf (8,300 / 2,000) * 11"Total required trees = equaling 48"

Total provided trees = (see below existing 108")

(b) No new tree plantings shall be required if existing trees to remain on the site after development, and the aggregate trunk sizes of such trees, meet or exceed the requirements as set forth above. The minimum tree trunk diameter as measured twenty-four (24) inches from the ground level for such existing trees remaining on the finished site shall be no less than one and one — half (1-1/2) inches.

TREE PRESERVATION DETAIL

Total ex. tree caliper inches to remain = 108" of cal.

Required Landscaping of Parking Areas Every parking aisle that is bounded at an end by a traffic lane shall be terminated at such traffic lanes by such a

"planting bay." Planting bays provided with plantings

Required Landscaping around Building Foundations

At a minimum, at least seventy percent (70%) of the lineal footage around the perimeter of a structure shall be landscaped in this manner. Shrubs or hedges shall be grouped rather than spaced as single shrubs at regular distances. A minimum of five shrubs shall be planted in every forty (40) feet of lineal building perimeter. A minimum of ten (10) perennial or annual plants and/or flowers shall be planted in every forty (40) feet of linear

Total building foundation (both buildings) = 520 If Total foundation planting required = $(520 \cdot .7) = 364$ If Total foundation planting provided = 364 If

Total shrubs required = (364 / 40) * 5 = 46Total shrubs provided = 49

Total perennials required = $(364 / 40) \cdot 10 = 92$ Total perennials provided = 92


For trash containers and receptacles in commercial, office, ror trash containers and receptacles in commercial, office and industrial districts for multi-family residential developments in any district, trash containers and refuse areas shall be adequately screened from sight by walls, fences, landscaping materials or an acceptable combinatio of these elements, provided that:

The height of such walls, fences or landscaping is no less than six (6) feet and the height of walls and fences does not exceed 10'

Screening provided by walled structure min. 6' height. See

SYMBOL	QUAN.	BOTANICAL NAME COMMON NAME	SIZE		COMMENTS	
+	23	SEDUM "AUTUMN JOY" AUTUMN JOY SEDUM	1 GAL	CONT	FALL BLOOM	
3	38	CALAMAGROSTIS A. 'KARL FORESTER' KARL FORESTER FEATHER REED	1 GAL	CONT DENSE FULL CLUMP		
0	26	HEMEROCALIS 'STELLA D ORO' STELLA D ORO DAYULY	1 GAL	CONT	PURPLE BLOOM	
;	33	HOSTA FRANCES WELLAMS FRANCES WELLAMS HOSTA	1 GAL	CONT	BLUE/YELLOW FOLIAGE	
O	16	SPIREA X. B. 'GOLD FLAME' GOLD FLAME SPIREA	18" HT/SPR	CONT	YELLOW/ORANGE FOLIAGE	
⅌	08	PRUNS X CISTENA PURPLELEAF SANDCHERRY	48" HT/SP	CONT	PINK FLOWERS	
0	12	JUNIPERUS SABINA 'BROADMOOR' BROADMOOR JUNIPER	24*HT/SPR	CONT	DENSE EVERGREEN FOLIAGE	
0	13	TAXUS X M. DENSIFORMIS DENSE YEW	24" HT/SPR		PLANTED 5' O.C.	
\bigcirc	11	CERCIS CANADENSIS EASTERN REOBUD	3" CAL	В&В	6' CLEAR BELOW CANOPY.	
	21	ACER RUBRUM 'OCTOBER GLORY' OCTOBER GLORY RED MAPLE	3" CAL.	8 & B	6' CLEAR BELOW CANOPY.	
*	17	GLEDITSIA TRI. I. 'IMPERIAL' IMPERIAL HONEYLOCUST	3" CAL	8 & 8	6' CLEAR BELOW CANOPY.	
	07	ZELKOVA S. VAR. 'GREEN VASE' GREEN VASE ZELKOVA	3" CAL	В&В	6' CLEAR BELOW CANOPY.	
		TREE PRESERVATION FENCING RECHIRED FOR NOTED TREES	4' HEIGHT	В	SEE DETAIL BELOW	

SHRUB PLANTING

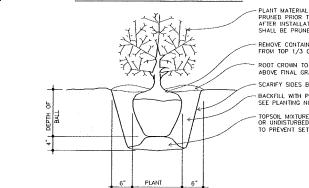

TREE PRESERVATION NOTES

A. THE CONTRACTOR SHALL BE RESPONSIBLE FOR THE CONSTRUCTION, ERECTION AND MAINTENANCE OF TEMPORARY FENCING AROUND TREE PRESERVATION AREAS, SO THAT ALL PROTECTED TREES SHALL BE PRESERVED.

B. TREE PROTECTION FENCING SHALL BE ORANGE PLASTIC SAFETY FENCE, MINIMUM OF 4' HEIGHT, SECURED WITH 4"X4" PRESSURE TREATED STAKES, INISTALED 3' BEYOND THE EDGE OF THE ROOT ZONE, OR AS INDICATED ON THE PLAN.

C. FENCING SHALL REMAIN IN PLACE, AND BE SECURED IN AN UPRIGHT POSITION DURING THE ENTIRE CONSTRUCTION PERIOD TO PREVENT THE IMPINCEMENT OF CONSTRUCTION VEHICLES, MATERIALS, AND EQUIPMENT INTO OR UPON THE TREE PRESERVATION AREA.

D. APPROVED SIGNS SHALL BE ATTACHED TO PROTECTION FENCING, AND VISIBLY STATING THAT INSIDE THE FERCING IS A TREE PROTECTION ZONE, NOT TO BE DISTURBED UNLESS PRIOR APPROVAL HAS BEEN OBTAINED.

E. THE APPROVED TREE PRESERVATION PLAN SHALL BE AVAILABLE ON THE BUILDING SITE BEFORE WORK COMMENCES, AND AT ALL TIMES DURING CONSTRUCTION OF THE PROJECT.

F. DURING ALL PHASES OF CONSTRUCTION, ALL STEPS TO PREVENT THE DESTRUCTION OR DAMAGE TO PROTECTED TREES SHALL BE TAKEN. NO CONSTRUCTION ACTIVITY, MOVEMENT AND/OR PLACEMENT OF EQUIPMENT, VEHICLES, MATERIALS OR SPOILS STORAGE SHALL BE PERMITTED WITHIN THE TREE PRESERVATION AREA. NO EXCESS SOIL, ADDITIONAL FILL, LIQUIDS, OR CONSTRUCTION DEBRIS SHALL BE PLACED WITHIN THE CRITICAL ROOT ZONE OF ALL TREES THAT ARE TO BE


G. PROTECT THE CROWN AND TRUNK OF TREES TO BE RETAINED BY OPERATING EQUIPMENT IN SUCH A WAY TO AVOID CONTACT WITH TREE TRUCKS, OR BRANCHES.

I. NO ATTACHMENTS, INCLUDING BUT NOT LIMITED TO ROPES, NAILS, ADVERTISING POSTERS, SIGNS FENCES, OR WIRES (OTHER THAN THOSE USED FOR BRACING, GUYING OR WRAPPING) SHALL BE ATTACHED TO ANY TREES.


J. NO GASEOUS LIQUIDS OR SOLID SUBSTANCES WHICH ARE HARMFUL TO TREES SHALL BE PERMITTED WITHIN THE TREE PRESERVATION AREA.


K. NO FIRE OR HEAT SHALL BE PERMITTED WITHIN THE TREE PRESERVATION AREA.

L. ALL UTILITIES, INCLUDING SERVICE LINES, SHALL BE INSTALLED IN ACCORDANCE WITH THE TREE PRESERVATION PLAN.

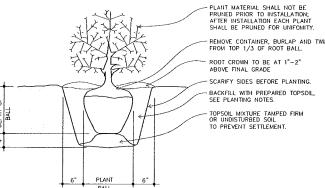

TREE PLANTING

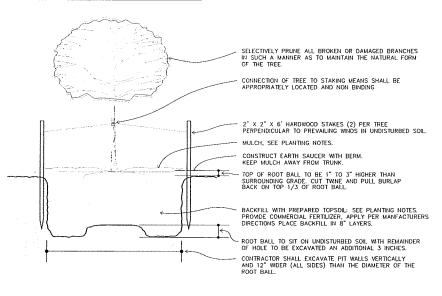

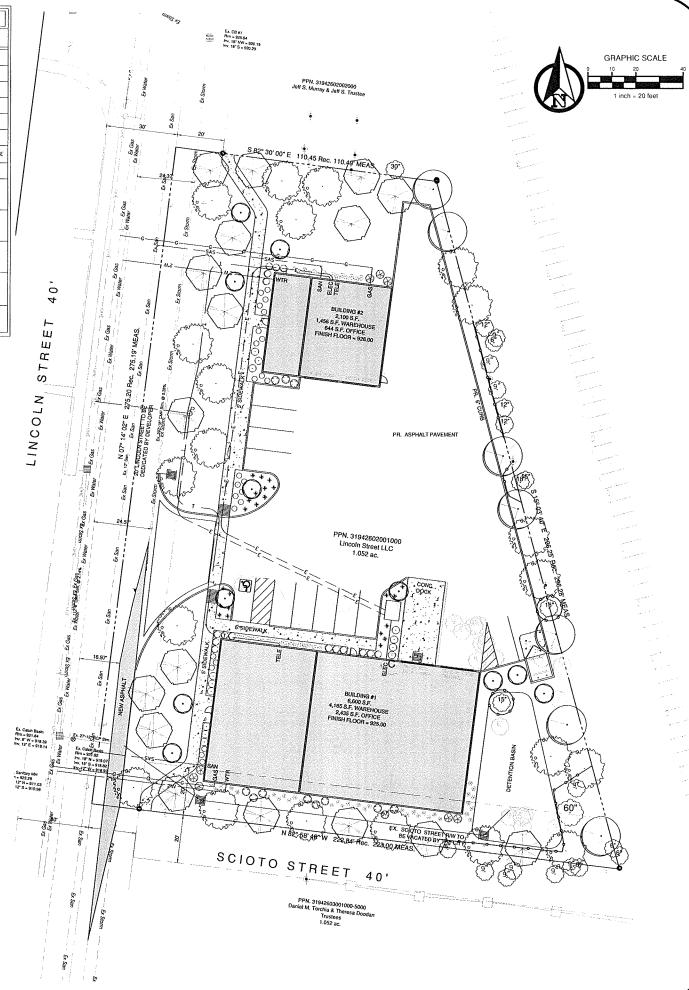




GR. OHO Š ∞ POWELL Ś COLN Ž Ø

> nOT AP Q ∞ AND LAN 屲

L-1

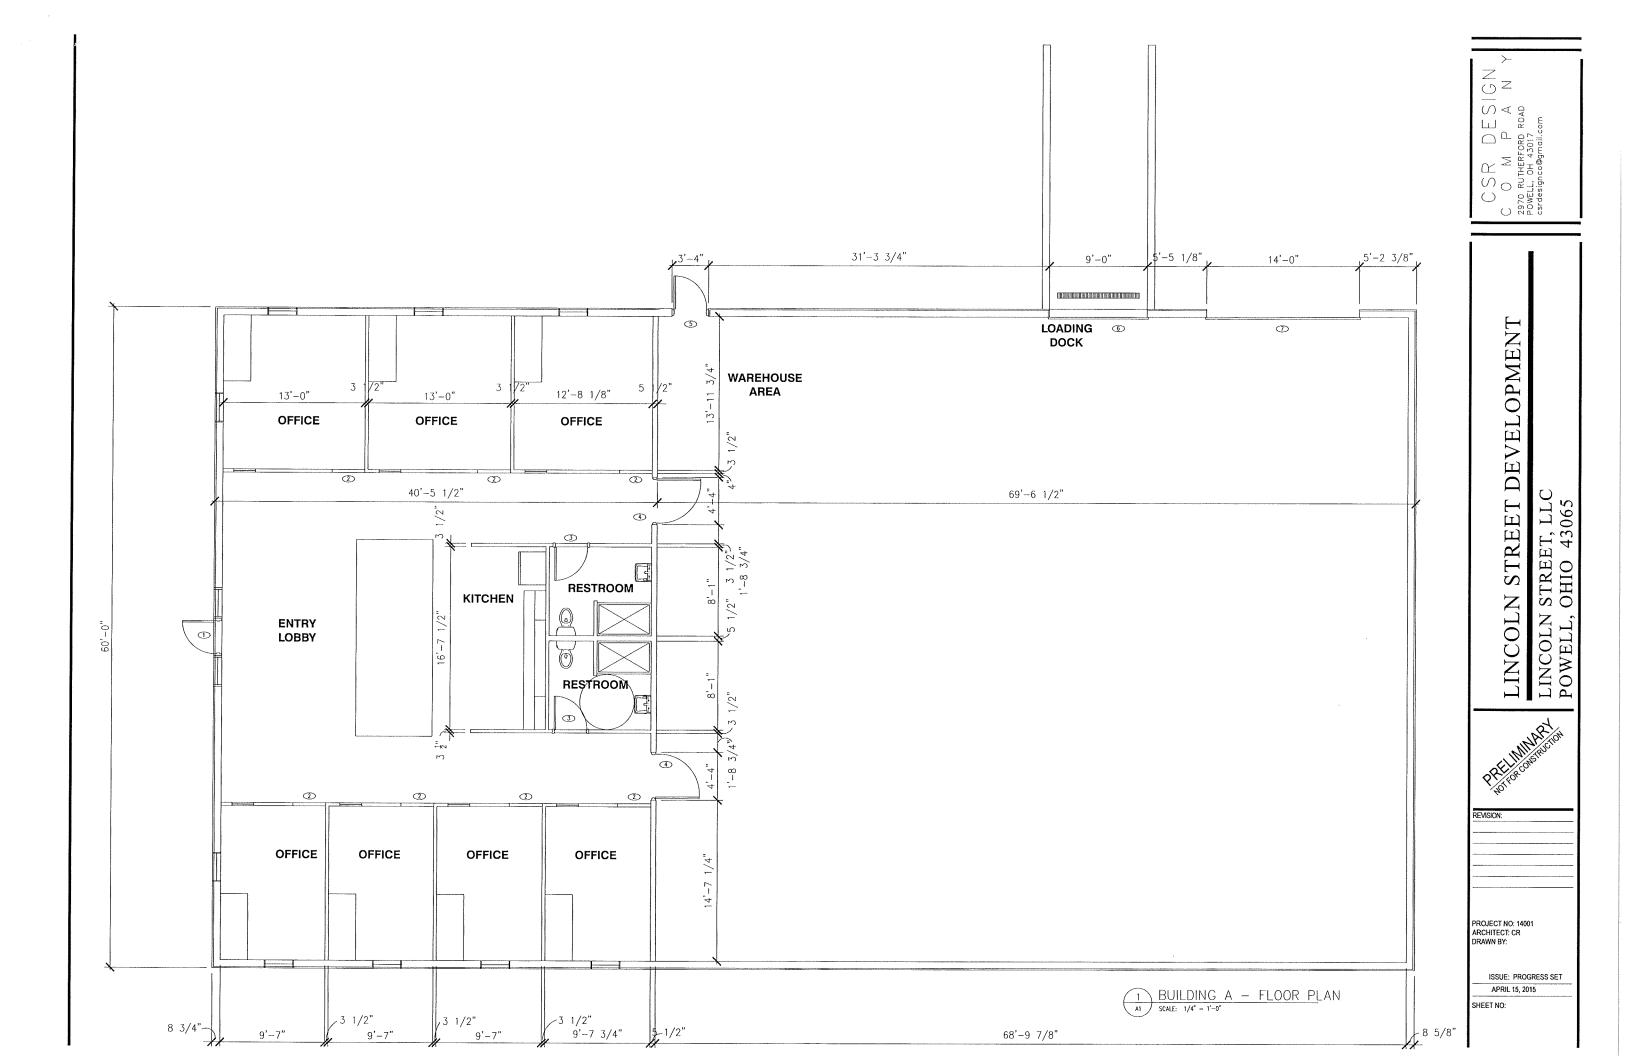

1 BUILDING B - FLOOR PLAN
A2 SCALE: 1/4" = 1'-0"

LINCOLN STREET DEVELOPMENT LINCOLN STREET, LLC POWELL, OHIO 43065

CSR DESIGN
C O M P A N Y
2970 RUTHERFORD ROAD
POWELL, OH 43017
csrdesignco@gmail.com

IT TI

REVISION:

PROJECT NO: 14001 ARCHITECT: CR DRAWN BY:

> ISSUE: PROGRESS SET APRIL 15, 2015

SHEET NO:

STREET DEVELOPMENT

S Z

ES S (

CSRDE 2970 RUTHERFORD R. POWELL, OH 43017 csrdesignco@gmail.cor

LINCOLN STREET, LLC POWELL, OHIO 43065 LINCOLN

REVISION:


PROJECT NO: 14001 ARCHITECT: CR DRAWN BY:

ISSUE: PROGRESS SET APRIL 15, 2015

SHEET NO:

1 BUILDING ELEVATION

SCALE: 1/4" = 1"-0"

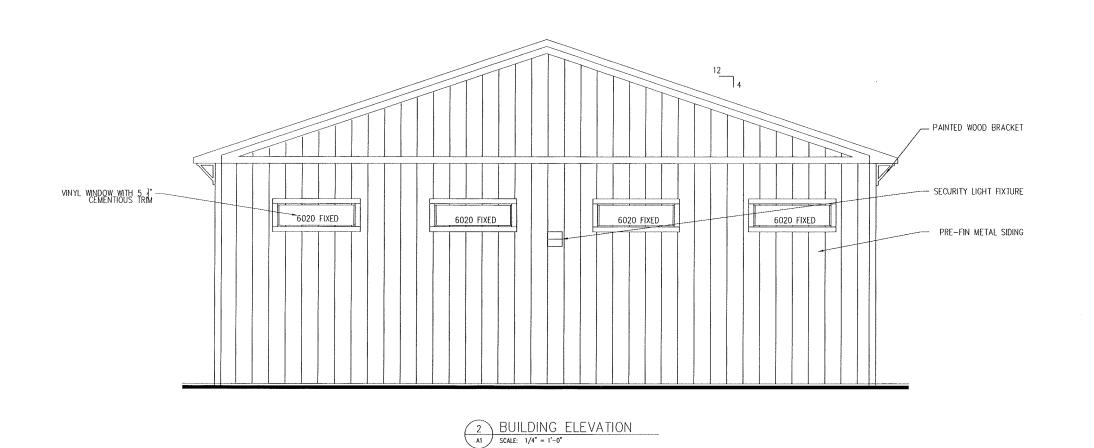

BATTEN SEAM METAL ROOF— PRE-FINISHED GOOSENECK LIGHT FIXTURE 12______10 PAINTED WOOD BRACKET -PRE-FIN METAL SIDING - PAINTED WOOD BRACKET SECURITY LIGHT FIXTURE 6020 FIXED 6020 FIXED 6020 FIXED CEMENTIOUS TRIM 6020 FIXED 6020 FIXED 6020 FIXED 2850 2850 2850 VERTICAL CEMENTIOUS SIDING BUILDING ELEVATION — VINYL WINDOW WITH 5 ½" CEMENTIOUS TRIM PANEL (BARN DOOR) PRE MANUF METAL SCALE: 1/4" = 1'-0"

STREET DEVELOPMENT LINCOLN


CSR DESIGN
C O M P A N Y
2970 RUTHERFORD ROAD
POWELL, OH 43017
csrdesignco@gmail.com

STREET, LLC OHIO 43065 LINCOLN S

REVISION:

PROJECT NO: 14001 ARCHITECT: CR DRAWN BY:

ISSUE: PROGRESS SET APRIL 15, 2015 SHEET NO:

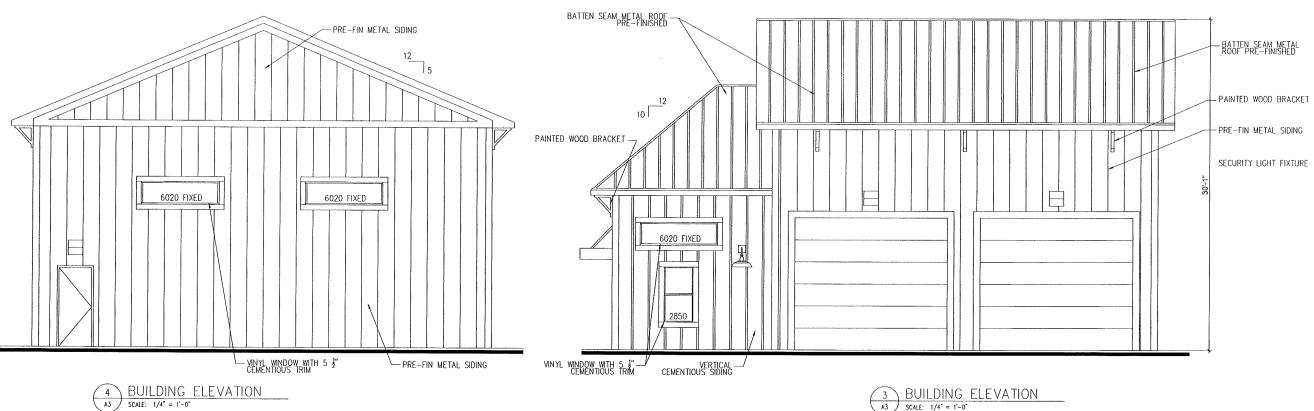


BATTEN SEAM METAL ROOF PRE-FINISHED 6020 FIXED 6020 FIXED 6020 FIXED PRE-FIN METAL SIDING ---CEMENTIOUS TRIM-VERTICAL CEMENTIOUS SIDING VINYL WINDOW WITH 5 1 CEMENTIOUS TRIM

BUILDING ELEVATION

BUILDING ELEVATION

A3 SCALE: 1/4" = 1'-0"

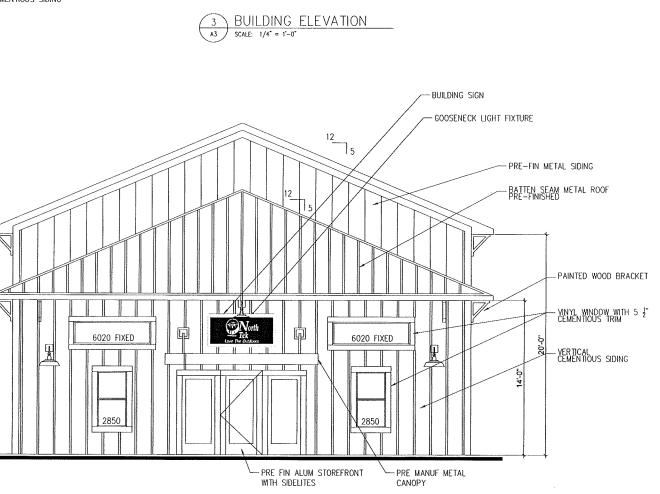

STREET DEVELOPMENT LINCOLN

STREET, LLC OHIO 43065

 $\frac{\sigma}{Z}$

E S ROAD

CSRDE COMP 2970 RUTHERFORD R POWELL, OH 43017 csrdesignco@gmail.con

LINCOLN POWELL,

PROJECT NO: 14001 ARCHITECT: CR DRAWN BY:

ISSUE: PROGRESS SET APRIL 15, 2015

SHEET NO: